

SIENT RIAL DRIVE

DRAWN BY: R
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REV: 16.0 / 10-7-2016
DESCRIPTION OF CHANGE(S):
APPROVAL DRAWING
INITIAL RELEASE

DRAWING TITLE:
SYSTEM INDEX
ISOMETRIC
DRAWING

R2016151

EQUIP. NO:

SYSTEM INDEX
SHEET NO:

0

(1) EA. 2-STAGE INLINE PRE-TREATMENT WASHER (1) EA. NG FIRED CONVECTION DRY-OFF OVEN

(1) EA. INLINE PROCESS POWDER BOOTH (1) EA. AUTO POWDER GUN PACKAGE WITH RECIPROCATORS, ROTARY SIEVE AND HOPPER


1500LBS PART LOWERATOR

(1) EA. NG FIRED CONVECTION CURE OVEN


(1) INTEGRAL EQUIP. & FLOOR MOUNT CONVEYOR SUPPORT STRUCTURE.


(1) EA. POWER AND FREE CONVEYOR SYSTEM

WARE PACKAGE: 12" W X 168" T X 12" L WITH 30" KEY, MAX LOAD: 500#, MAX LINEAR LOAD: 100 #/FT. DESIGN CAPACITY: 15,000/HR.

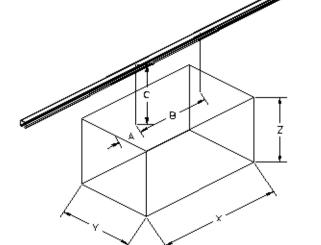

CONVE	YOR PART	WARE PACKAGE
TAG	DIM. INCHES	NOTES
Α	6	Use dim A only fo single honger
8		port hanger spacir
С	30	Dim. from part to T.
×	12	Part length paralli conveyor
Y	12	Part width
Z	168	Port heigth

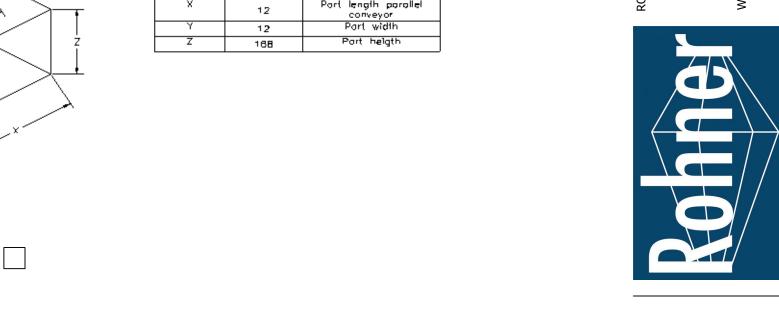

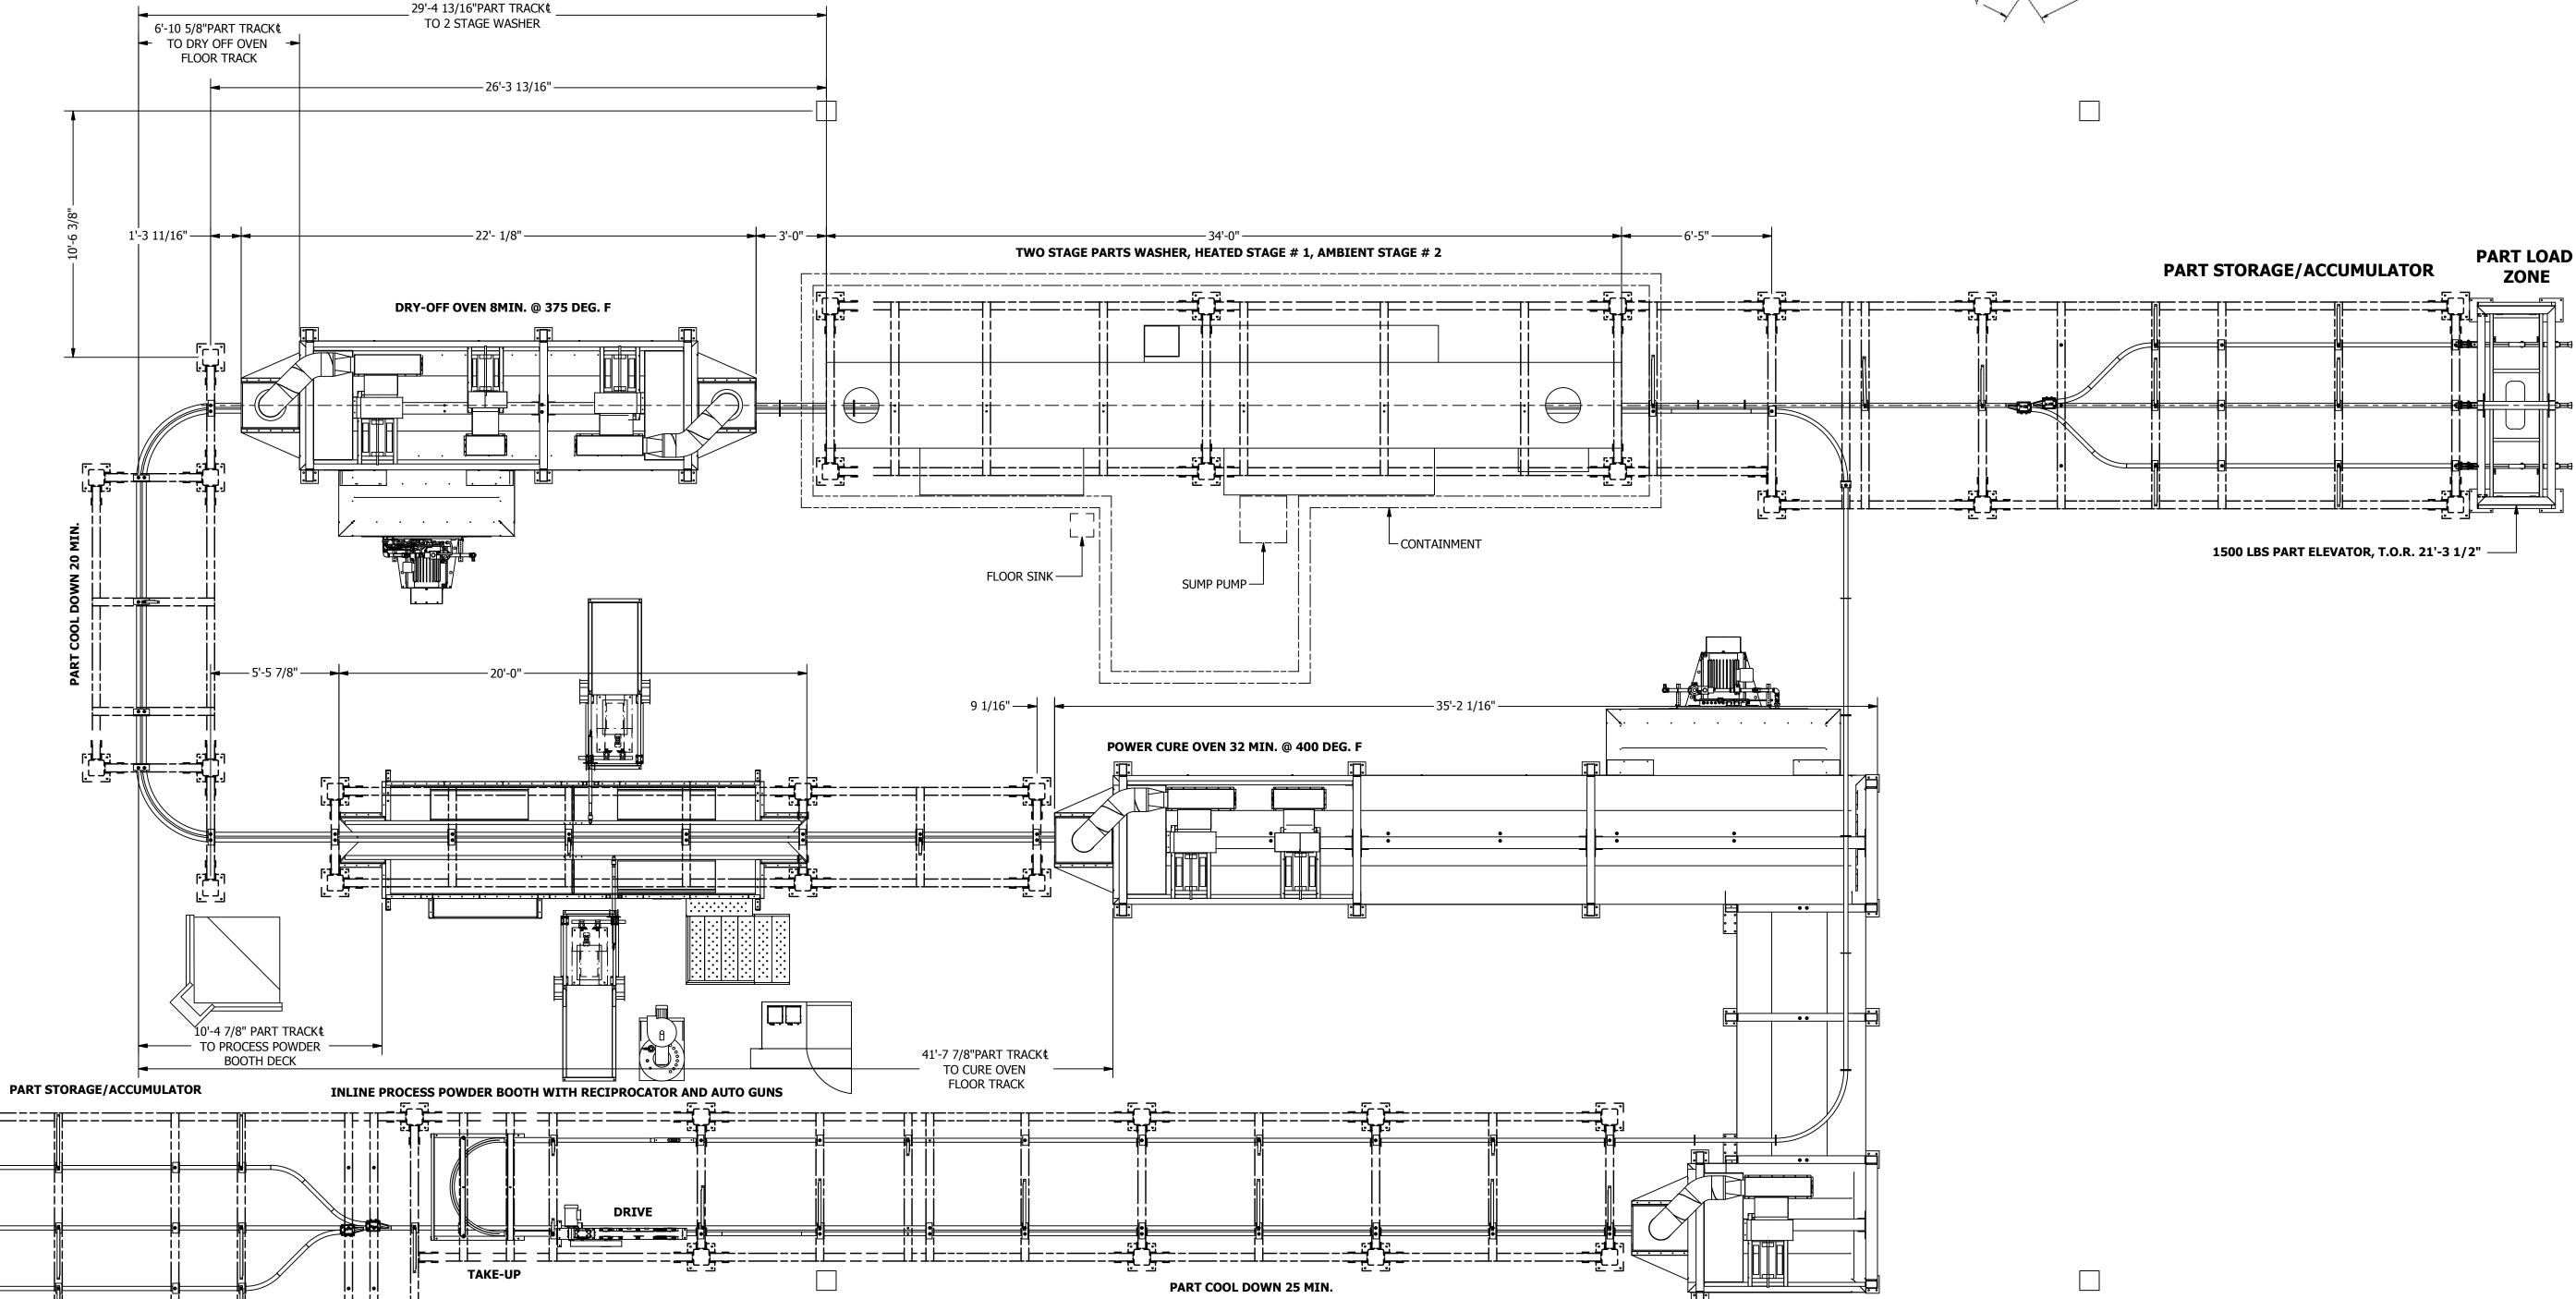

APPROVED FOR CONSTRUCTION


R2016151 SYSTEM LAYOUT

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DESCRIPTION OF CHANGE(S): UPDATED PER RICHARDS-WILCOX

DRAWING TITLE: SYSTEM LAYOUT ISOMETRIC DRAWING

CONVEYOR TRACK

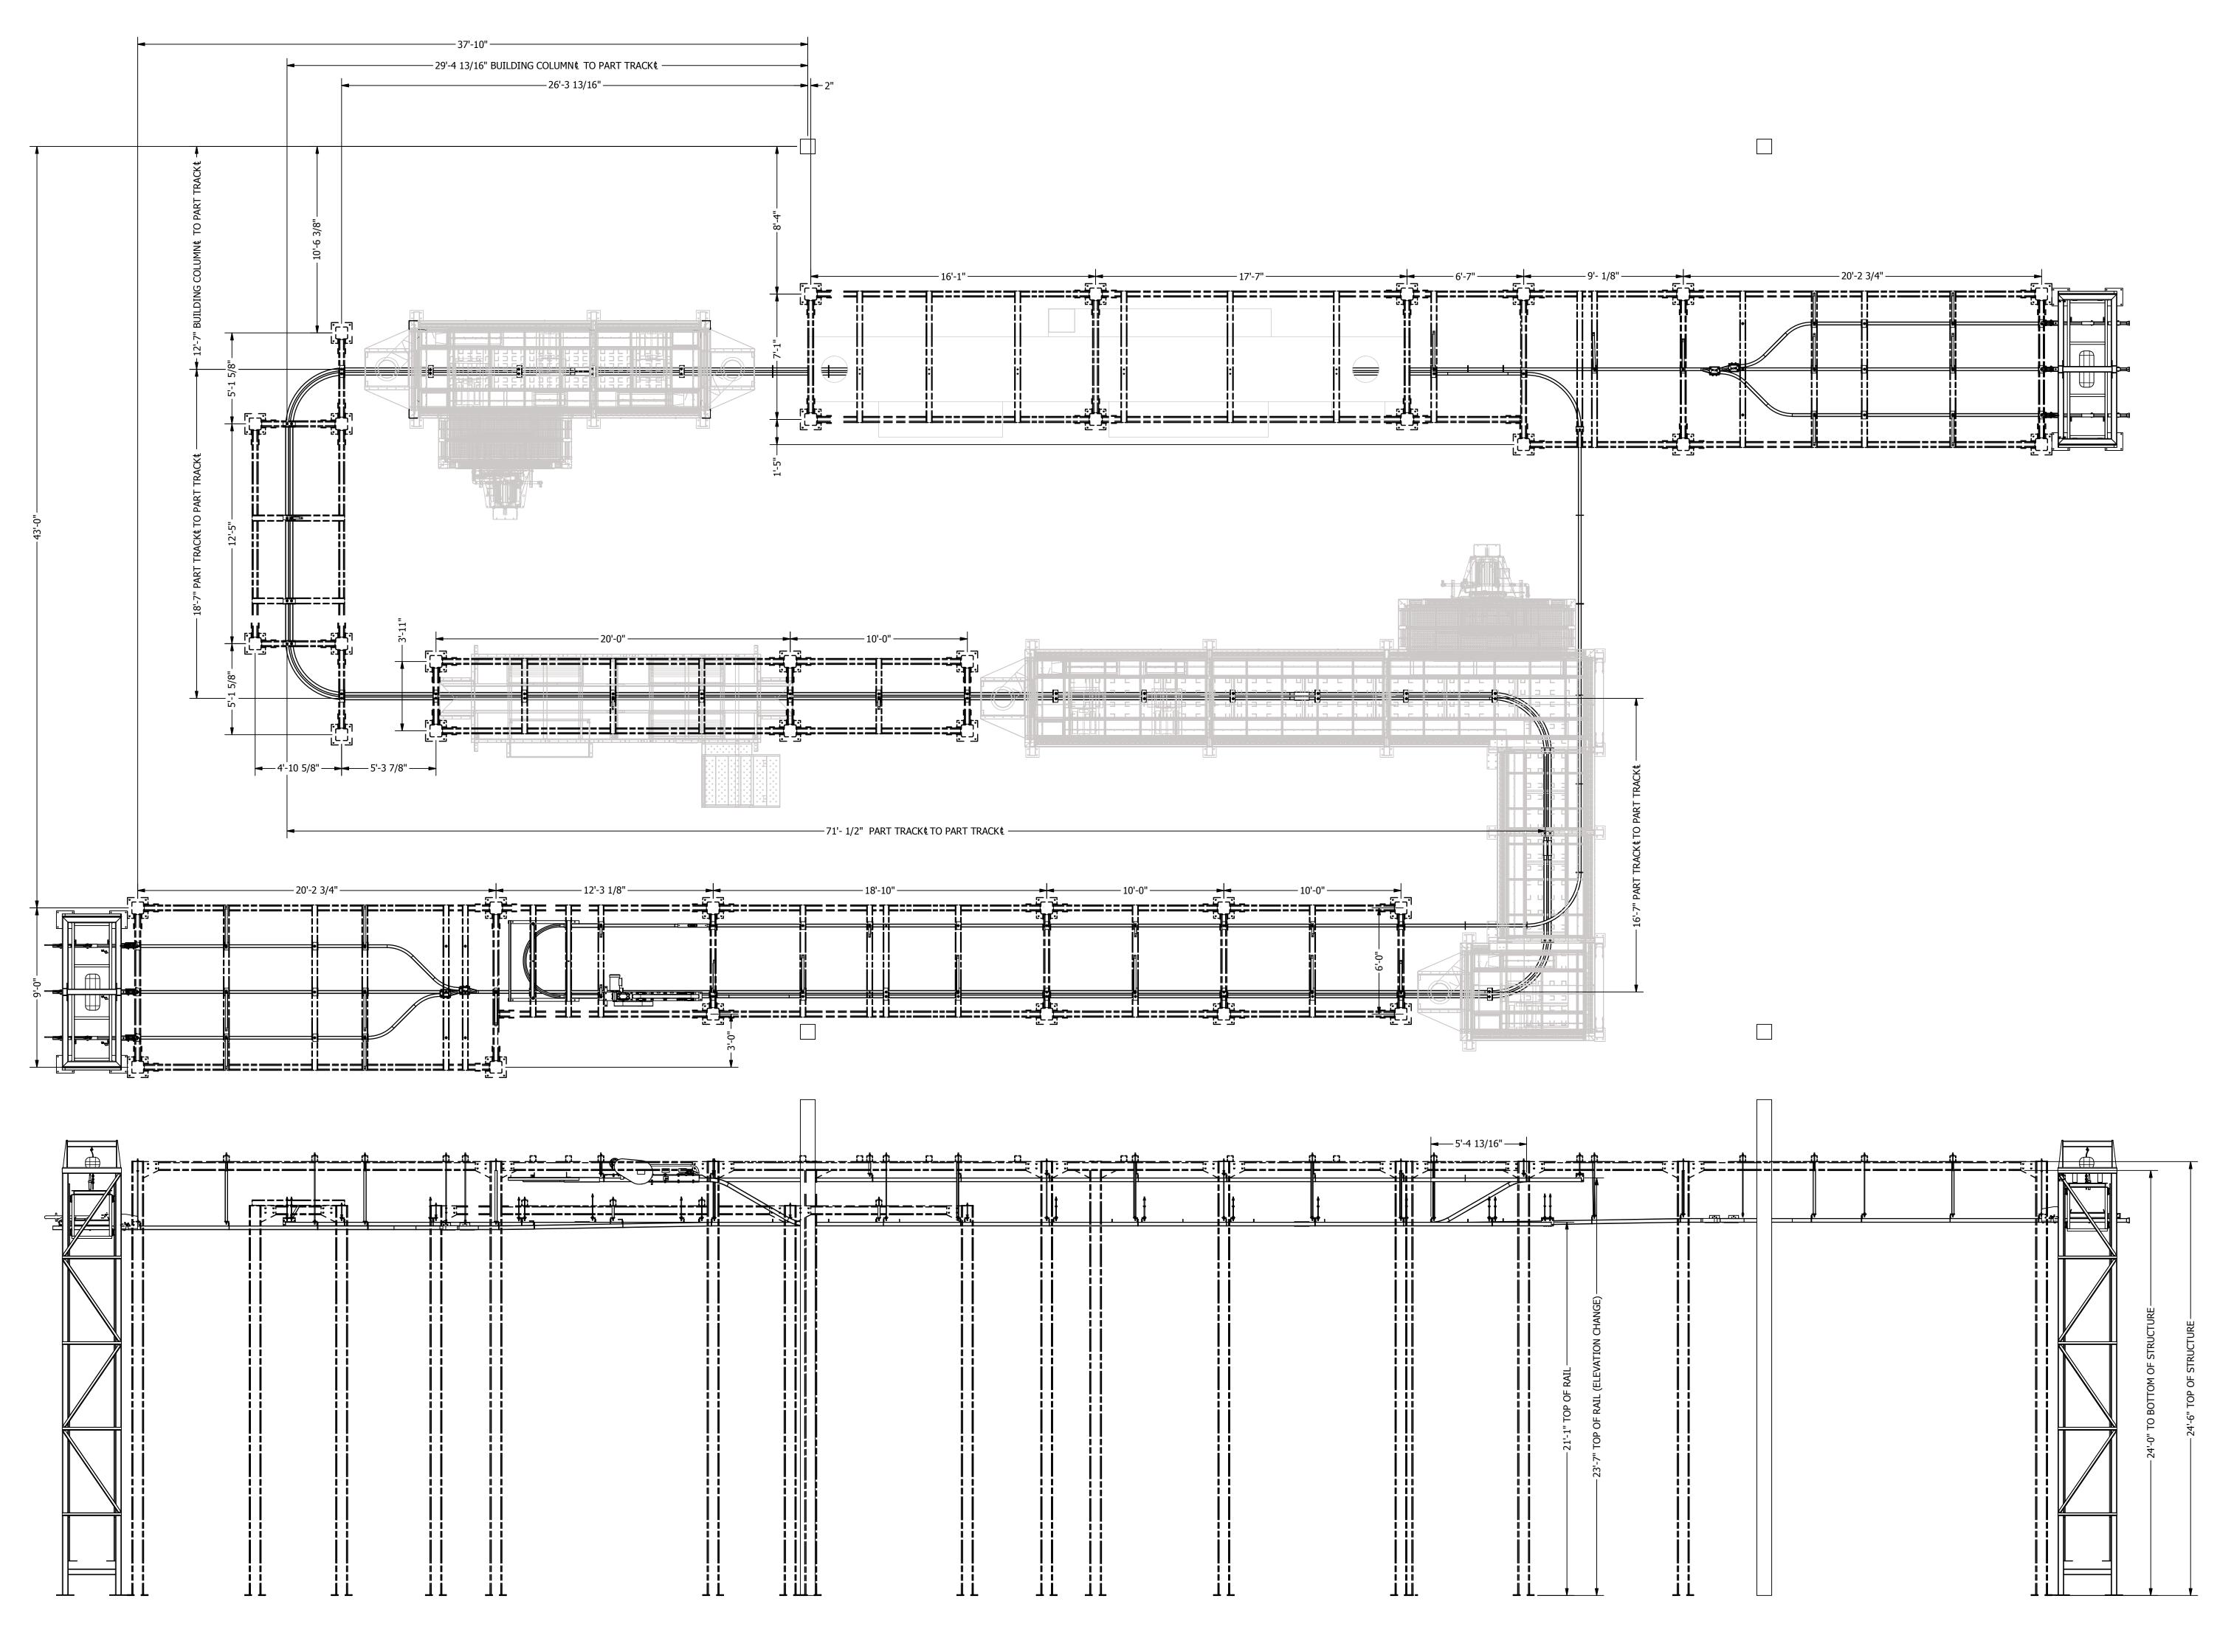

ROHNER MECHANICAL, INC
D.B.A. "ROHNER"
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VANCOUVER, WA 98661
(360) 885-7641 VOICE
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WA. LIC. # ROHNEMI015LP
OR. LIC. # 135549
CA# 792654
WWW.ROHNER-USA.COM

PRESCIENT
2125 SENATOR RALPH SCOTT PARKV

DRAWN BY: HGS

CHECKED BY: DGR

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ISSUED DATE: 3/24/17

REV: 17.1 - 3/24/17

DESCRIPTION OF CHANGE(S):

CONSTRUCTION SET

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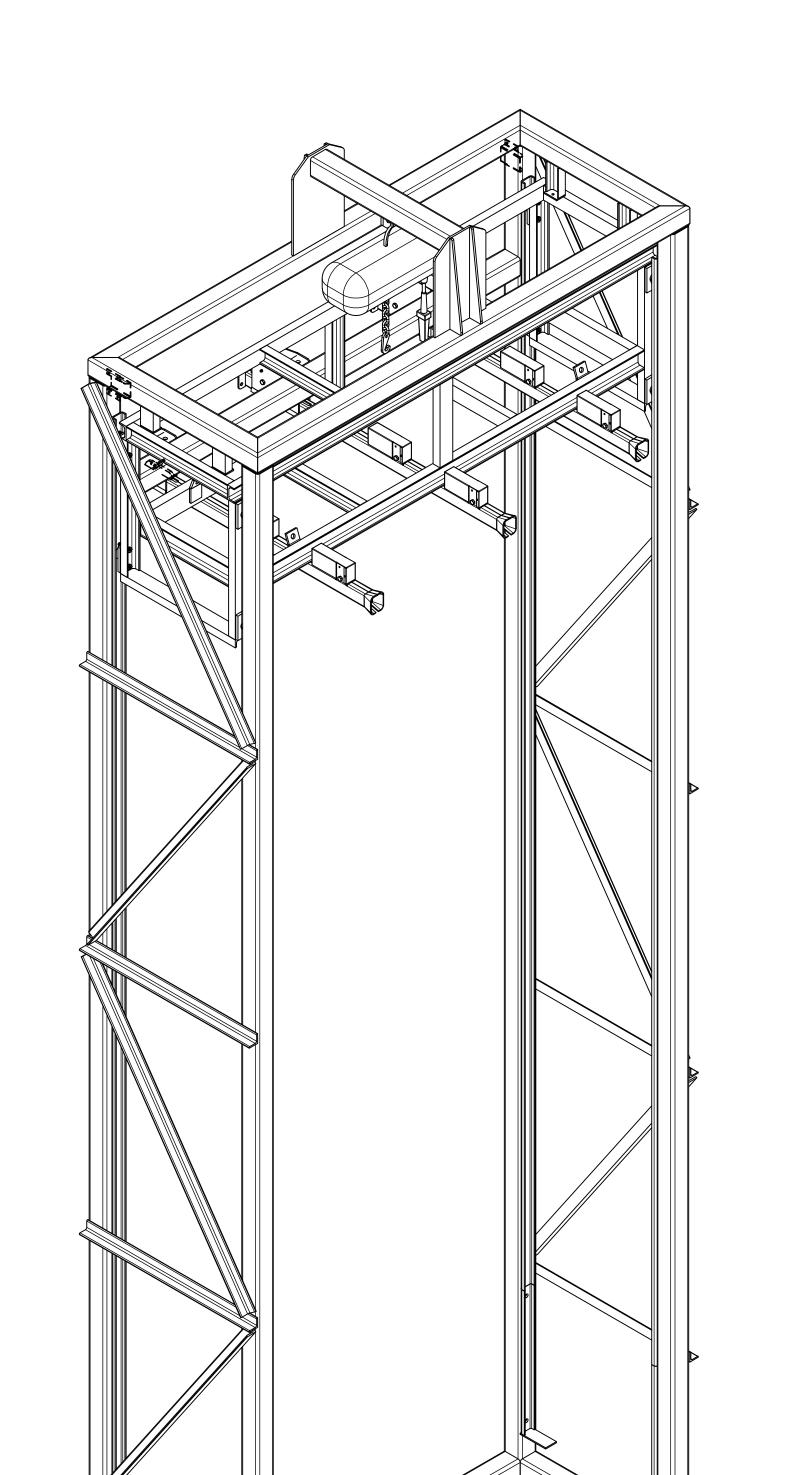
DRAWING TITLE:
EXPLODED
ISOMETRIC
ASSEMBLY
DRAWING

R2016151


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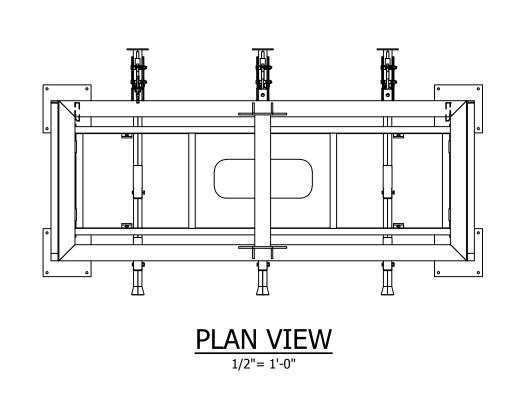
Conveyor and Structure


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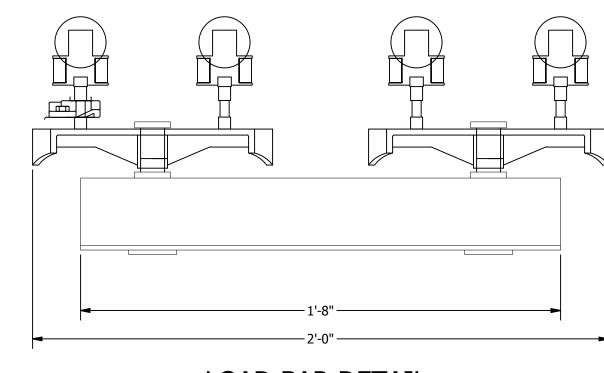


ISOMETRIC VIEW NOT TO SCALE





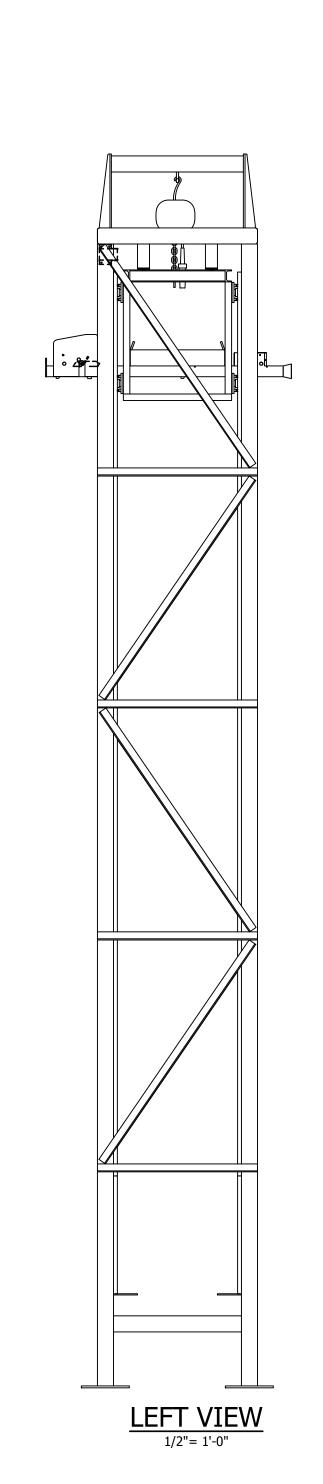

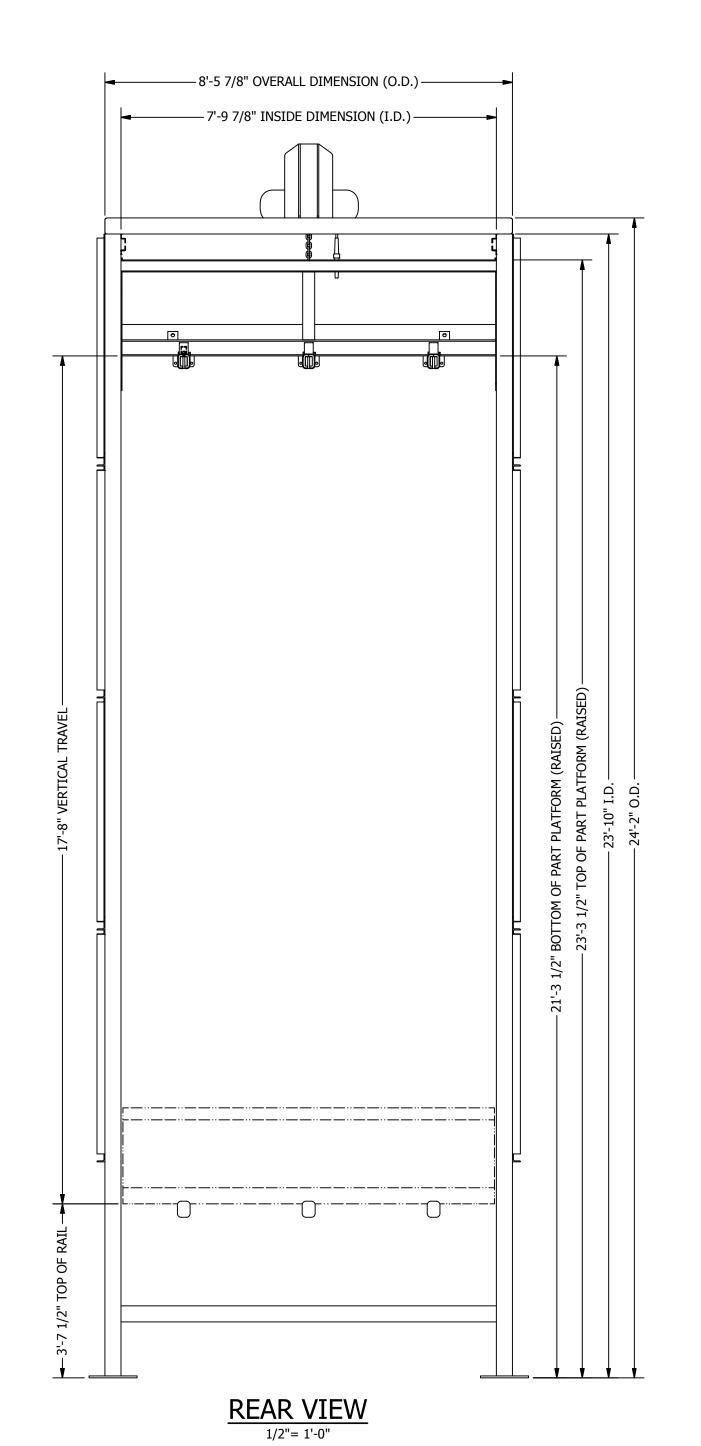

LOAD BAR DETAIL DO NOT SCALE

GENERAL NOTES:


- (2) PART LIFT/LOWER ELEVATOR ASSEMBLIES RATED @ 3X 500 LBS EACH.
- 2. (100) LOAD BAR ASSEMBLIES RATED @ 500 LBS EACH.
- 3. (2) HARRINGTON ELECTRIC CHAIN HOIST:
 CAPACITY: 1 TON
 LIFT SPEED: 28/4.5 2-STEP VARIABLE VFD
 SMART LIMIT EQUIPED
 VOLTAGE: 440v-480v-3Ph-60Hz

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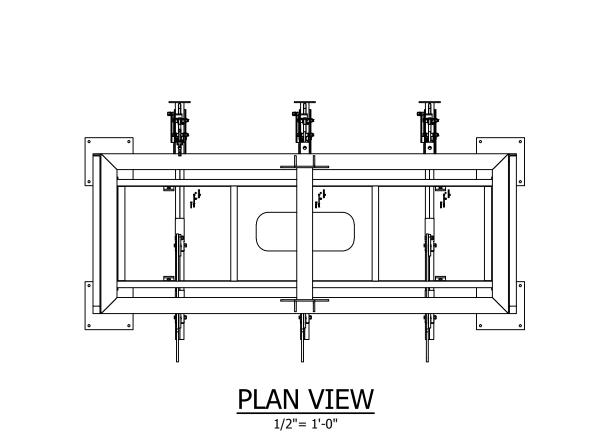
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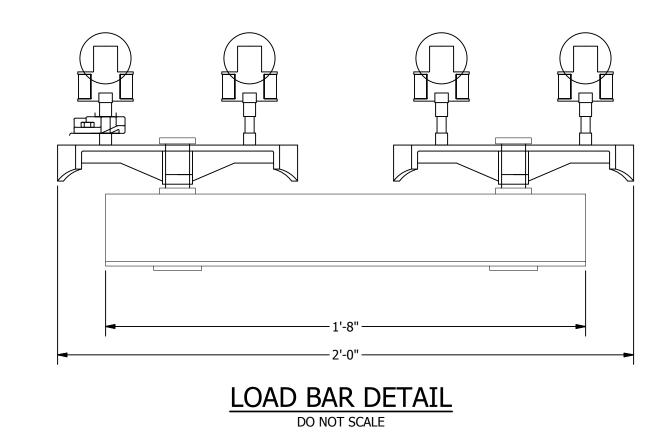
1 TON PART LIFT ELEVATOR

R2016151 1 TON PART LIFT ELEVATOR





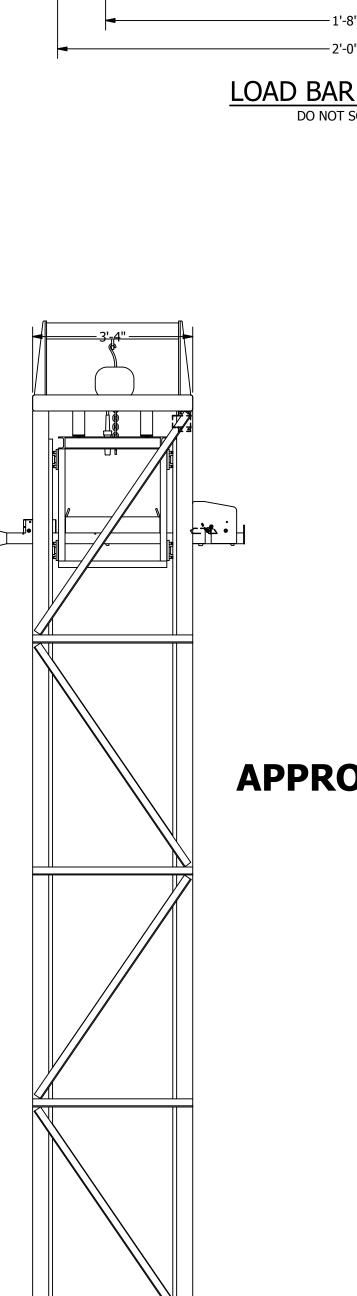






GENERAL NOTES:

- (2) PART LIFT/LOWER ELEVATOR ASSEMBLIES RATED @ 3X 500 LBS EACH.
- 2. (100) LOAD BAR ASSEMBLIES RATED @ 500 LBS EACH.
- 3. (2) HARRINGTON ELECTRIC CHAIN HOIST:
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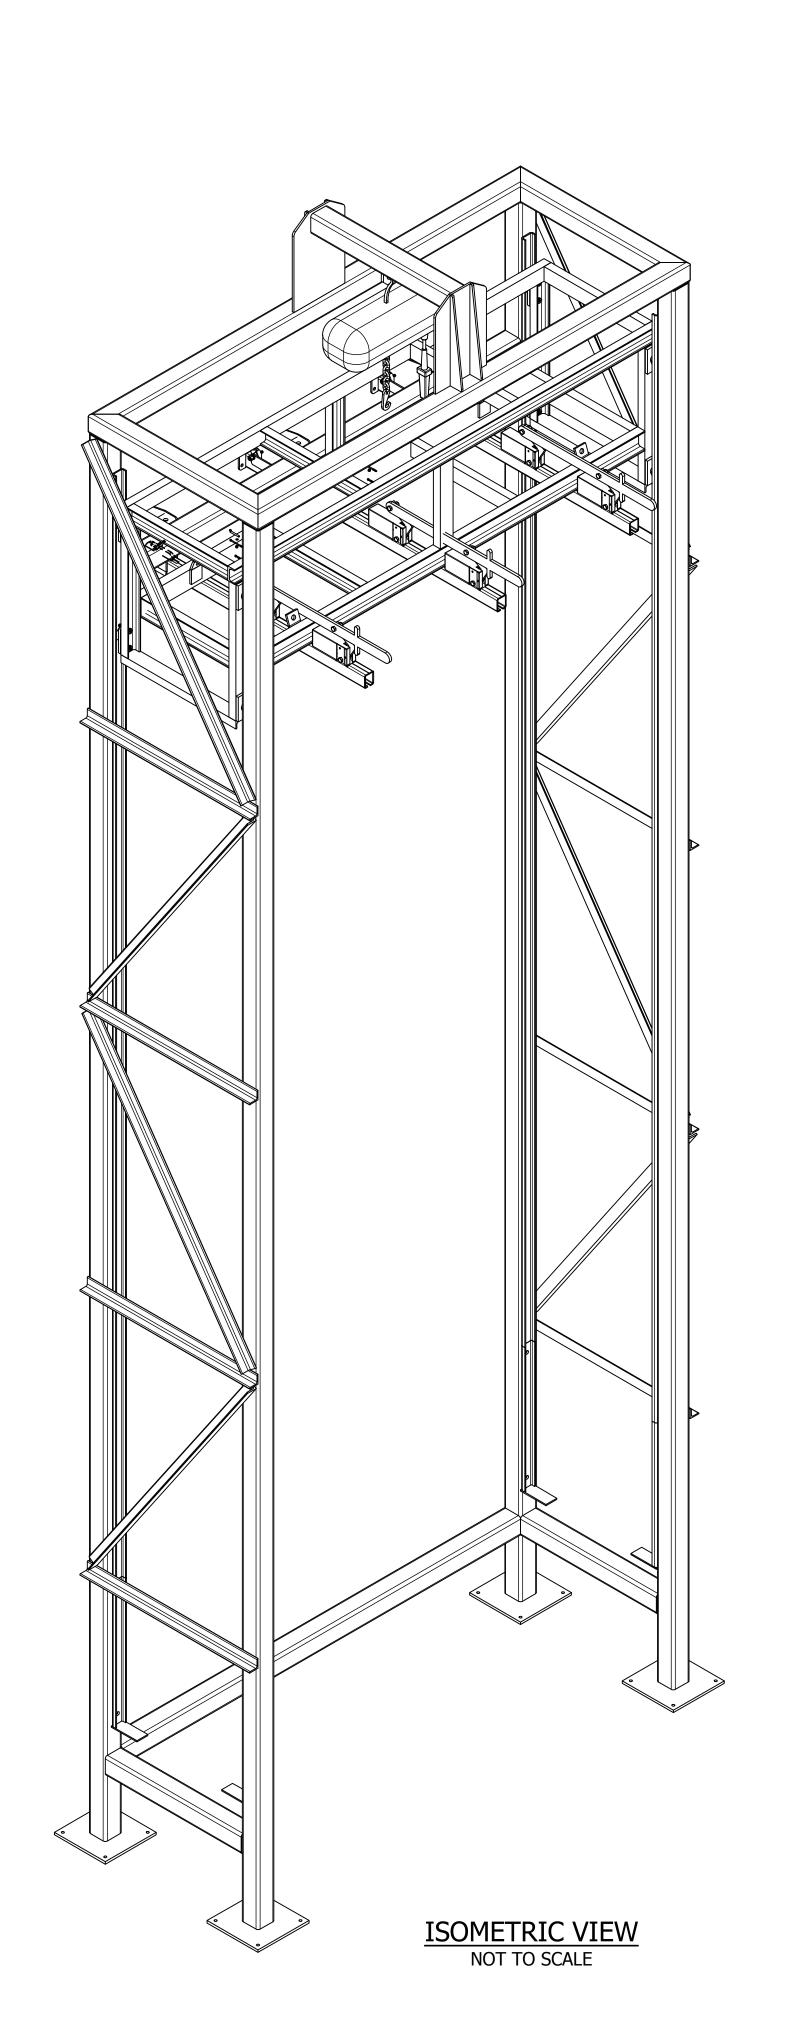


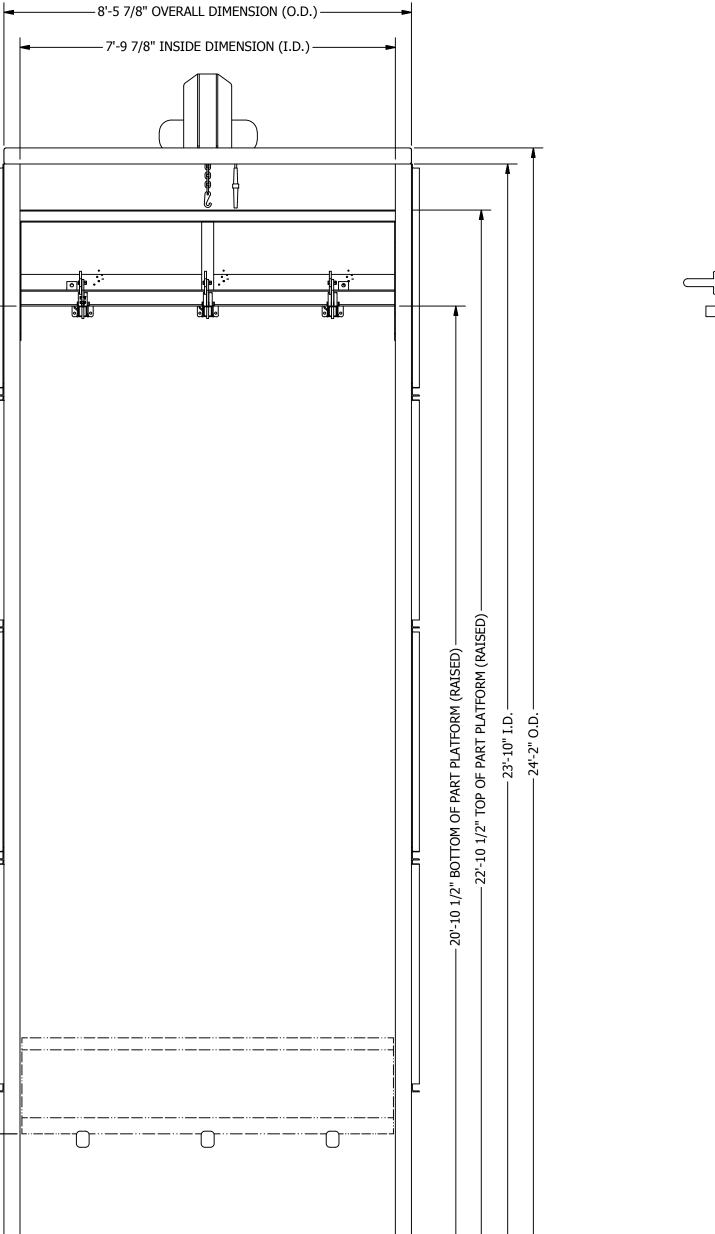
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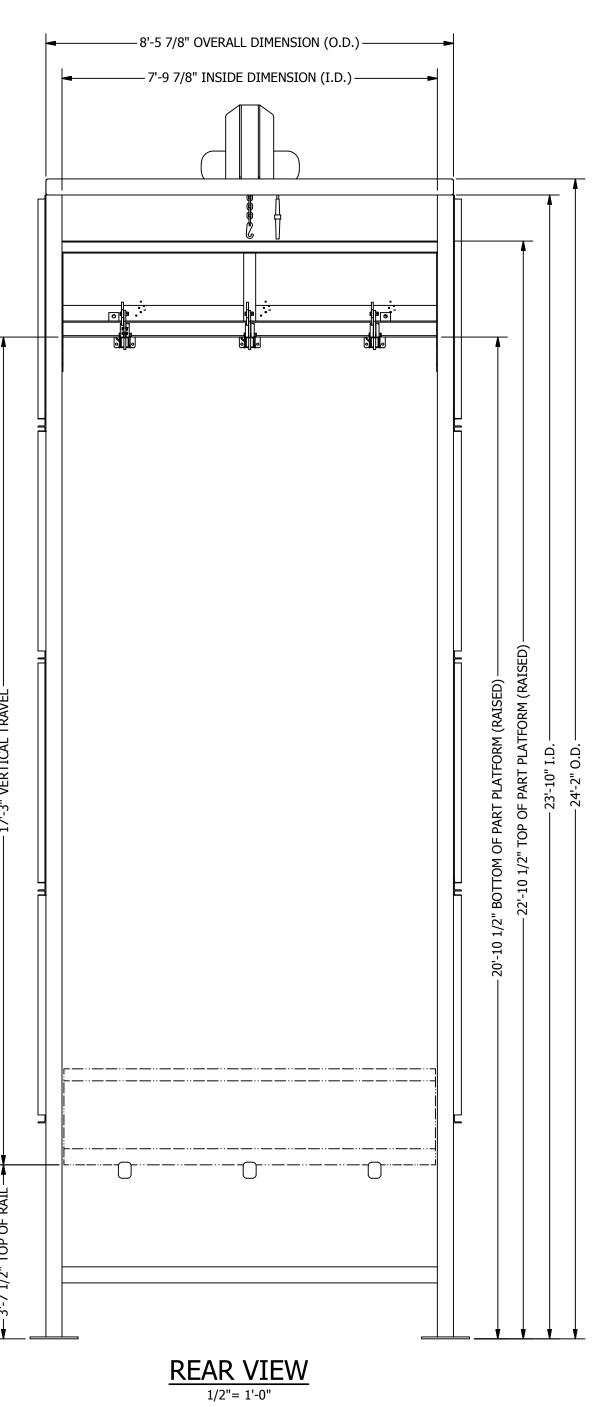
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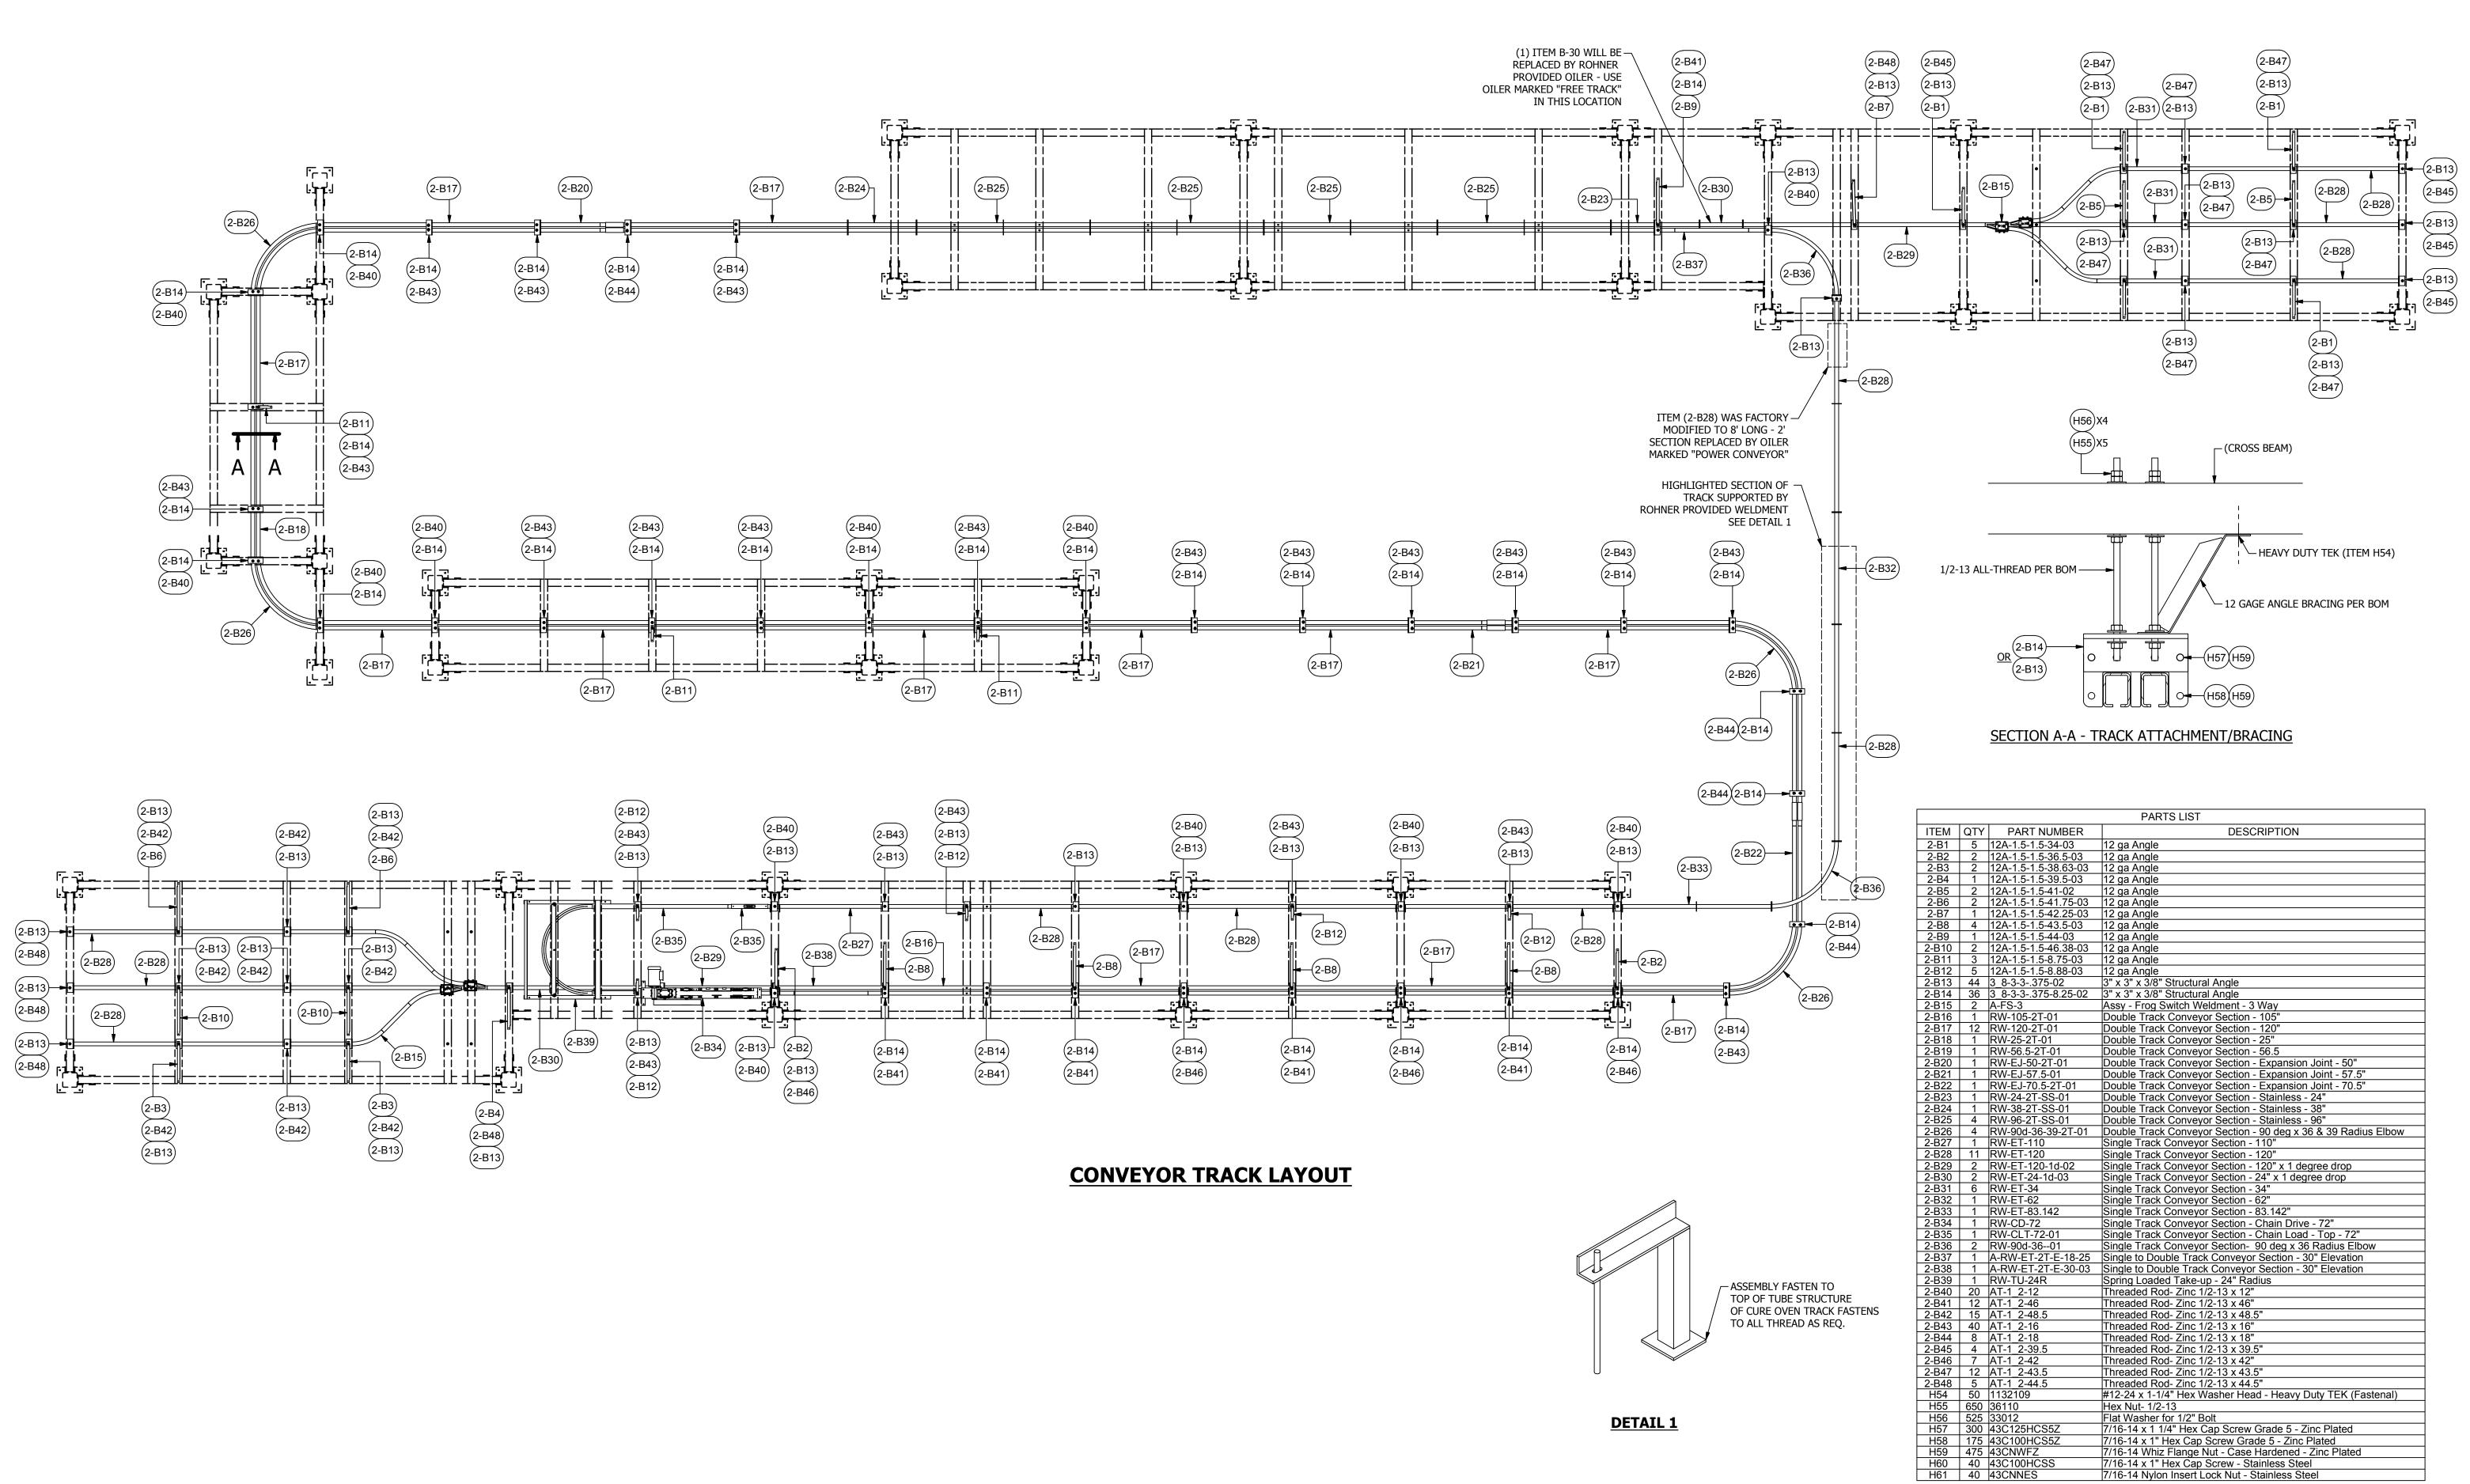
APPROVAL DRAWING INITIAL RELEASE 1 TON PART LIFT ELEVATOR

OB NO: R2016151 1 TON PART LIFT ELEVATOR







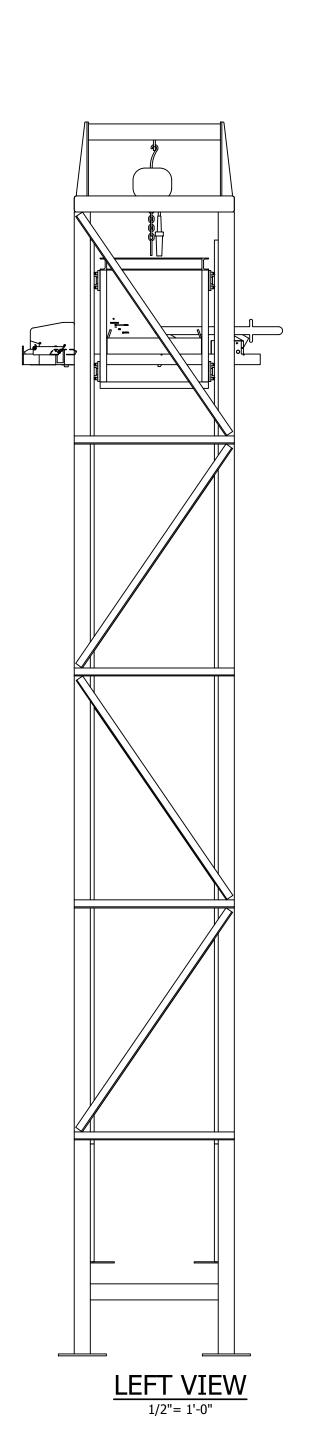



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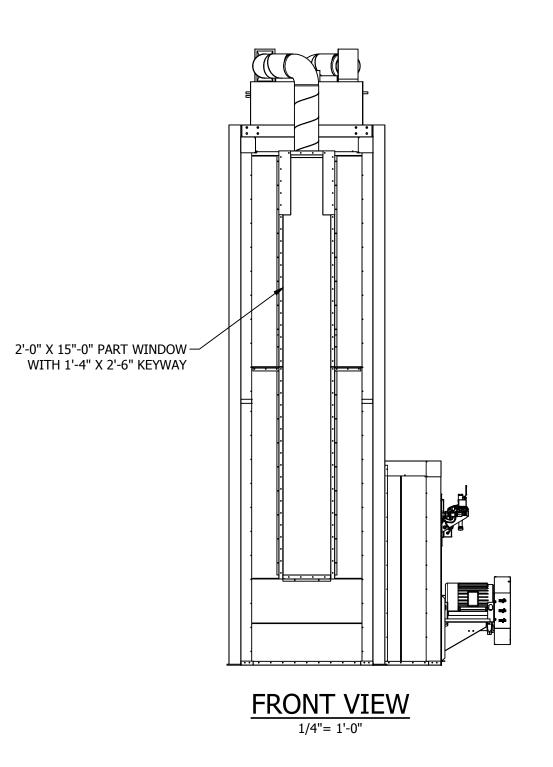
DRAWING TITLE: CONVEYOR TRACK


CONSTRUCTION SET

INITIAL RELEASE


R2016151 CONVEYOR TRACK


7/16-14 Nylon Insert Lock Nut - Stainless Steel




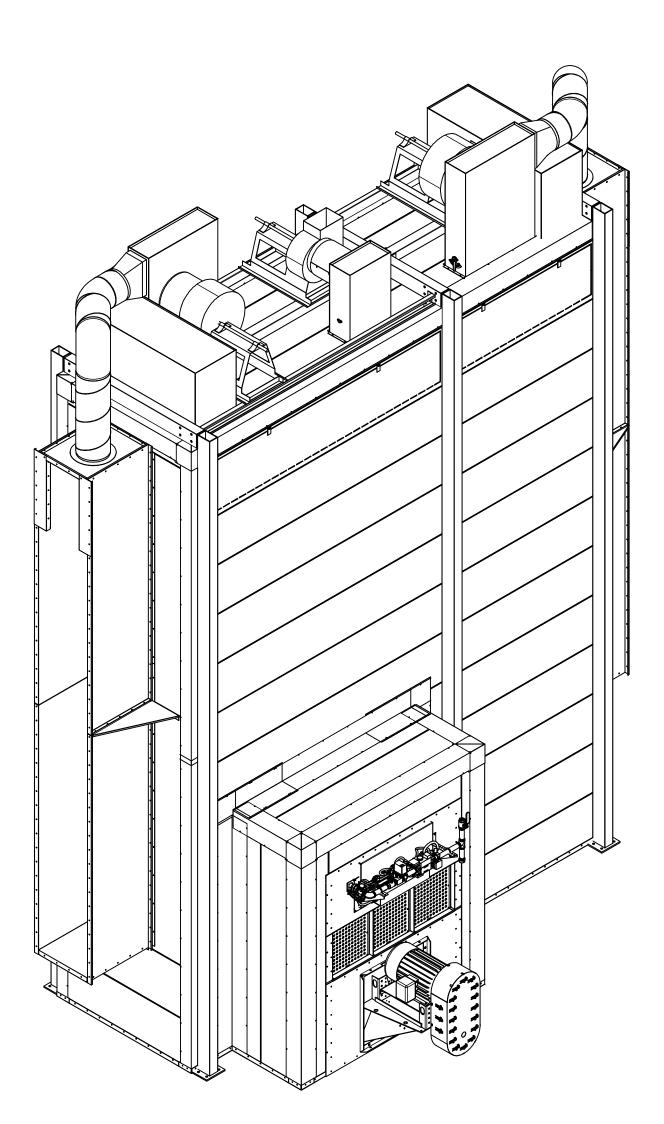



ISOMETRIC VIEW
NOT TO SCALE

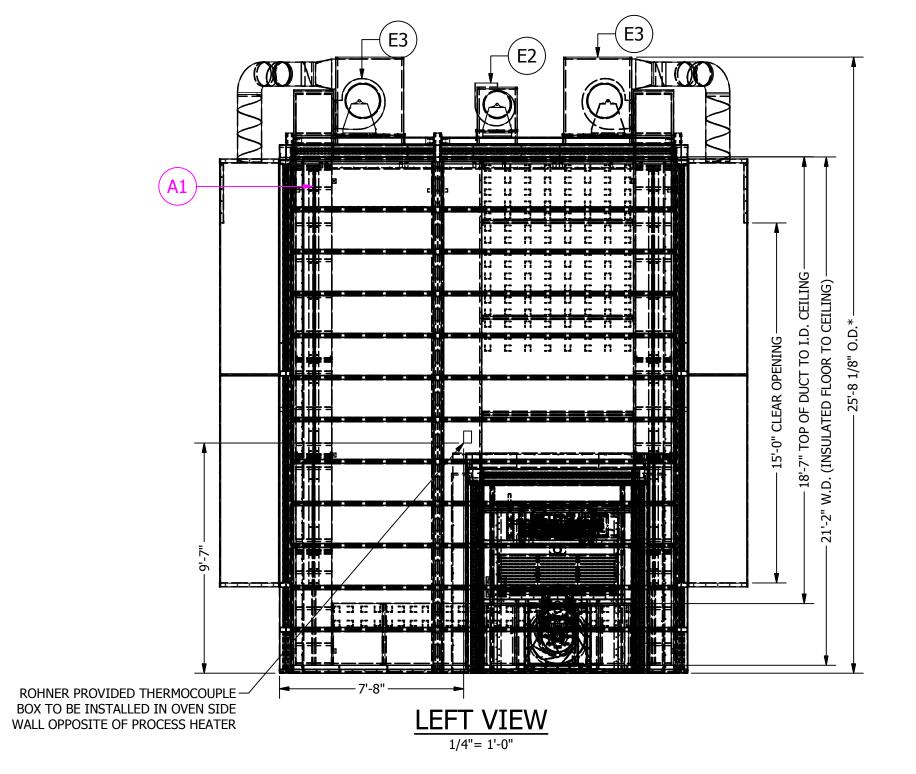

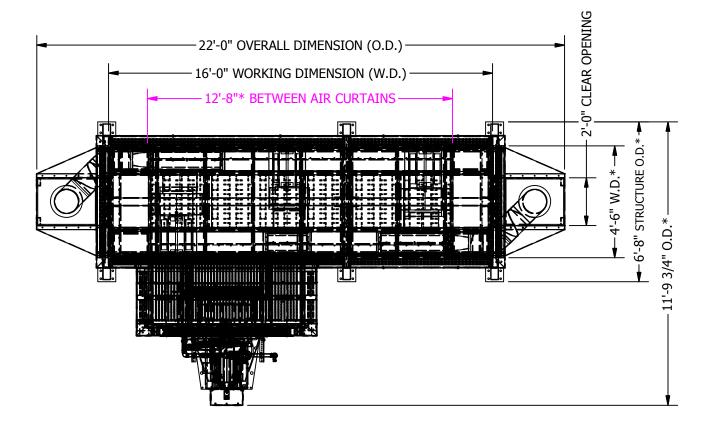

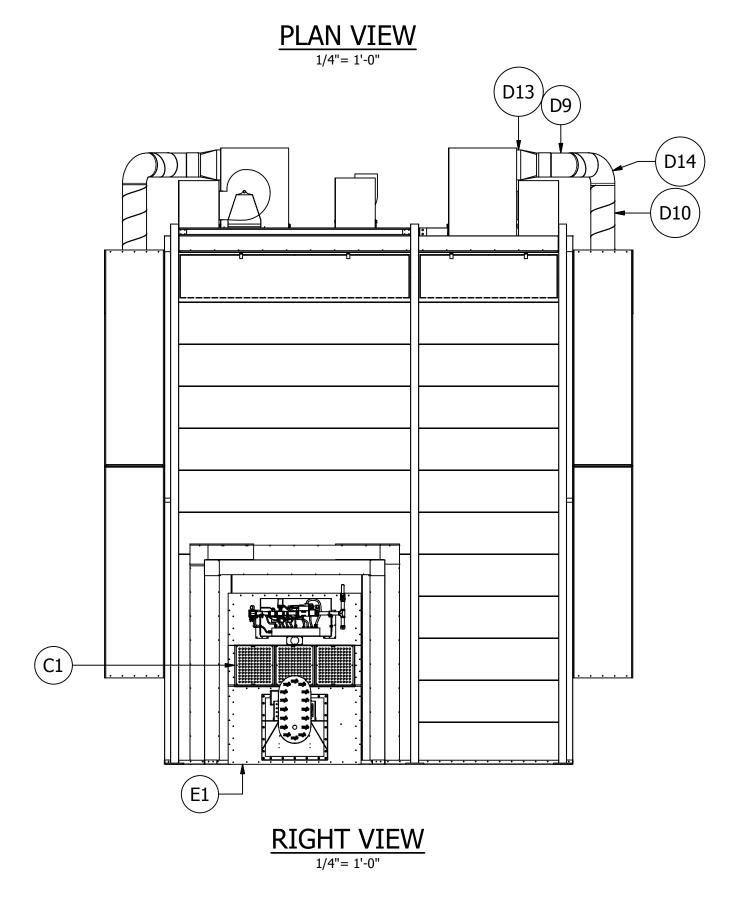

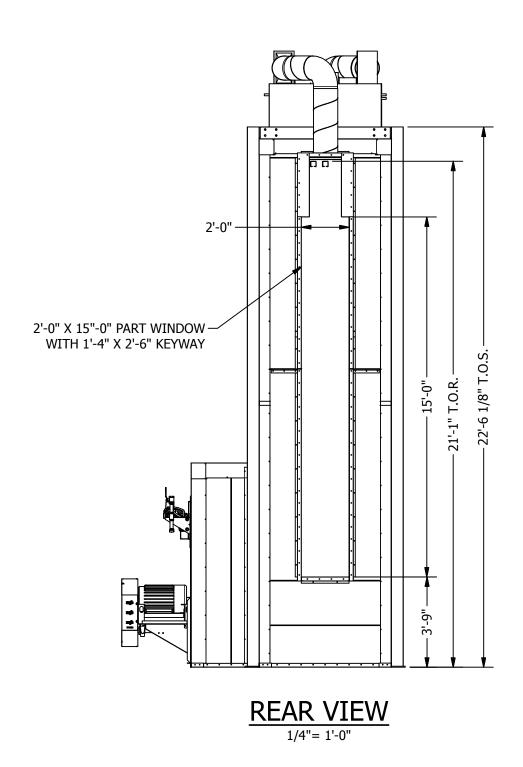

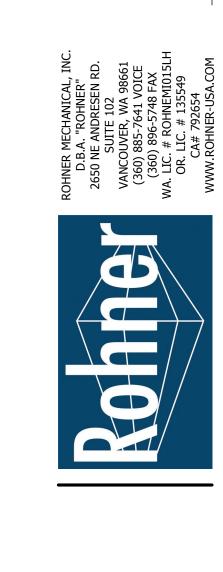

APPROVED FOR CONSTRUCTION

(1ea) Industrial Insulated Dry-Off Oven with (1) direct fired process heater, oven side wall mounted and one exhaust fan, oven top mounted. Filtered supply air is pulled from the interior of the building. Exhaust air is removed from the enclosure and delivered to the building exterior.				
				воотн
Tag	Qty.	Pck.	Part	Description
31	1		POHT-WP-4.5-21.5-17 - Sht. 3.1	POHT-WP-4.5-21.5-17 - Structure - Sht. 3.1
32	1		POHT-WP-4.5-21.5-17 - Sht. 3.2	POHT-WP-4.5-21.5-17 - Floor Track - Sht. 3.2
33	1		POHT-WP-4.5-21.5-17 - Sht. 3.3	POHT-WP-4.5-21.5-17 - Sidewalls - Sht. 3.3
34	1		POHT-WP-4.5-21.5-17 - Sht. 3.4	POHT-WP-4.5-21.5-17 - Endwalls - Sht. 3.4
3 5	1		POHT-WP-4.5-21.5-17 - Sht. 3.5	POHT-WP-4.5-21.5-17 - Ceiling - Sht. 3.5
36	1		POHT-WP-4.5-21.5-17 - Sht. 3.6	POHT-WP-4.5-21.5-17 - Duct - Sht. 3.6
B7	1		POHT-WP-4.5-21.5-17 - Sht. 3.7	POHT-WP-4.5-21.5-17 - Flashing - Sht. 3.7
38	1		POHT-WP-4.5-21.5-17 - Sht. 3.8	POHT-WP-4.5-21.5-17 - Insulated Floor - Sht. 3.8
39	1		POHT-WP-4.5-21.5-17 - Sht. 3.9	POHT-WP-4.5-21.5-17 - Air Curtain - Sht. 3.9
B10	1		POHT-WP-4.5-21.5-17 - Sht. 3.10	POHT-WP-4.5-21.5-17 - Return Duct - Sht. 3.10
				EQUIPMENT
E1	1		A-PH-B	Natural Gas Direct Fired Process Heater 1.5 Million BTU, 9,600 CFM, 10hp
E2	1		CSW-10-BI-21-10-I-5	Series 21 Backward Inclined Single Width Fan, 1100 cfm @ .5" s.p., .5 hp 460v/3/60
E3	2		CSW-12-BI-21-10-II-50	Series 21 Backward Inclined Single Width Fan, 3000 cfm @ 3" s.p., 5 hp 460v/3/60
				COMPONENTS
C1	3		01AFR2020-20	#01AFR 2020-20 - Intake AFR1 Panel - white
				ASSEMBLIES
A1	4		A-AC-12-18-180	Air Curtain Assembly - 12" x 18" over 15'
				CONTROLS
CO1	1		POHT PLC	Compact PLC based control center- 24VDC power supply, 24 I/O PLC controller, PID temperature control relay with auto tuning & 5.7" QVGA color touch screen HMI. (1) .5 hp. And (2) 5 hp. motor starters.
				DUCT
D1	1		D20-SQR-8.2511.5-14	Exhaust Duct- Square to Round- 8.25" x 11.5" to 14" dia. Over 1'
D2	1		CSP-14-10-26GA	Spiral Pipe 14"X10' 26Ga
D3	1		D-RWS-16D	Exhaust Duct- Rockwool Sleeve, 16" Dia. Over 4' w/ Storm Collar
D4	1		SC-14	Exhaust Duct- Storm Collar- 14"
D5	1		SC-16	Exhaust Duct- Storm Collar- 16"
D7	1		CC-14	China Cap- 14" Dia
D8	1		D-RRJ-20D	Exhaust Duct- Flat Conical Roof Jack Assembly- 20" for 18" Duct w/ storm collar
D9	1		D18-S-18d-45	Exhaust Duct- Sleeve, 18" Dia.
D10	2		CSP-12-10-26GA	Spiral Pipe 12"X10' 26Ga
D11	2		CEL-12-24-45	12" Ajustable 45 degree Elbow
D12	2		COS 12 ATTO D	12" Air Tight Take Off With Damper
D13	2		D20-SQR-815-12	Exhaust Duct- Square to Round- 8" x 15" to 12" dia. Over 1'
D14	2		CEL-12-24-90	12" Ajustable 90 degree Elbow
			<u> </u>	GENERAL NOTES

PRESCIENT
2125 SENATOR RALPH SCOTT PARKWAY

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CHECKED BY: DGR

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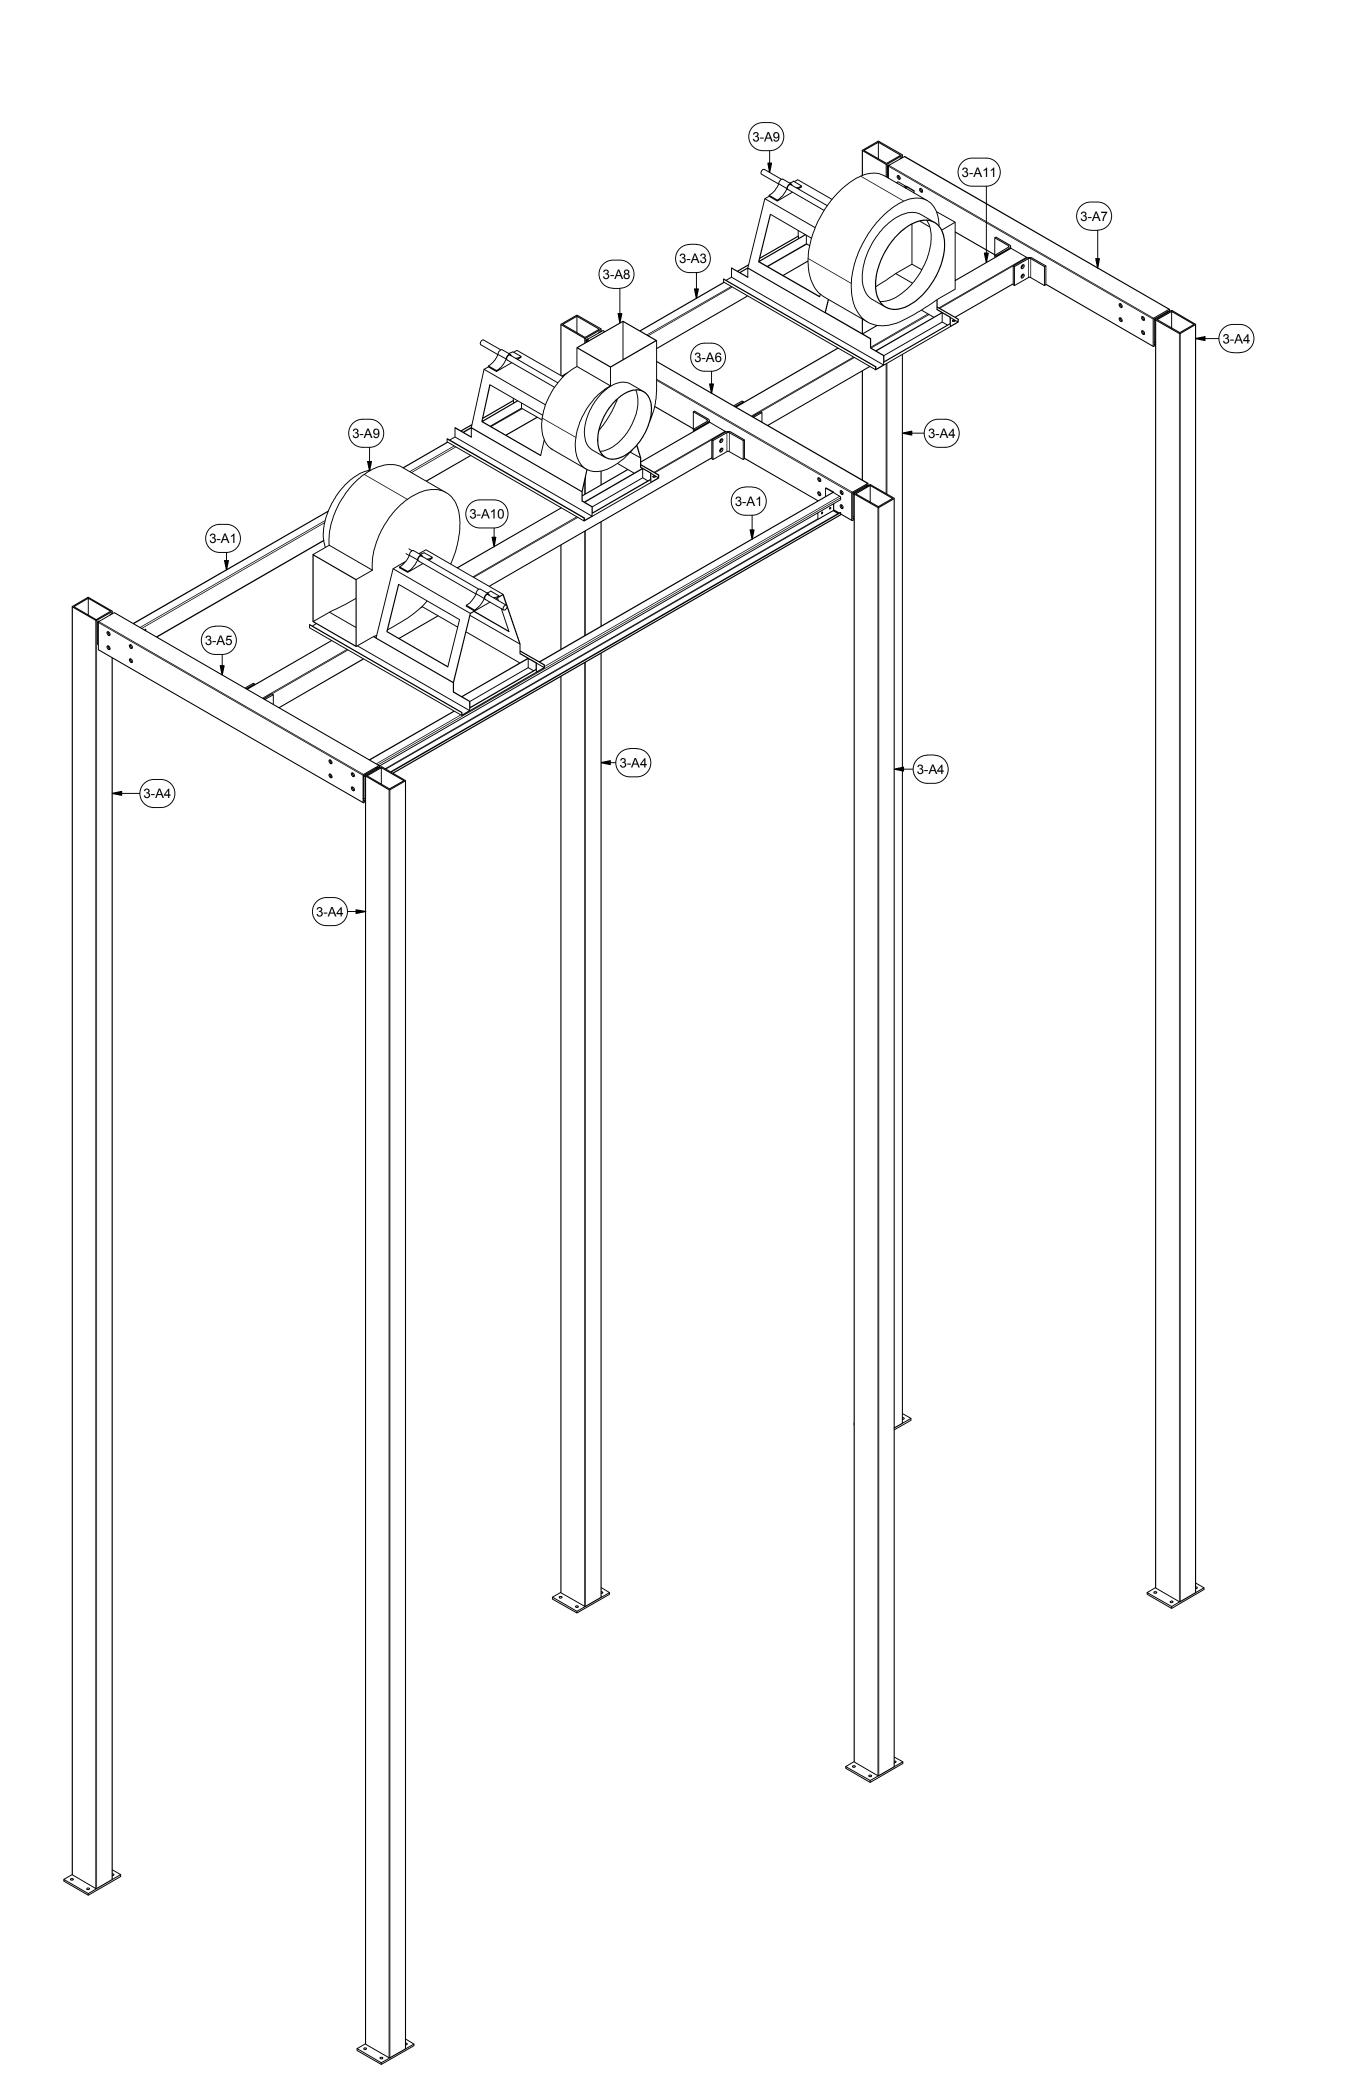
REV: 11/21/16 - 16.1

DESCRIPTION OF CHANGE(S): CONSTRUCTION SET


DRAWING TITLE:
FLOOR PLANS/
ELEVATIONS/
SECTIONS

R2016151
EQUIP. NO:
POHT-WP-4.5-21.5-17-01
SHEET NO:


3



			PARTS LIST
ITEM	QTY	PART NUMBER	DESCRIPTION
3-A1	2	12CC-2-4-115.5-01	12 ga C Channel
3-A2	1	14A-2-4-3.7-01	14 ga Angle
3-A3	1	14CC-2-4-69.5-02	14 ga C Channel
3-A4	6	A-POHT-VS-6-270-05	Assy - Process Oven High Temp Vertical Structure
3-A5	1	A-TS-4-6-65-01	Assy - Tube Steel Weldment
3-A6	1	A-TS-4-6-65-02	Assy - Tube Steel Weldment
3-A7	1	A-TS-4-6-65-03	Assy - Tube Steel Weldment
3-A8	1	CSW-10-BI-21-10-I-5	Series 21 Backward Inclined Single Width, 3/4 hp
3-A9	2	CSW-12-BI-21-10-II-50	Series 21 Backward Inclined Single Width, 3/4 hp
3-A10	1	TS-4-4-115-02	Tube Steel 4"x6"x1/4"
3-A11	1	TS-4-4-69-02	Tube Steel 4"x6"x1/4"
H2	42	142034	Hex Bolt- 1/4-20x3/4"
Н3	42	857180	Hex Flange Lock Nut; 1/4-20
H10	48	62C150HCS5Z	Hex Bolt - 5/8-11x1 1/2"
H11	6	36114	Hex Nut - 5/8-11
H18	6	33015	5/8" x 1
H45	6	62C800HCS5	Hex Bolt - 5/8-11 8"

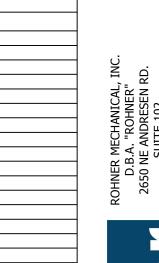



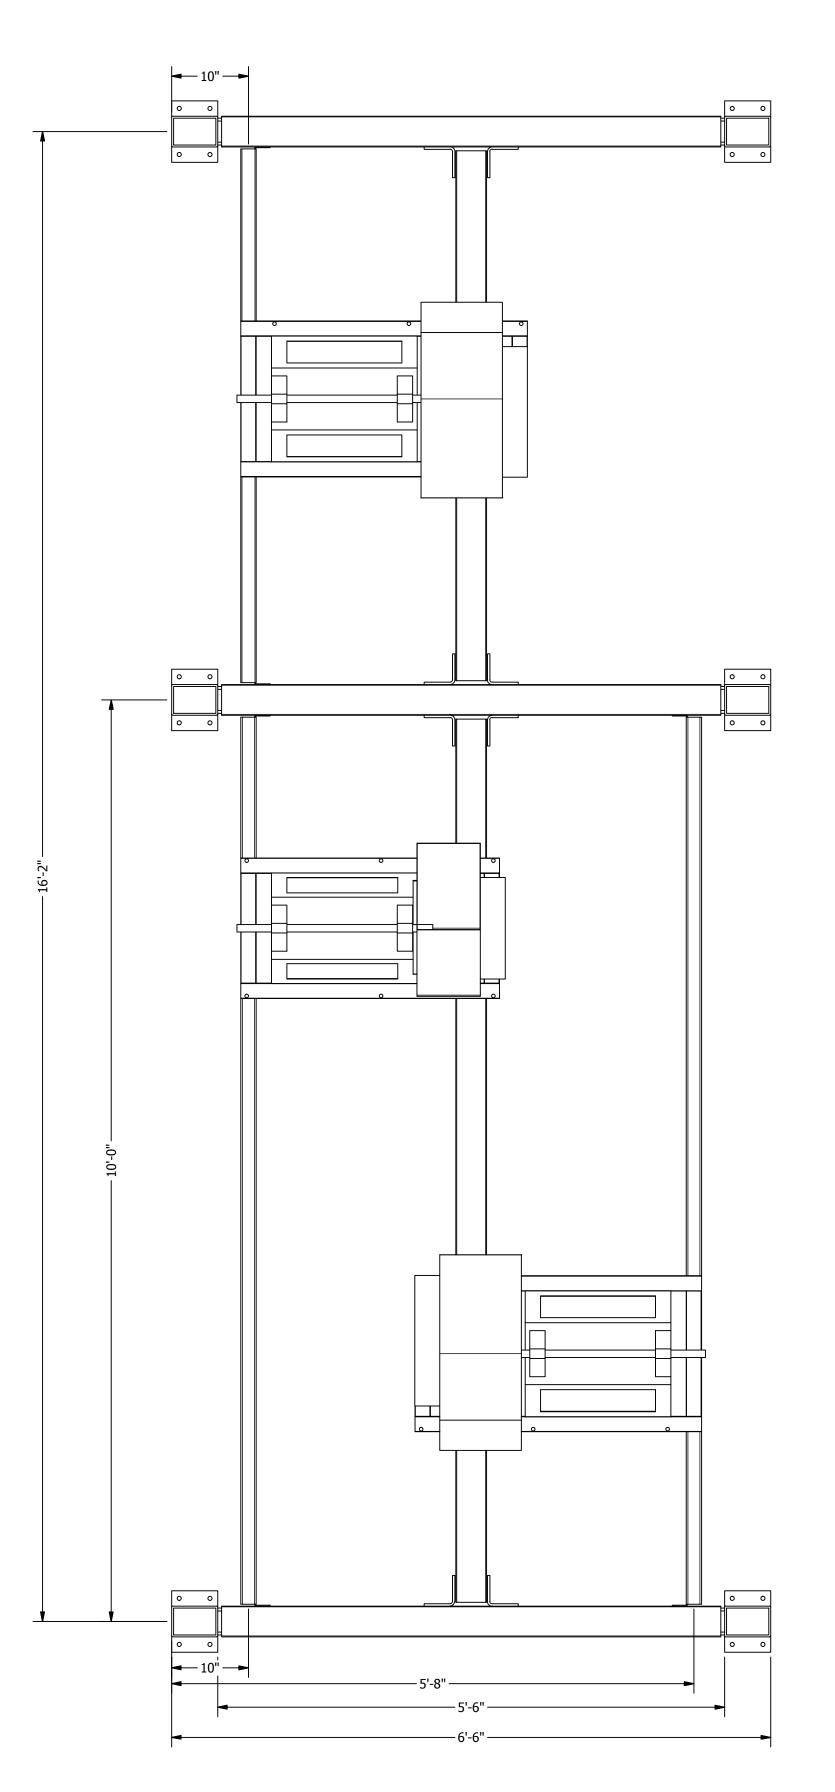

TEMPERATURE FOR:

PRESCIEN
2125 SENATOR RALPH SCOT

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CHECKED BY: DG

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REV: 16.1 - 11/18/16

DESCRIPTION OF CHANGE(S):
Construction Set


DRAWING TITLE:
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ISOMETRIC
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DRAWING


JOB NO: R20161


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EQUIP. NO:
POHT-WP-4.5-21.5-17-01
SHEET NO:

3.1



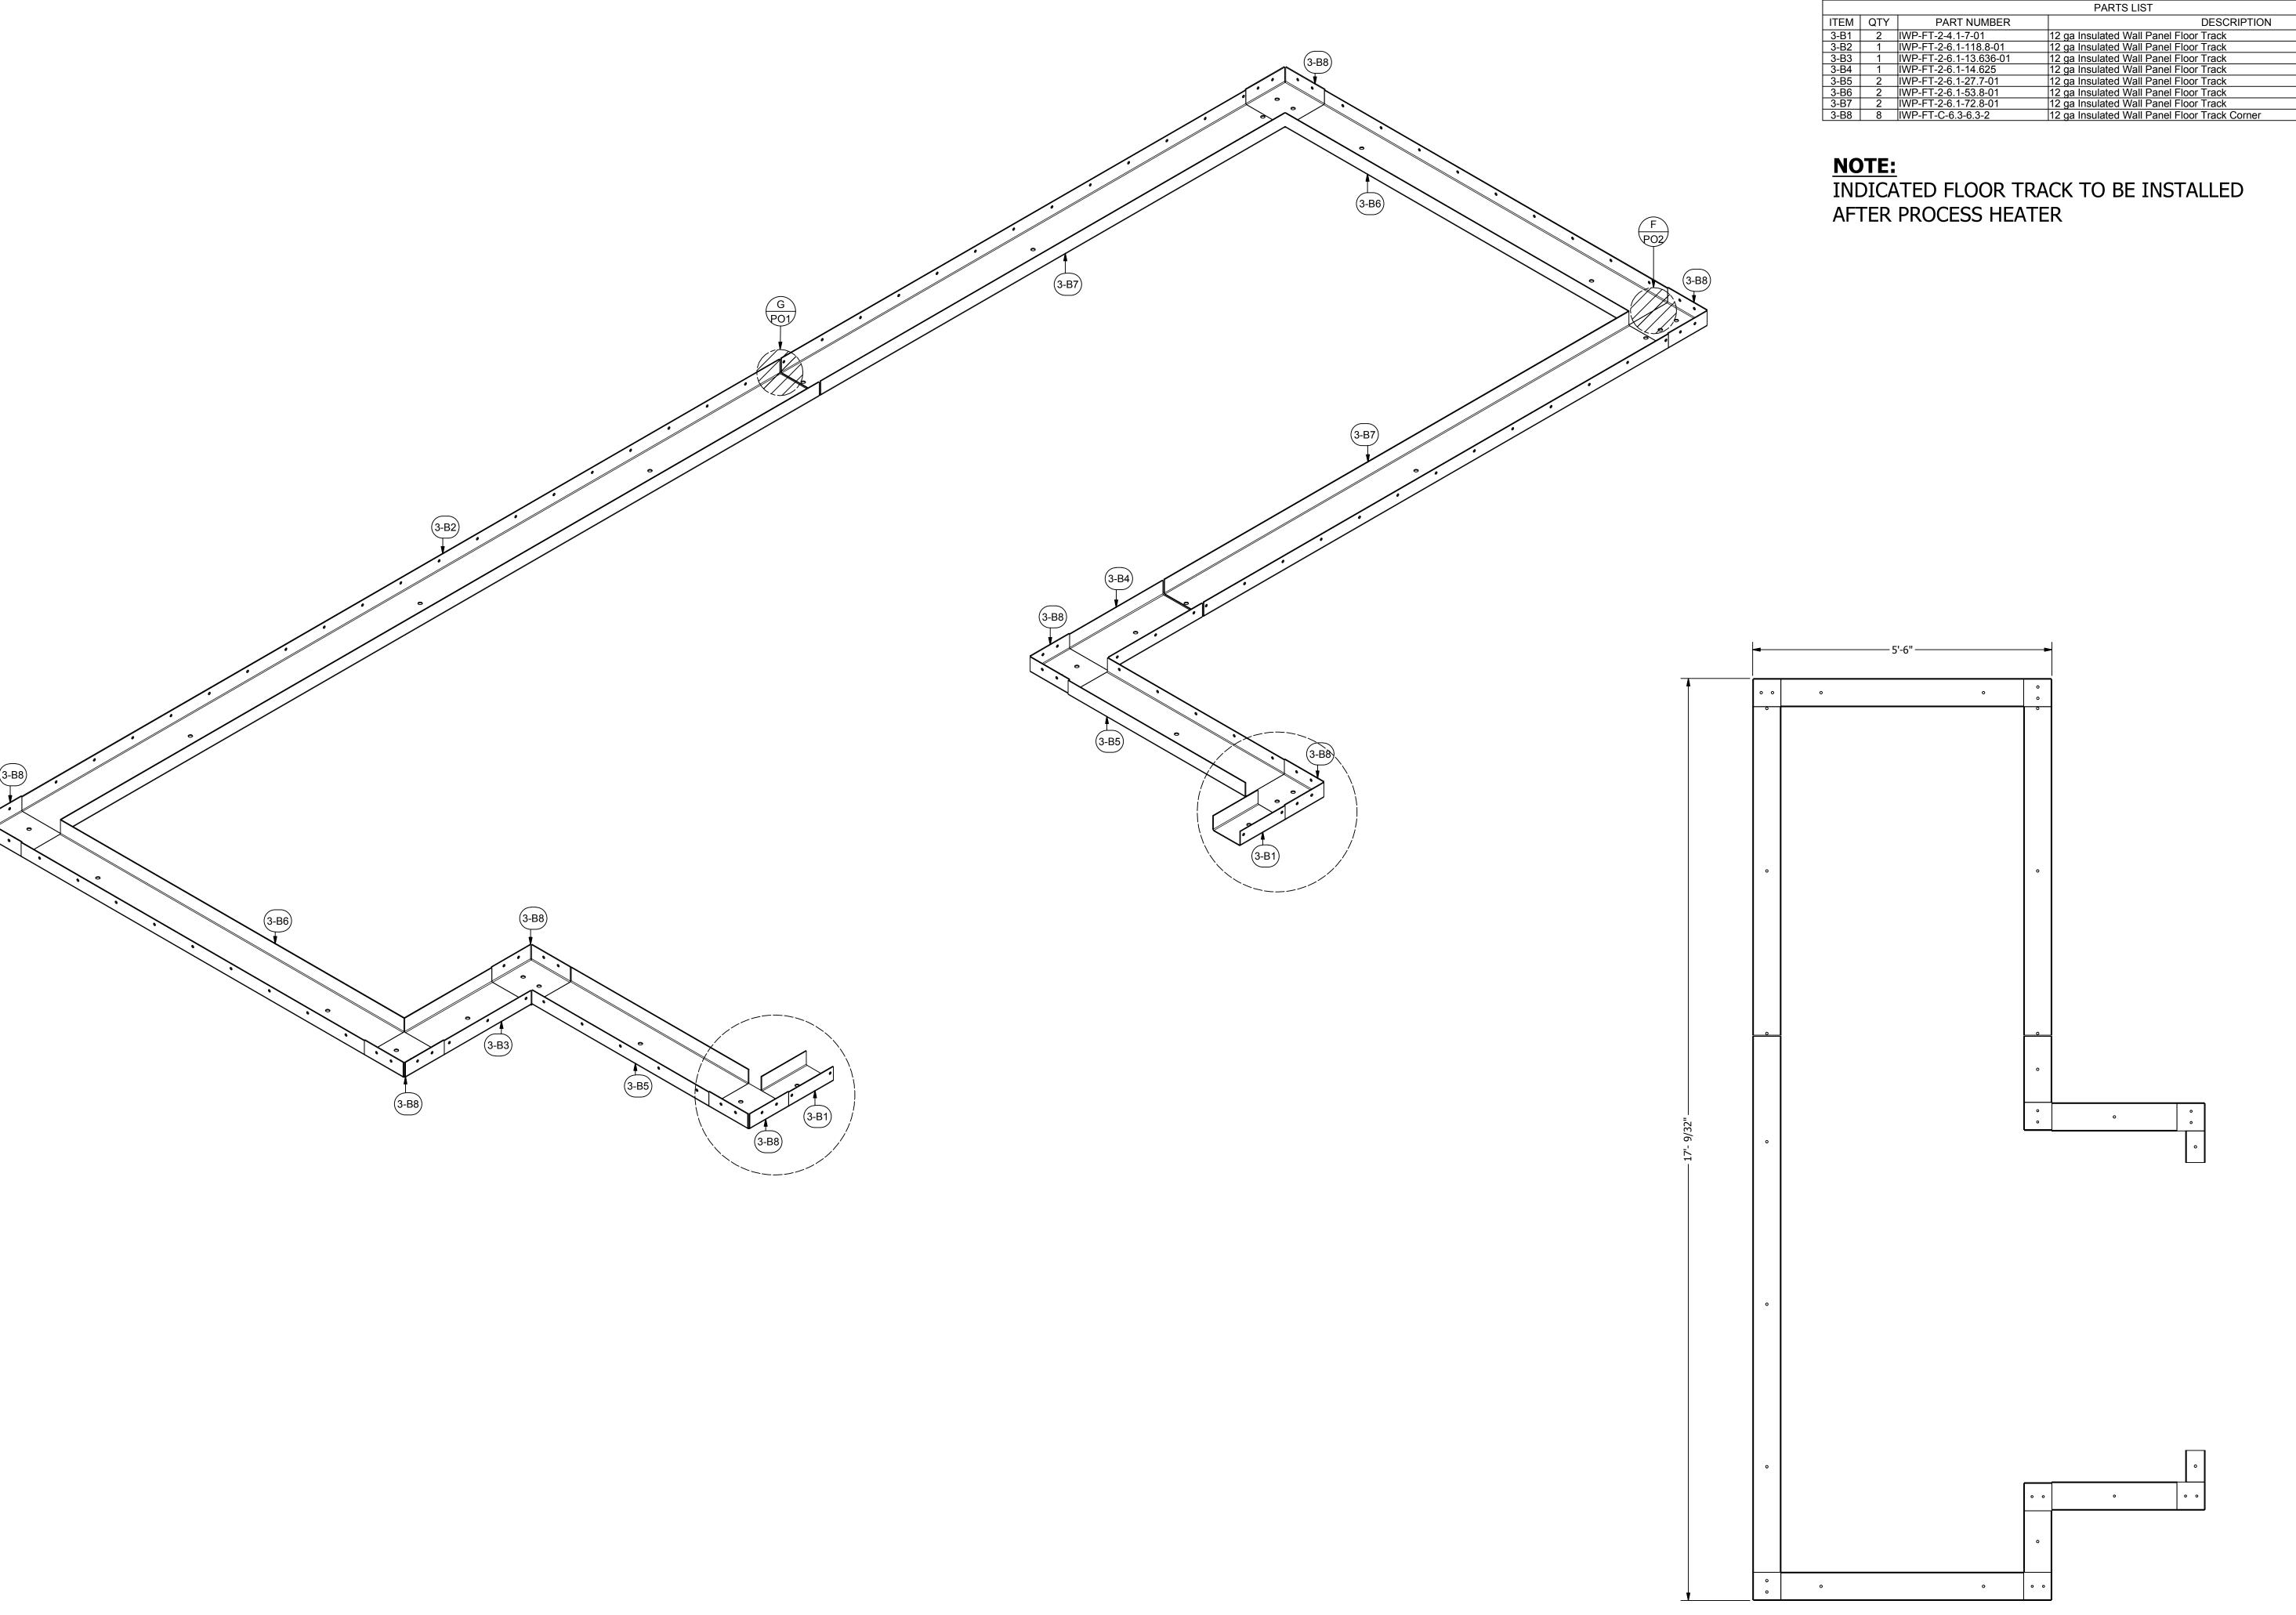

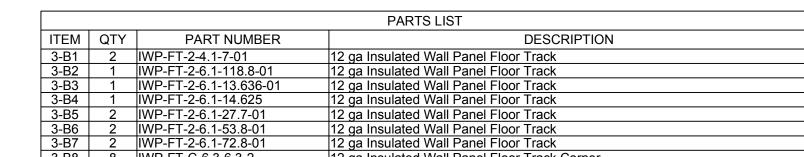

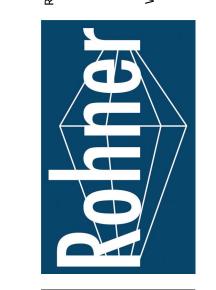2125 SE

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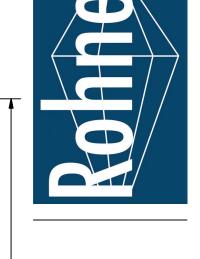
ISSUED DATE: 11/18/16 REV: 16.1 - 11/18/16
DESCRIPTION OF CHANGE(S):
Construction Set

DRAWING TITLE: EXPLODED ISOMETRIC ASSEMBLY DRAWING

NOTE: 1. FIELD CUT AND INSTALL 2" INSULATION IN HORIZONTAL PANEL SEAMS 2. FIELD CUT AND INSTALL 1" INSULATION IN VERTICAL PANEL ENDS 3. FIELD CUT AND INSTALL 2" INSULATION IN VERTICAL SEAM BETWEEN PANELS 4. FIELD CUT AND INSTALL 2" INSULATION IN ALL PRODUCT DOOR FRAME ENDS AND CORNERS OF OVEN (STUFF TIGHTLY LEAVING NO AIR GAPS TO PREVENT BURNOUT)
5. VERIFY HEIGHT OF WALL PANELS WITH EACH PANEL ADDITION (3-C10) (3-C3) (3-C3) (3-C3) (3-C3) (3-C3) (3-C3) (3-C3) 3-C3)-(3-C3) (3-C3) 3-C3 (3-C3) (3-C3) ► (3-C3) THIS SIDEWALL SECTION MUST—
BE INSTALL AFTER PROCESS ON TOP OF PREOCESS
HEATER HEATER PANELS (3-C1,3-C2,3-C7,3-C9) FASTEN
TO OVEN IN DIRECT CONTACT WITH
PROCESS HEATER - THEY MUS BE INSTALLED 3-C5) -(3-C4) AFTER HEATER (3-C9)**►** 3-C2

				PARTS LIST
	ITEM	QTY	PART NUMBER	DESCRIPTION
	3-C1	1	A-IWP-4-66.7-11.6-04	Assy - 4" Insulated Wall Panel - Aluminized
	3-C2	2	A-IWP-4-96-8-04	Assy - 4" Insulated Wall Panel - Aluminized
	3-C3	17	A-IWP-6-120-22.6-01	Assy - Insulated Wall Panel
	3-C4	1	A-IWP-6-15-107-01	Assy - Insulated Wall Panel
	3-C5	1	A-IWP-6-15-107-02	Assy - Insulated Wall Panel
	3-C6	22	A-IWP-6-74-22.6-01	Assy - Insulated Wall Panel
	3-C7	2	A-IWP-6-80-15.75-04	Assy - Insulated Wall Panel
	3-C8	1	A-IWP-6-88-10.8-01	Assy - Insulated Wall Panel
	3-C9	4	A-IWP-6-96-15.75-04	Assy - Insulated Wall Panel
	3-C10	2	A-IWP-EP-6-26.6-120-01	Assy - Insulated Wall Panel
	3-C11	2	A-IWP-EP-6-26.6-74-01	Assy - Insulated Wall Panel
	H7	450	25C100SWHZ	1/4-20x1", Self-drilling Screw
	H23	200	MWBR002	RHT80 8# 2" x 24" x48" insulation
[H24	125	MWBR020	RHT80 8# 1" X 24" X 48" Insulation

15 · 10 · 34* 16 · 2 · 34* 16 · 2 · 34* 17 · 2 · 34* 16 · 3 · 34* 17 · 2 · 34* 18 · 10 · 34* 19 · 4 · 34* 19 · 4 · 34* 10 · 3 · 34*				
3/4" 19-4 3/4" 19-6 3/4" 19-6 3/4" 19-6 3/4" 19-7 3/4" 19-6 3/4" 19-7 3/4" 19-7 3/4" 19-8 3/4" 19-9				
3/4" ————————————————————————————————————	1/32"—			
12'-4 3/4" -10'-7		-15'-10 3/4"		<u> </u>
8-103/4" -1-103/4" -				8'-10 21/32" 8'-10 -17 3/4" 11'-7 3/4" 11'-7 3/4"




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ISSUED DATE: 11/18/16 REV: 16.1 - 11/18/16 DESCRIPTION OF CHANGE(S): Construction Set

DRAWING TITLE: EXPLODED ISOMETRIC ASSEMBLY DRAWING



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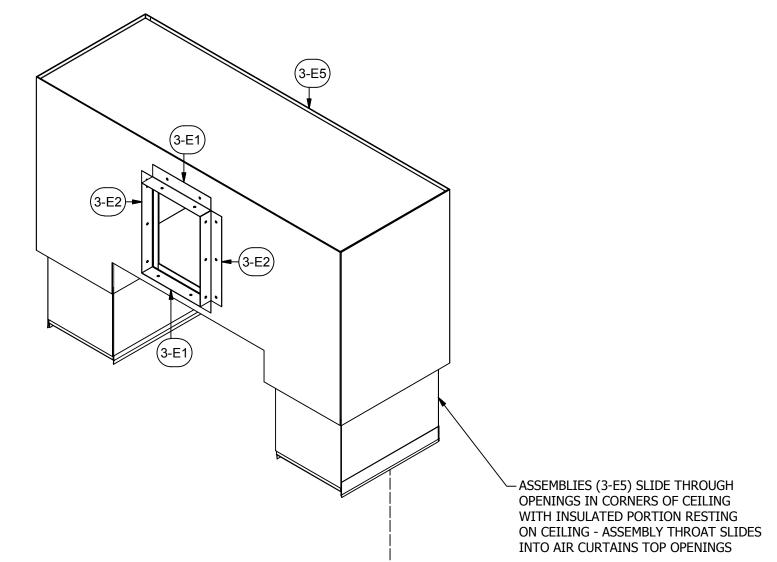
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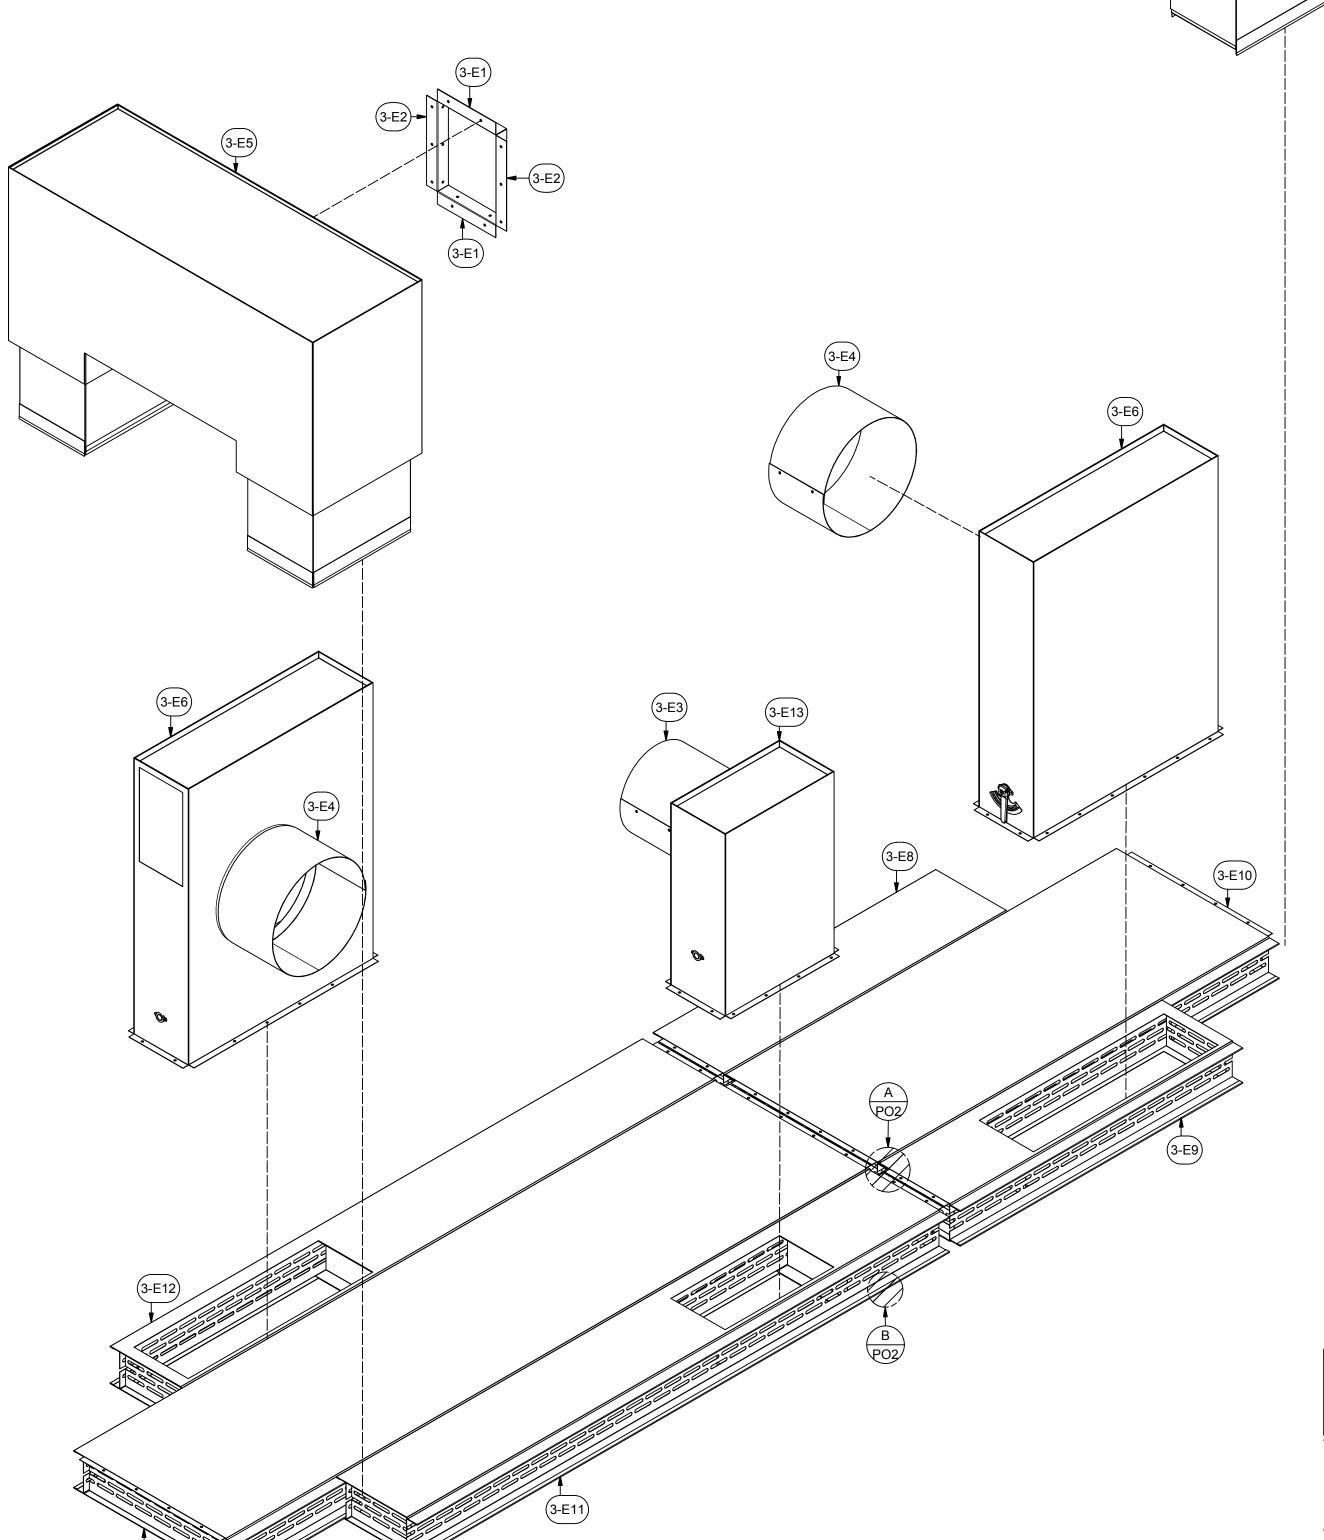
1. FIELD CUT AND INSTALL 2" INSULATION IN HORIZONTAL PANEL SEAMS

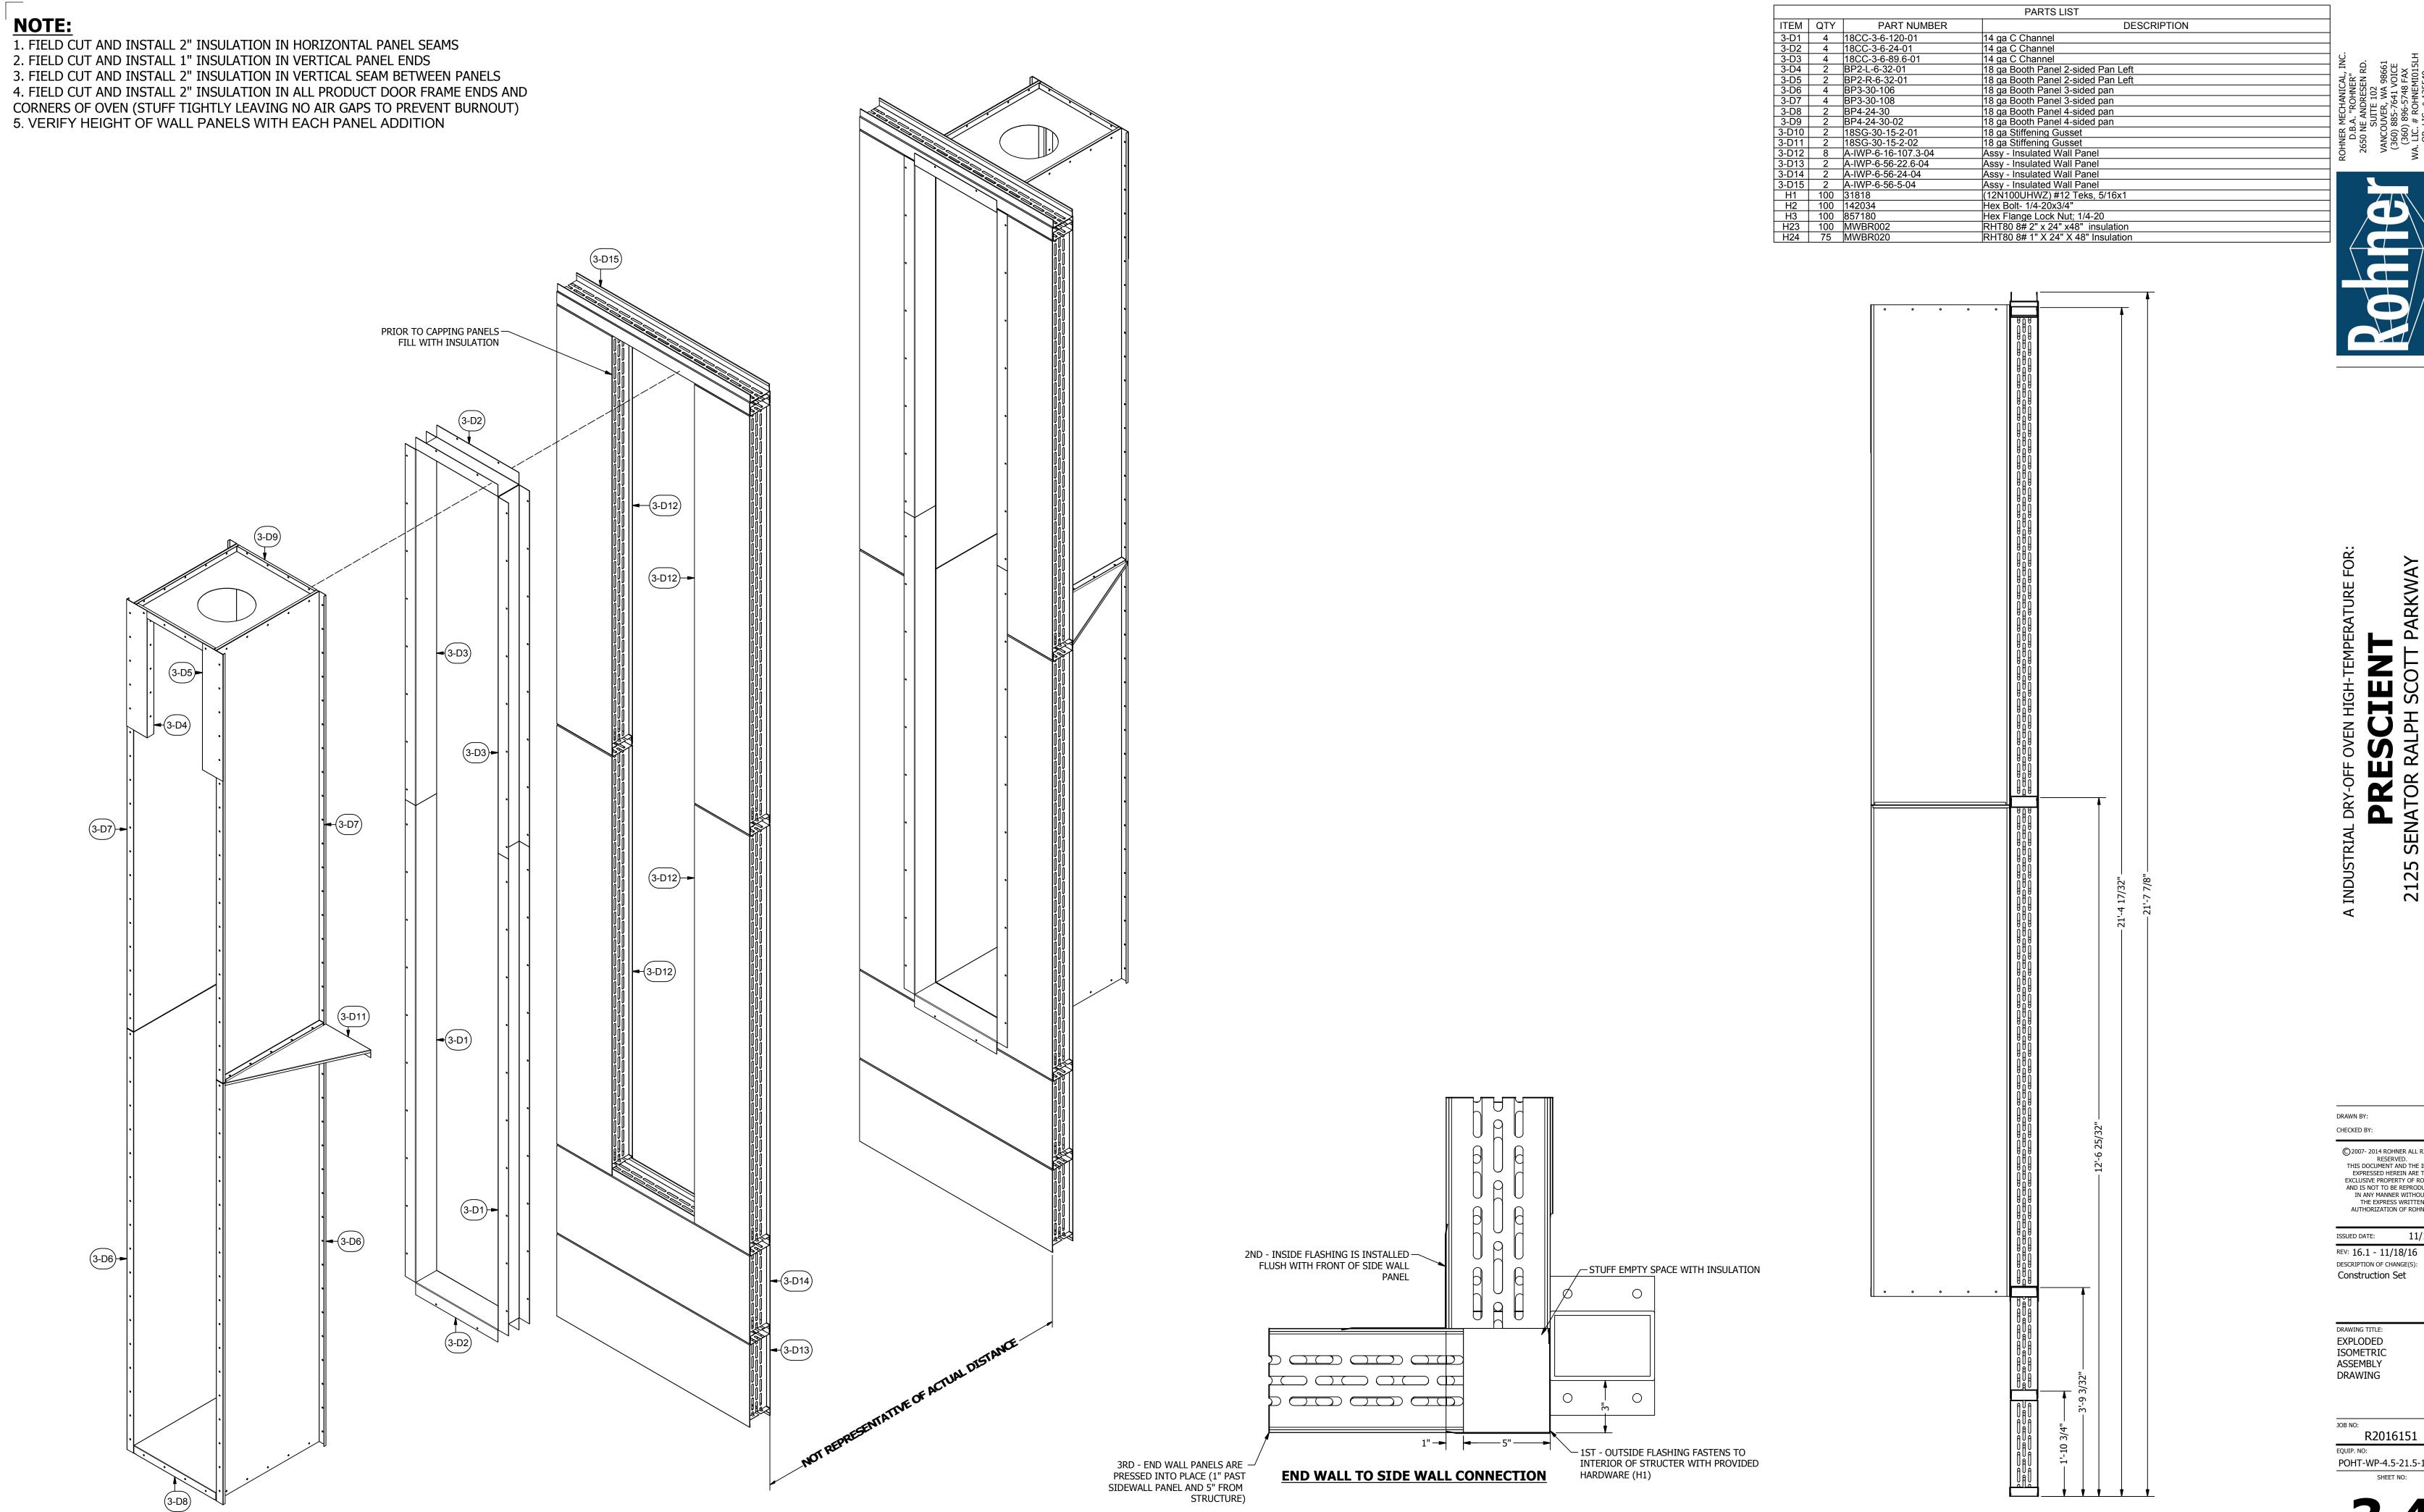2. FIELD CUT AND INSTALL 1" INSULATION IN VERTICAL PANEL ENDS

3. FIELD CUT AND INSTALL 2" INSULATION IN VERTICAL SEAM BETWEEN PANELS
4. FIELD CUT AND INSTALL 2" INSULATION IN ALL PRODUCT DOOR FRAME ENDS AND

CORNERS OF OVEN (STUFF TIGHTLY LEAVING NO AIR GAPS TO PREVENT BURNOUT)





			PARTS LIST
ITEM	QTY	PART NUMBER	DESCRIPTION
3-E1	4	18A-2-2-10.7-01	18 ga Angle
3-E2	4	18A-2-2-14.3-01	18 ga Angle
3-E3	1	20D-13.5-12-01	20 ga Duct
3-E4	2	20D-17-10-01	20 ga Duct
3-E5	2	A-AC-IDB-56-37-20-01	Assy - Air Curtain Insulated Discharge Box
3-E6	2	A-EXB-10-34-40-01	Assy - Exhaust Box
3-E7	1	A-IWP-6-120-30-01	Assy - Insulated Wall Panel
3-E8	1	A-IWP-6-52-15-01	Assy - Insulated Wall Panel
3-E9	1	A-IWP-6-52-15-02	Assy - Insulated Wall Panel
3-E10	1	A-IWP-6-74-30-01	Assy - Insulated Wall Panel
3-E11	1	A-IWP-6-99-15-02	Assy - Insulated Wall Panel
3-E12	1	A-IWP-6-99-15-03	Assy - Insulated Wall Panel
3-E13	1	A-EXB-10-20-28-01	Assy - Exhaust Box
H1	100	31818	(12N100UHWZ) #12 Teks, 5/16x1
H7	36	25C100SWHZ	1/4-20x1", Self-drilling Screw
H23	125	MWBR002	RHT80 8# 2" x 24" x48" insulation
H24	65	MWBR020	RHT80 8# 1" X 24" X 48" Insulation

-- 4'-8 19/32" —

----- 3'-7 9/32"*-*----

1'-2 15/16" —



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2125

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ISSUED DATE: 11/18/16 REV: 16.1 - 11/18/16
DESCRIPTION OF CHANGE(S):

Construction Set

DRAWING TITLE: **EXPLODED** ISOMETRIC ASSEMBLY DRAWING


R2016151

POHT-WP-4.5-21.5-17-01

NOTE:

1. FEMALE END OF THE DUCT SLIPS OVER FLANGED MALE END AND IS FASTENED WITH #12 X 3/4" TEK SCREWS 6" O.C.

PARTS LIST			_IST
ITEM	QTY	PART NUMBER	DESCRIPTION
3-F1	1	A-18OD-30-71-13-01	Assy - 18 ga Oven Duct
3-F2	1	A-18OD-31-30-48-01	Assy - 18 ga Oven Duct
3-F3	1	A-18OD-31-30-48-02	Assy - 18 ga Oven Duct
3-F4	1	A-18OD-E-31-30-26-01	Assy - 18 ga Oven Duct
3-F5	1	A-18OD-E-31-30-30-01	Assy - 18 ga Oven Duct
H1	350	31818	(12N100UHWZ) #12 Teks, 5/16x1

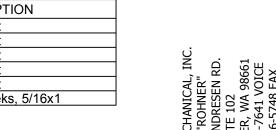





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DESCRIPTION OF CHANGE(S):
Construction Set


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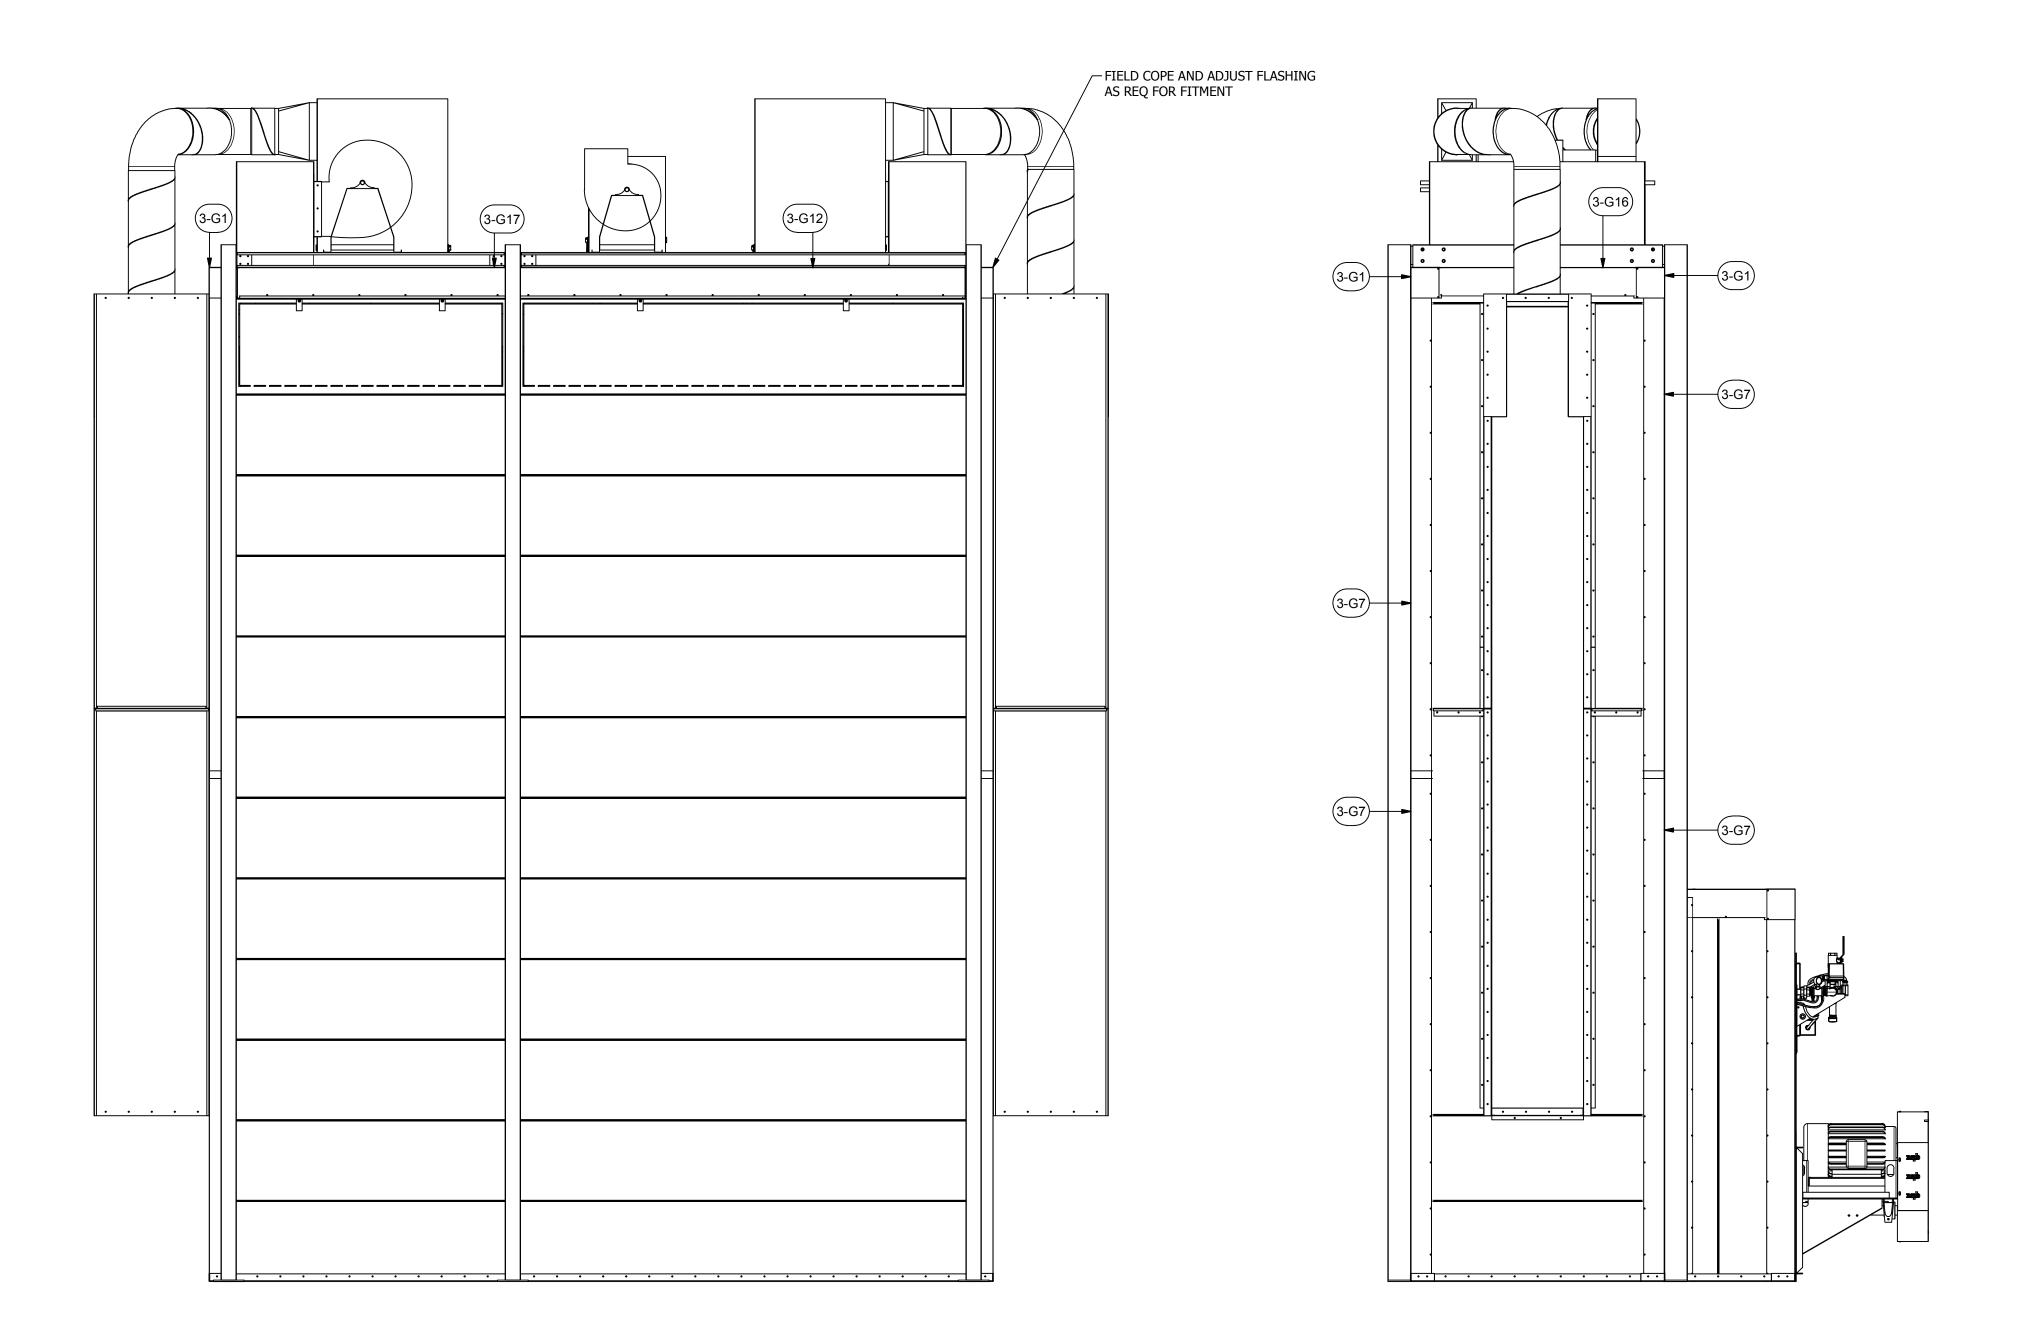





EXTERIOR FLASHING FASTENS TO OVEN WITH PROVIDED HARDWARE (H1) 12" O.C.

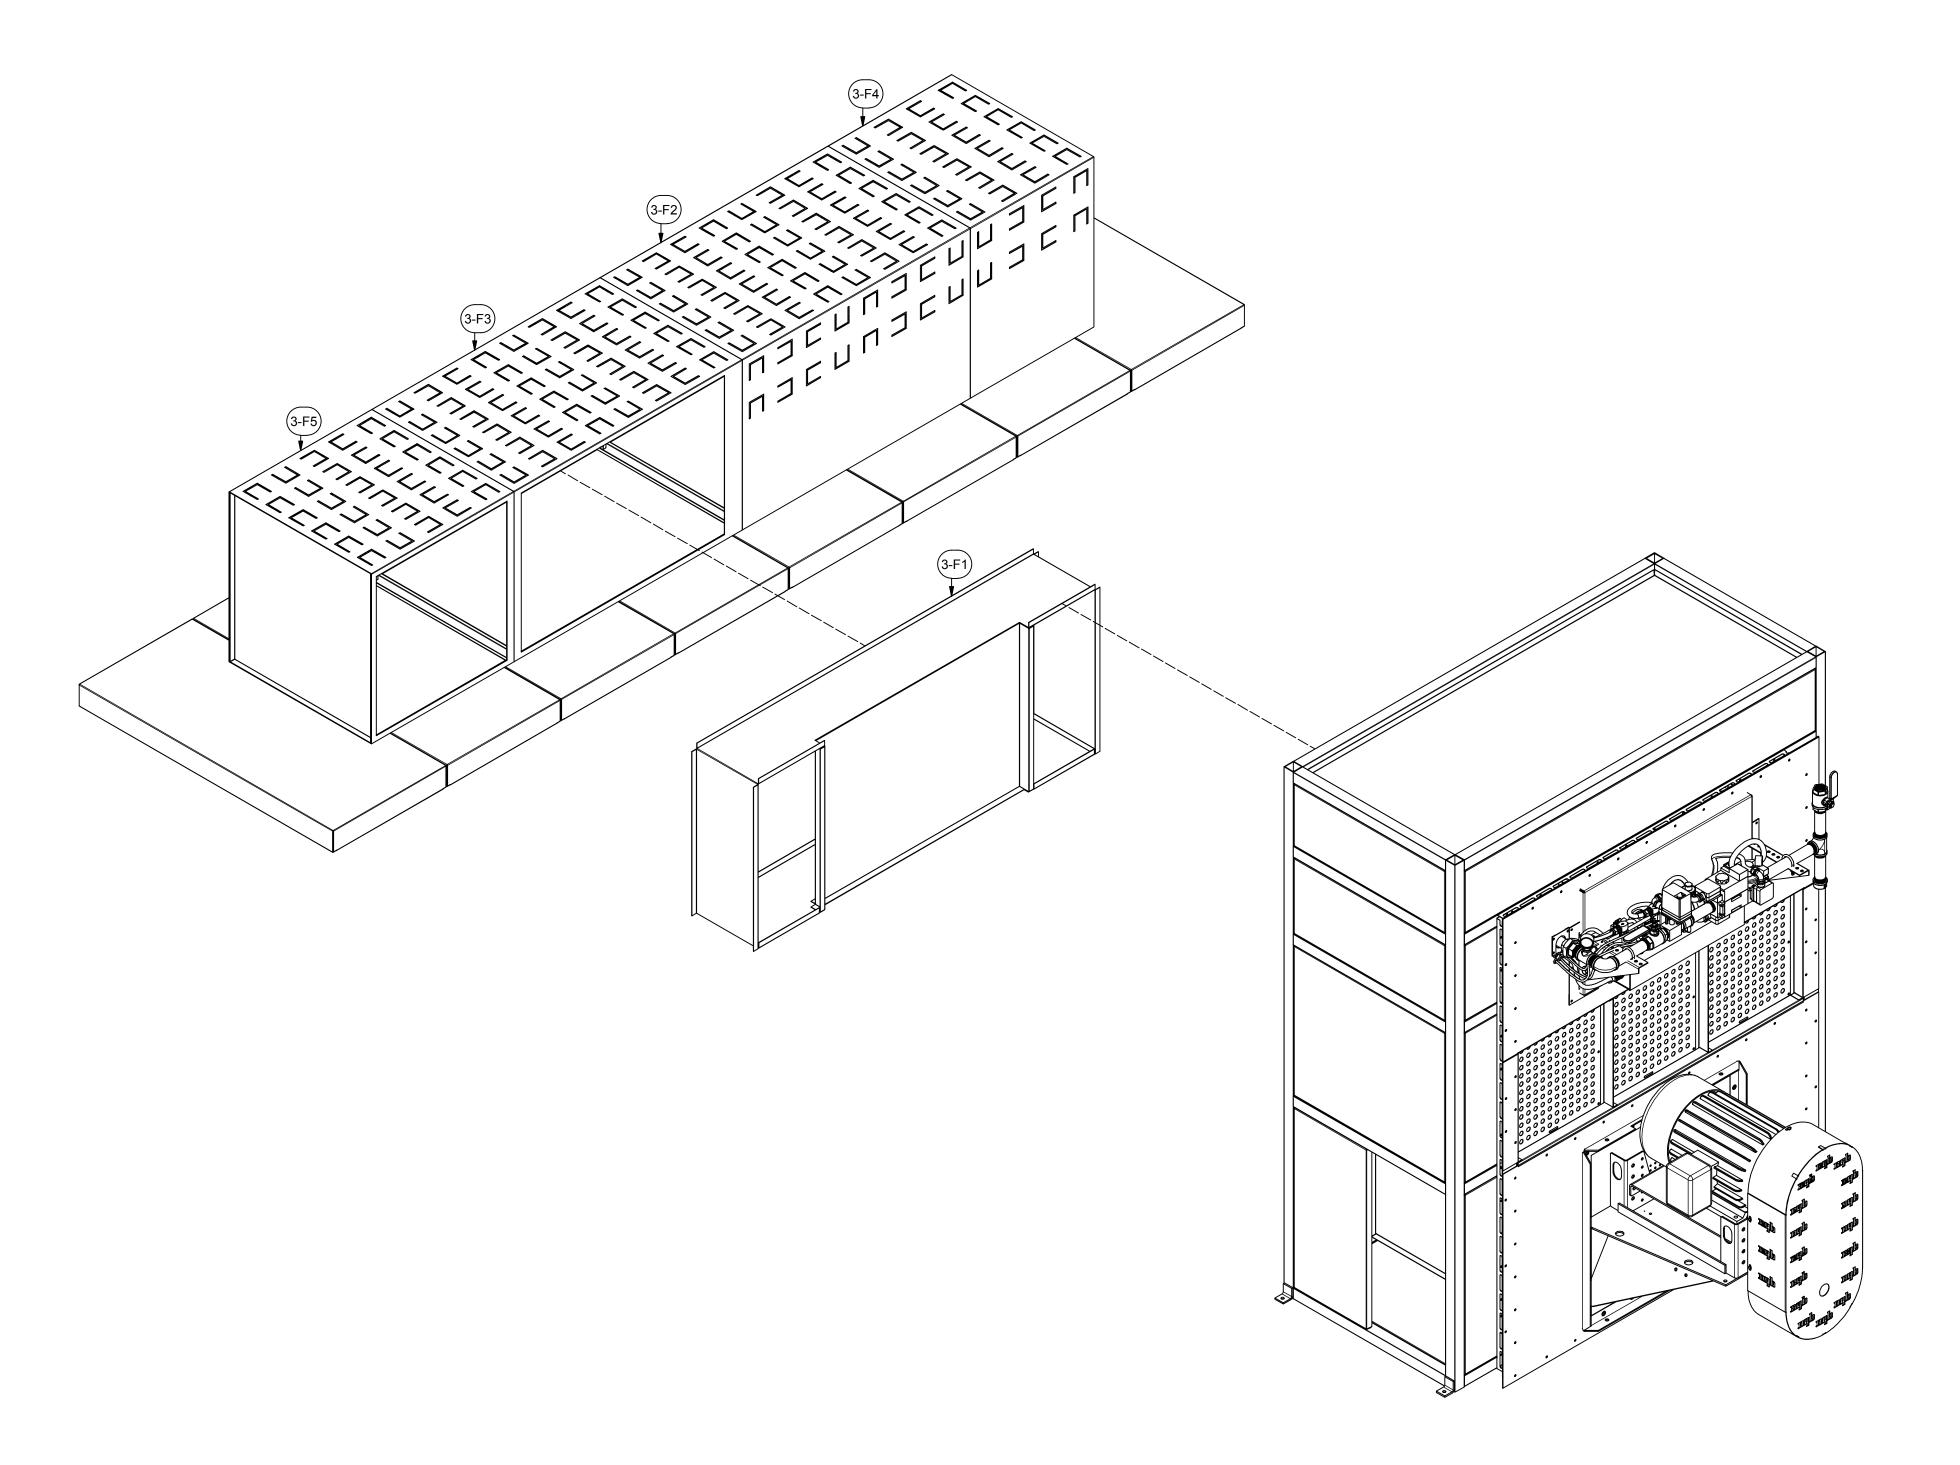			PARTS LIST
ITEM	QTY	PART NUMBER	DESCRIPTION
3-G1	6	20RI-CCA-8-8-8-02	20 ga Rigid Insulation Corner Cap Angle
3-G2	4	20RI-C-6-132-01	20 ga Rigid Insulation- Cap
3-G3	1	20RI-C-6-52-01	20 ga Rigid Insulation- Cap
3-G4	2	20RI-C-8-106-01	20 ga Rigid Insulation- Cap
3-G5	1	20RI-C-8-90-01	20 ga Rigid Insulation- Cap
3-G6	2	20RI-CA-6-3-52-02	20 ga Rigid Insulation- Cap Angle
3-G7	8	20RI-CA-6-6-132-01	20 ga Rigid Insulation- Cap Angle
3-G8	8	20RI-CA-6-6-132-02	20 ga Rigid Insulation- Cap Angle
3-G9	4	20RI-CA-6-6-76-02	20 ga Rigid Insulation- Cap Angle
3-G10	2	20RI-CA-8-8-100-01	20 ga Rigid Insulation- Cap Angle
3-G11	2	20RI-CA-8-8-100-02	20 ga Rigid Insulation- Cap Angle
3-G12	2	20RI-CA-8-8-118-01	20 ga Rigid Insulation- Cap Angle
3-G13	2	20RI-CA-8-8-31-01	20 ga Rigid Insulation- Cap Angle
3-G14	1	20RI-CA-8-8-32-02	20 ga Rigid Insulation- Cap Angle
3-G15	1	20RI-CA-8-8-32-03	20 ga Rigid Insulation- Cap Angle
3-G16	2	20RI-CA-8-8-52-01	20 ga Rigid Insulation- Cap Angle
3-G17	2	20RI-CA-8-8-72-01	20 ga Rigid Insulation- Cap Angle
3-G18	1	20RI-CA-8-8-86-01	20 ga Rigid Insulation- Cap Angle
3-G19	1	20RI-CA-8-8-86-02	20 ga Rigid Insulation- Cap Angle
H1	1100	31818	(12N100UHWZ) #12 Teks, 5/16x1
H23	330	MWBR002	RHT80 8# 2" x 24" x48" insulation
384	2	C-COS 12 ATTO	Custom- Duct- 12" Air Tight Take Off

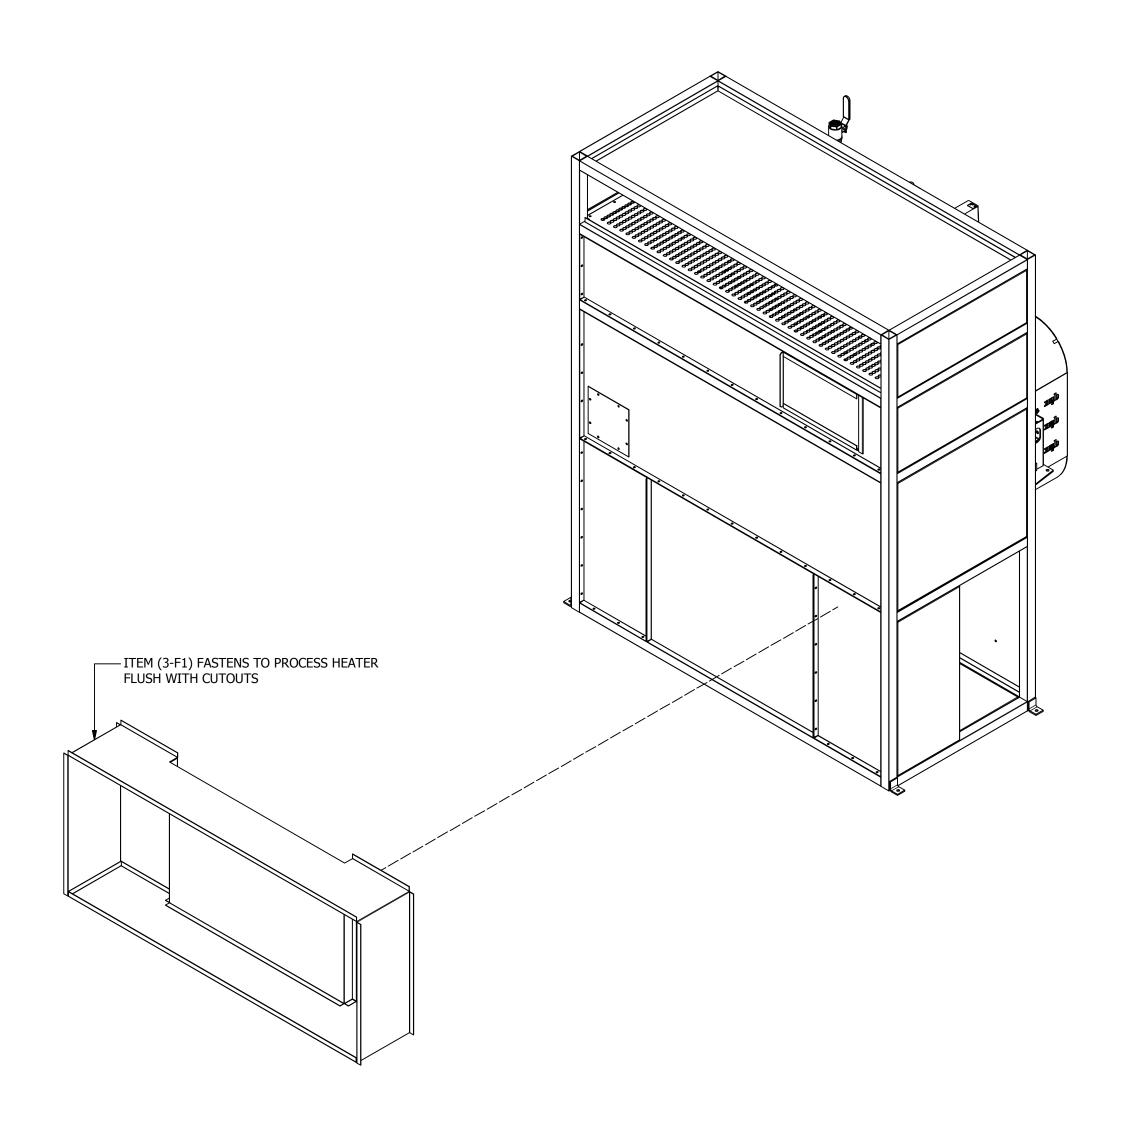

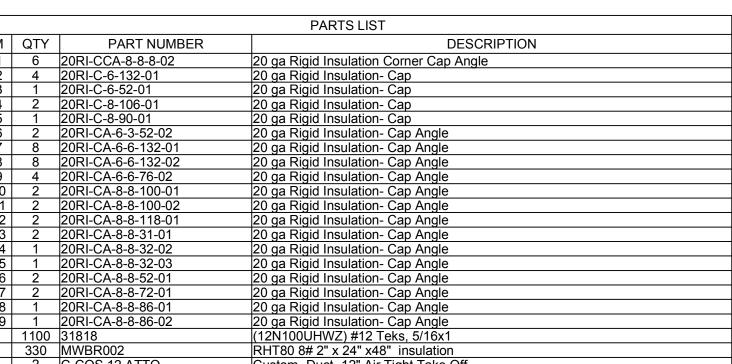

EXTERIOR FLASHING

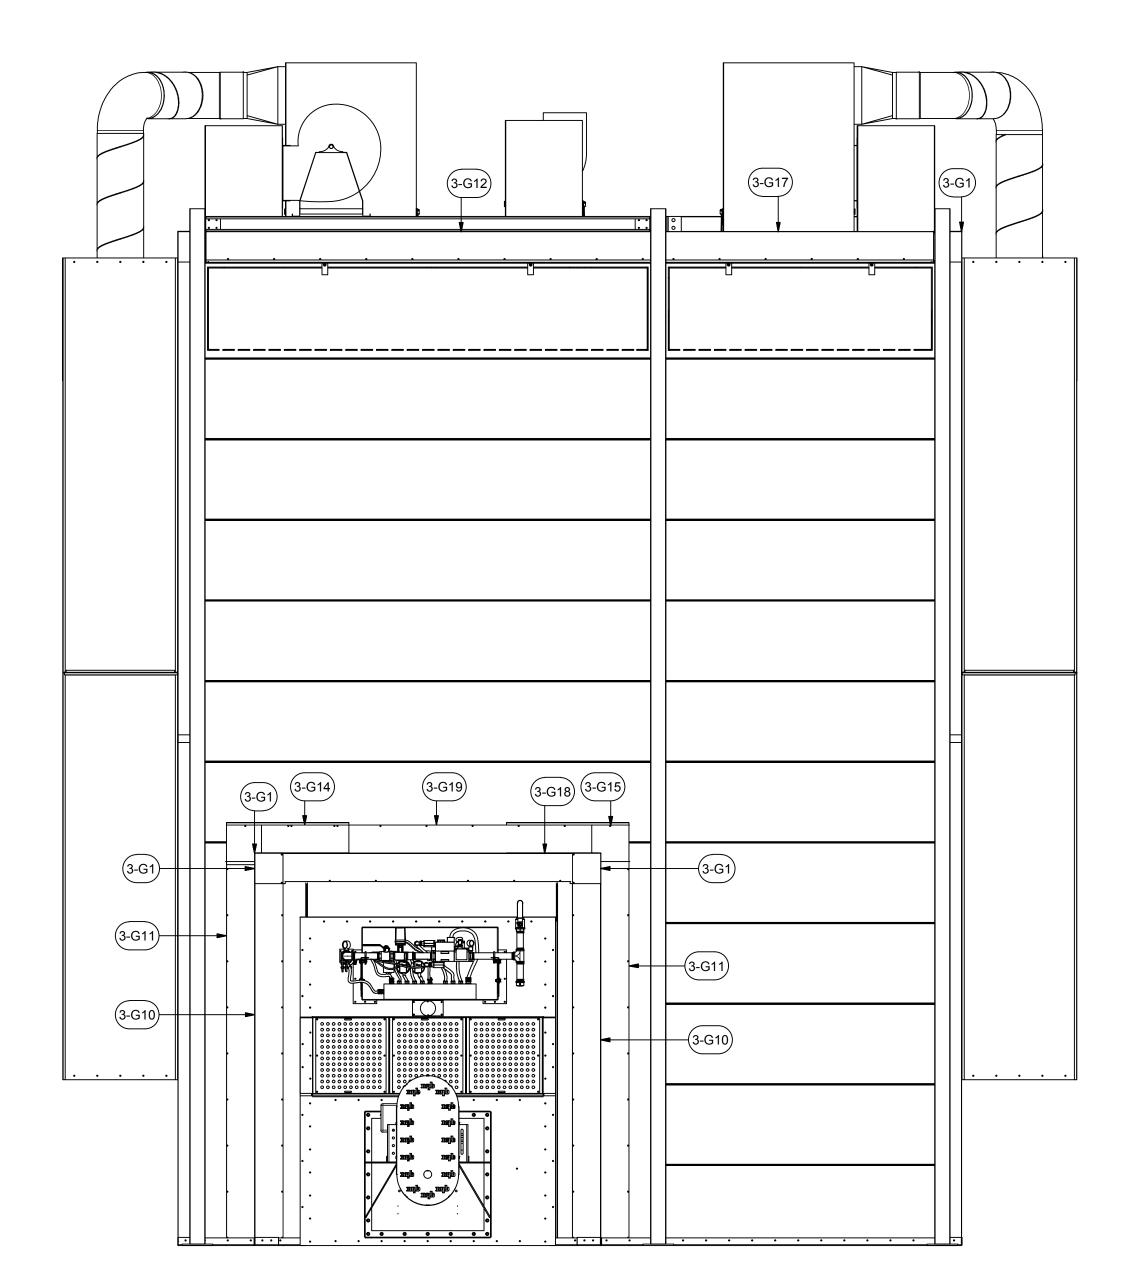


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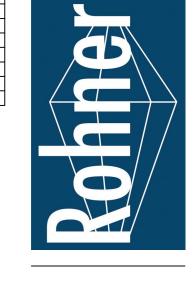
2125 SE


REV: 16.1 - 11/18/16
DESCRIPTION OF CHANGE(S):
Construction Set


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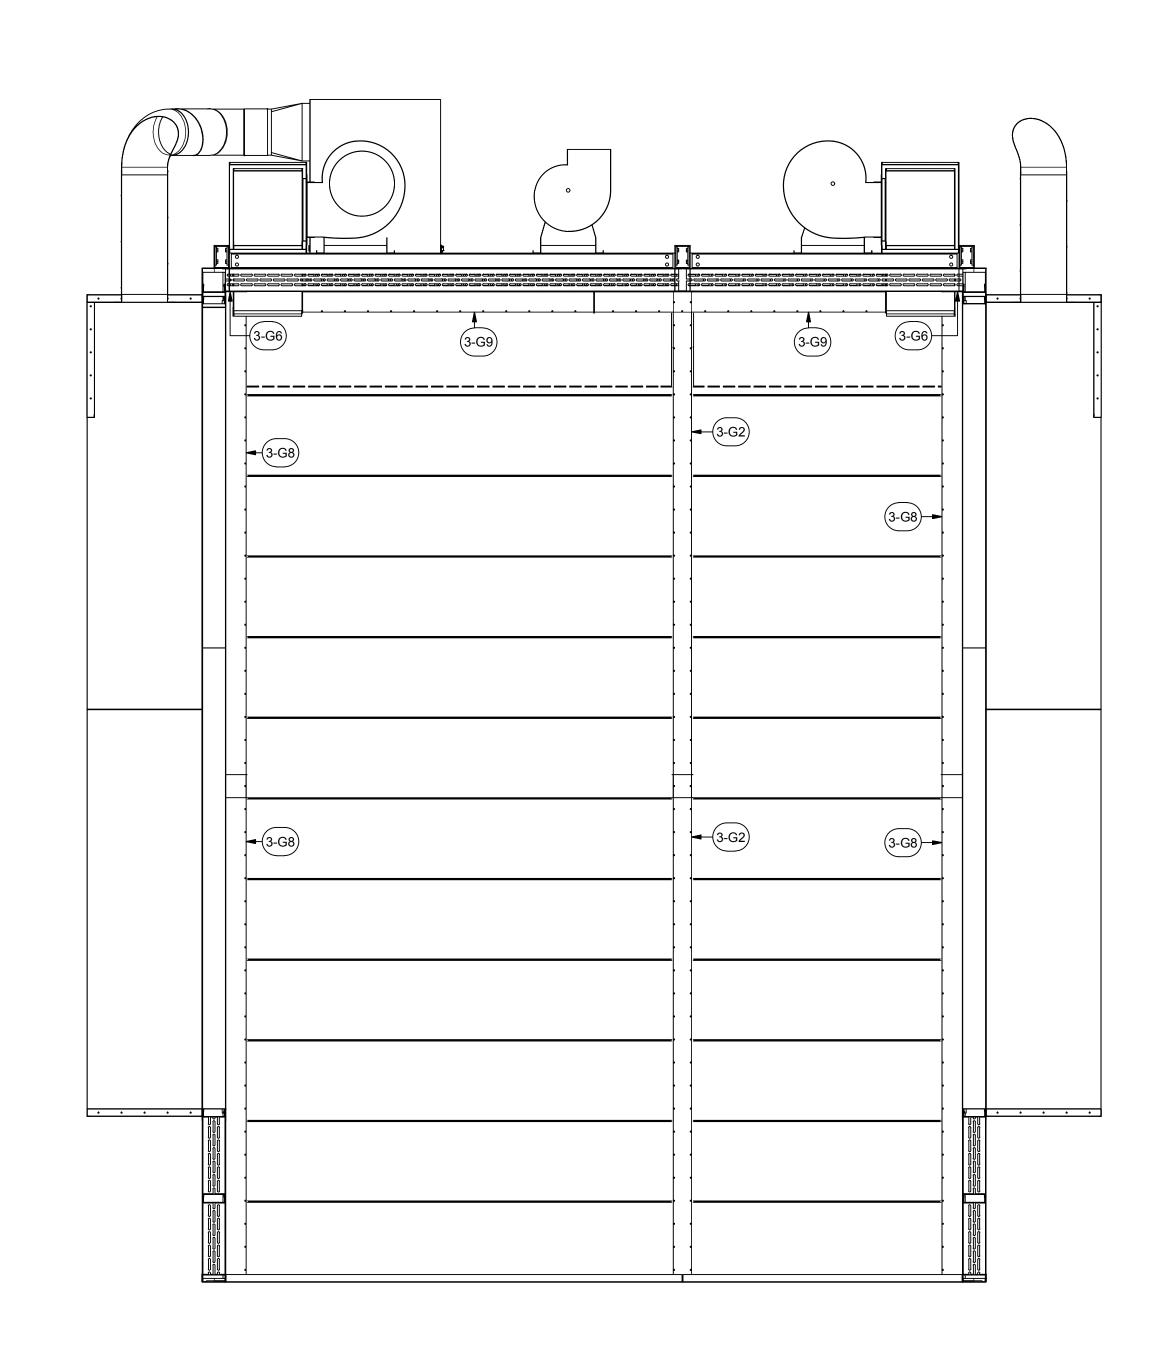
			PARTS LIST
ITEM	QTY	PART NUMBER	DESCRIPTION
3-G1	6	20RI-CCA-8-8-8-02	20 ga Rigid Insulation Corner Cap Angle
3-G2	4	20RI-C-6-132-01	20 ga Rigid Insulation- Cap
3-G3	1	20RI-C-6-52-01	20 ga Rigid Insulation- Cap
3-G4	2	20RI-C-8-106-01	20 ga Rigid Insulation- Cap
3-G5	1	20RI-C-8-90-01	20 ga Rigid Insulation- Cap
3-G6	2	20RI-CA-6-3-52-02	20 ga Rigid Insulation- Cap Angle
3-G7	8	20RI-CA-6-6-132-01	20 ga Rigid Insulation- Cap Angle
3-G8	8	20RI-CA-6-6-132-02	20 ga Rigid Insulation- Cap Angle
3-G9	4	20RI-CA-6-6-76-02	20 ga Rigid Insulation- Cap Angle
3-G10	2	20RI-CA-8-8-100-01	20 ga Rigid Insulation- Cap Angle
3-G11	2	20RI-CA-8-8-100-02	20 ga Rigid Insulation- Cap Angle
3-G12	2	20RI-CA-8-8-118-01	20 ga Rigid Insulation- Cap Angle
3-G13	2	20RI-CA-8-8-31-01	20 ga Rigid Insulation- Cap Angle
3-G14	1	20RI-CA-8-8-32-02	20 ga Rigid Insulation- Cap Angle
3-G15	1	20RI-CA-8-8-32-03	20 ga Rigid Insulation- Cap Angle
3-G16	2	20RI-CA-8-8-52-01	20 ga Rigid Insulation- Cap Angle
3-G17	2	20RI-CA-8-8-72-01	20 ga Rigid Insulation- Cap Angle
3-G18	1	20RI-CA-8-8-86-01	20 ga Rigid Insulation- Cap Angle
3-G19	1	20RI-CA-8-8-86-02	20 ga Rigid Insulation- Cap Angle
H1	1100	31818	(12N100UHWZ) #12 Teks, 5/16x1
H23	330	MWBR002	RHT80 8# 2" x 24" x48" insulation





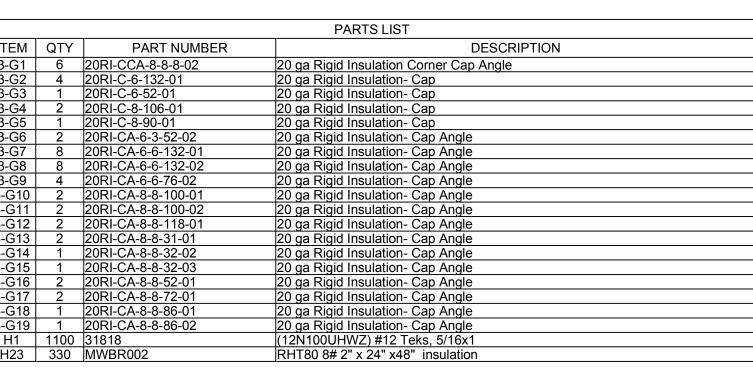

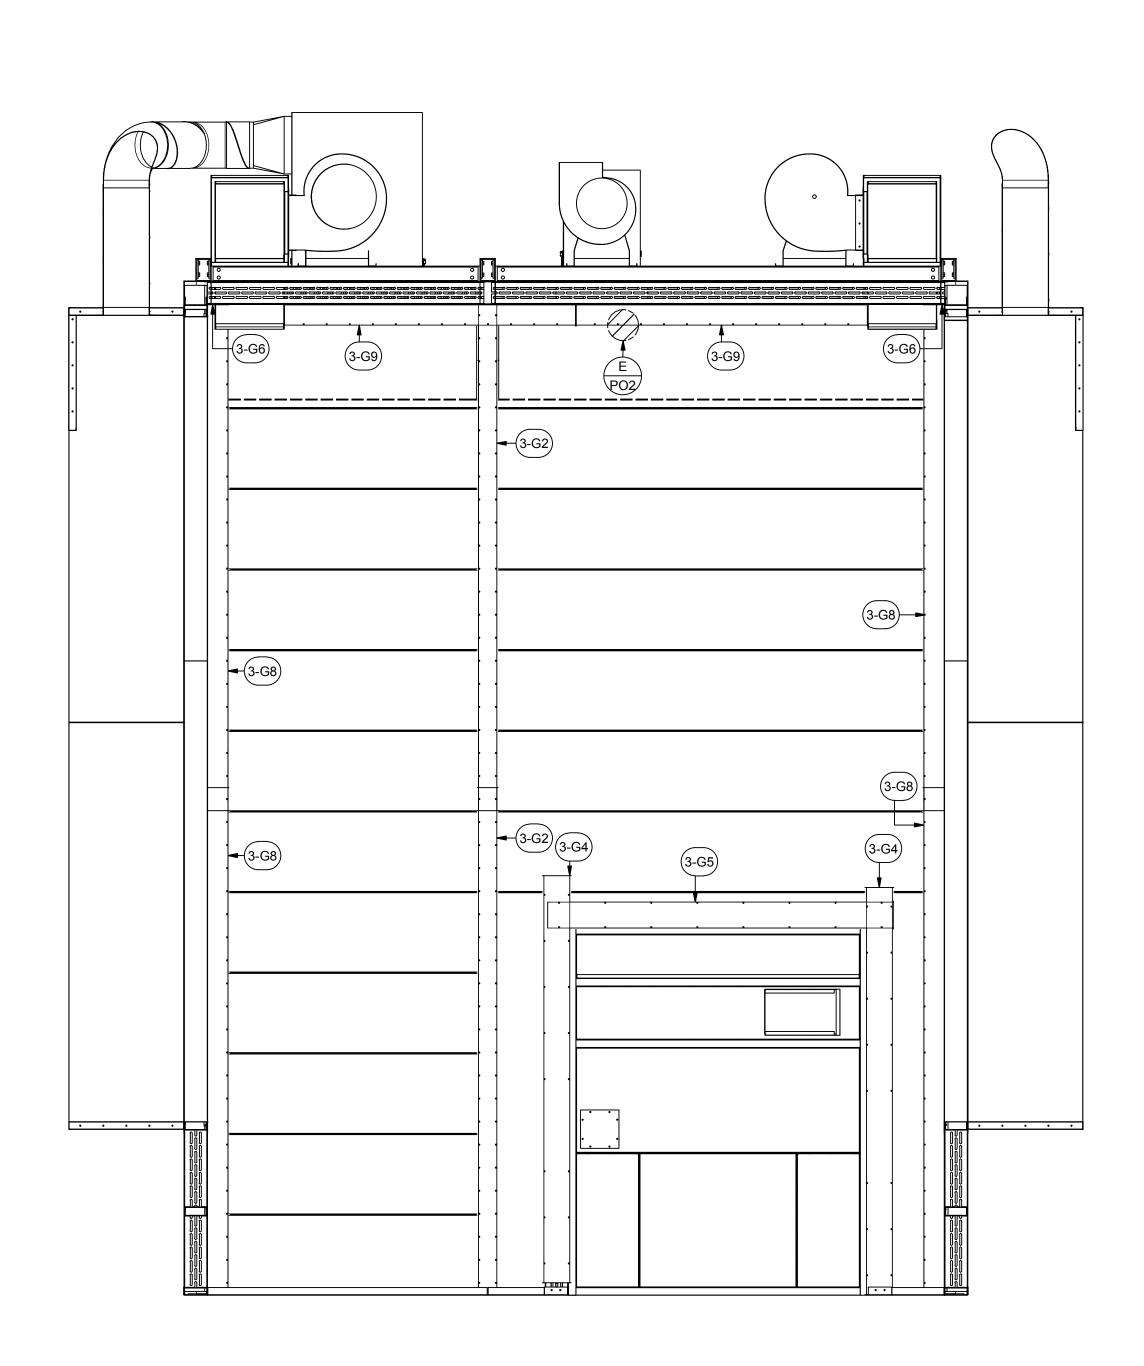

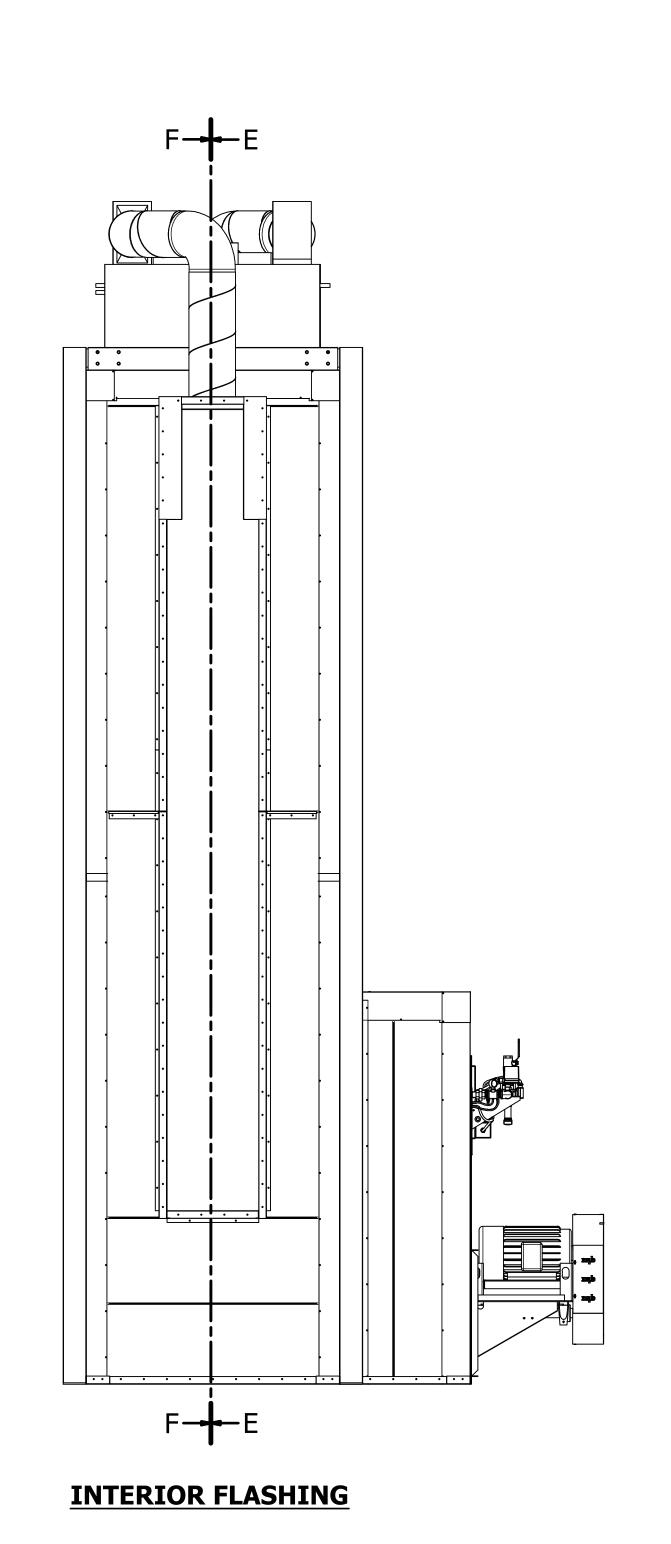


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REV: 16.1 - 11/18/16
DESCRIPTION OF CHANGE(S):
Construction Set

DRAWING TITLE: EXPLODED ISOMETRIC ASSEMBLY DRAWING

R2016151 EQUIP. NO:
POHT-WP-4.5-21.5-17-01
SHEET NO:



AIR CURTAINS ANGLE NOZZLES
MAY BE REVERSED TO CHANGE
AIR FLOW DIRECTION

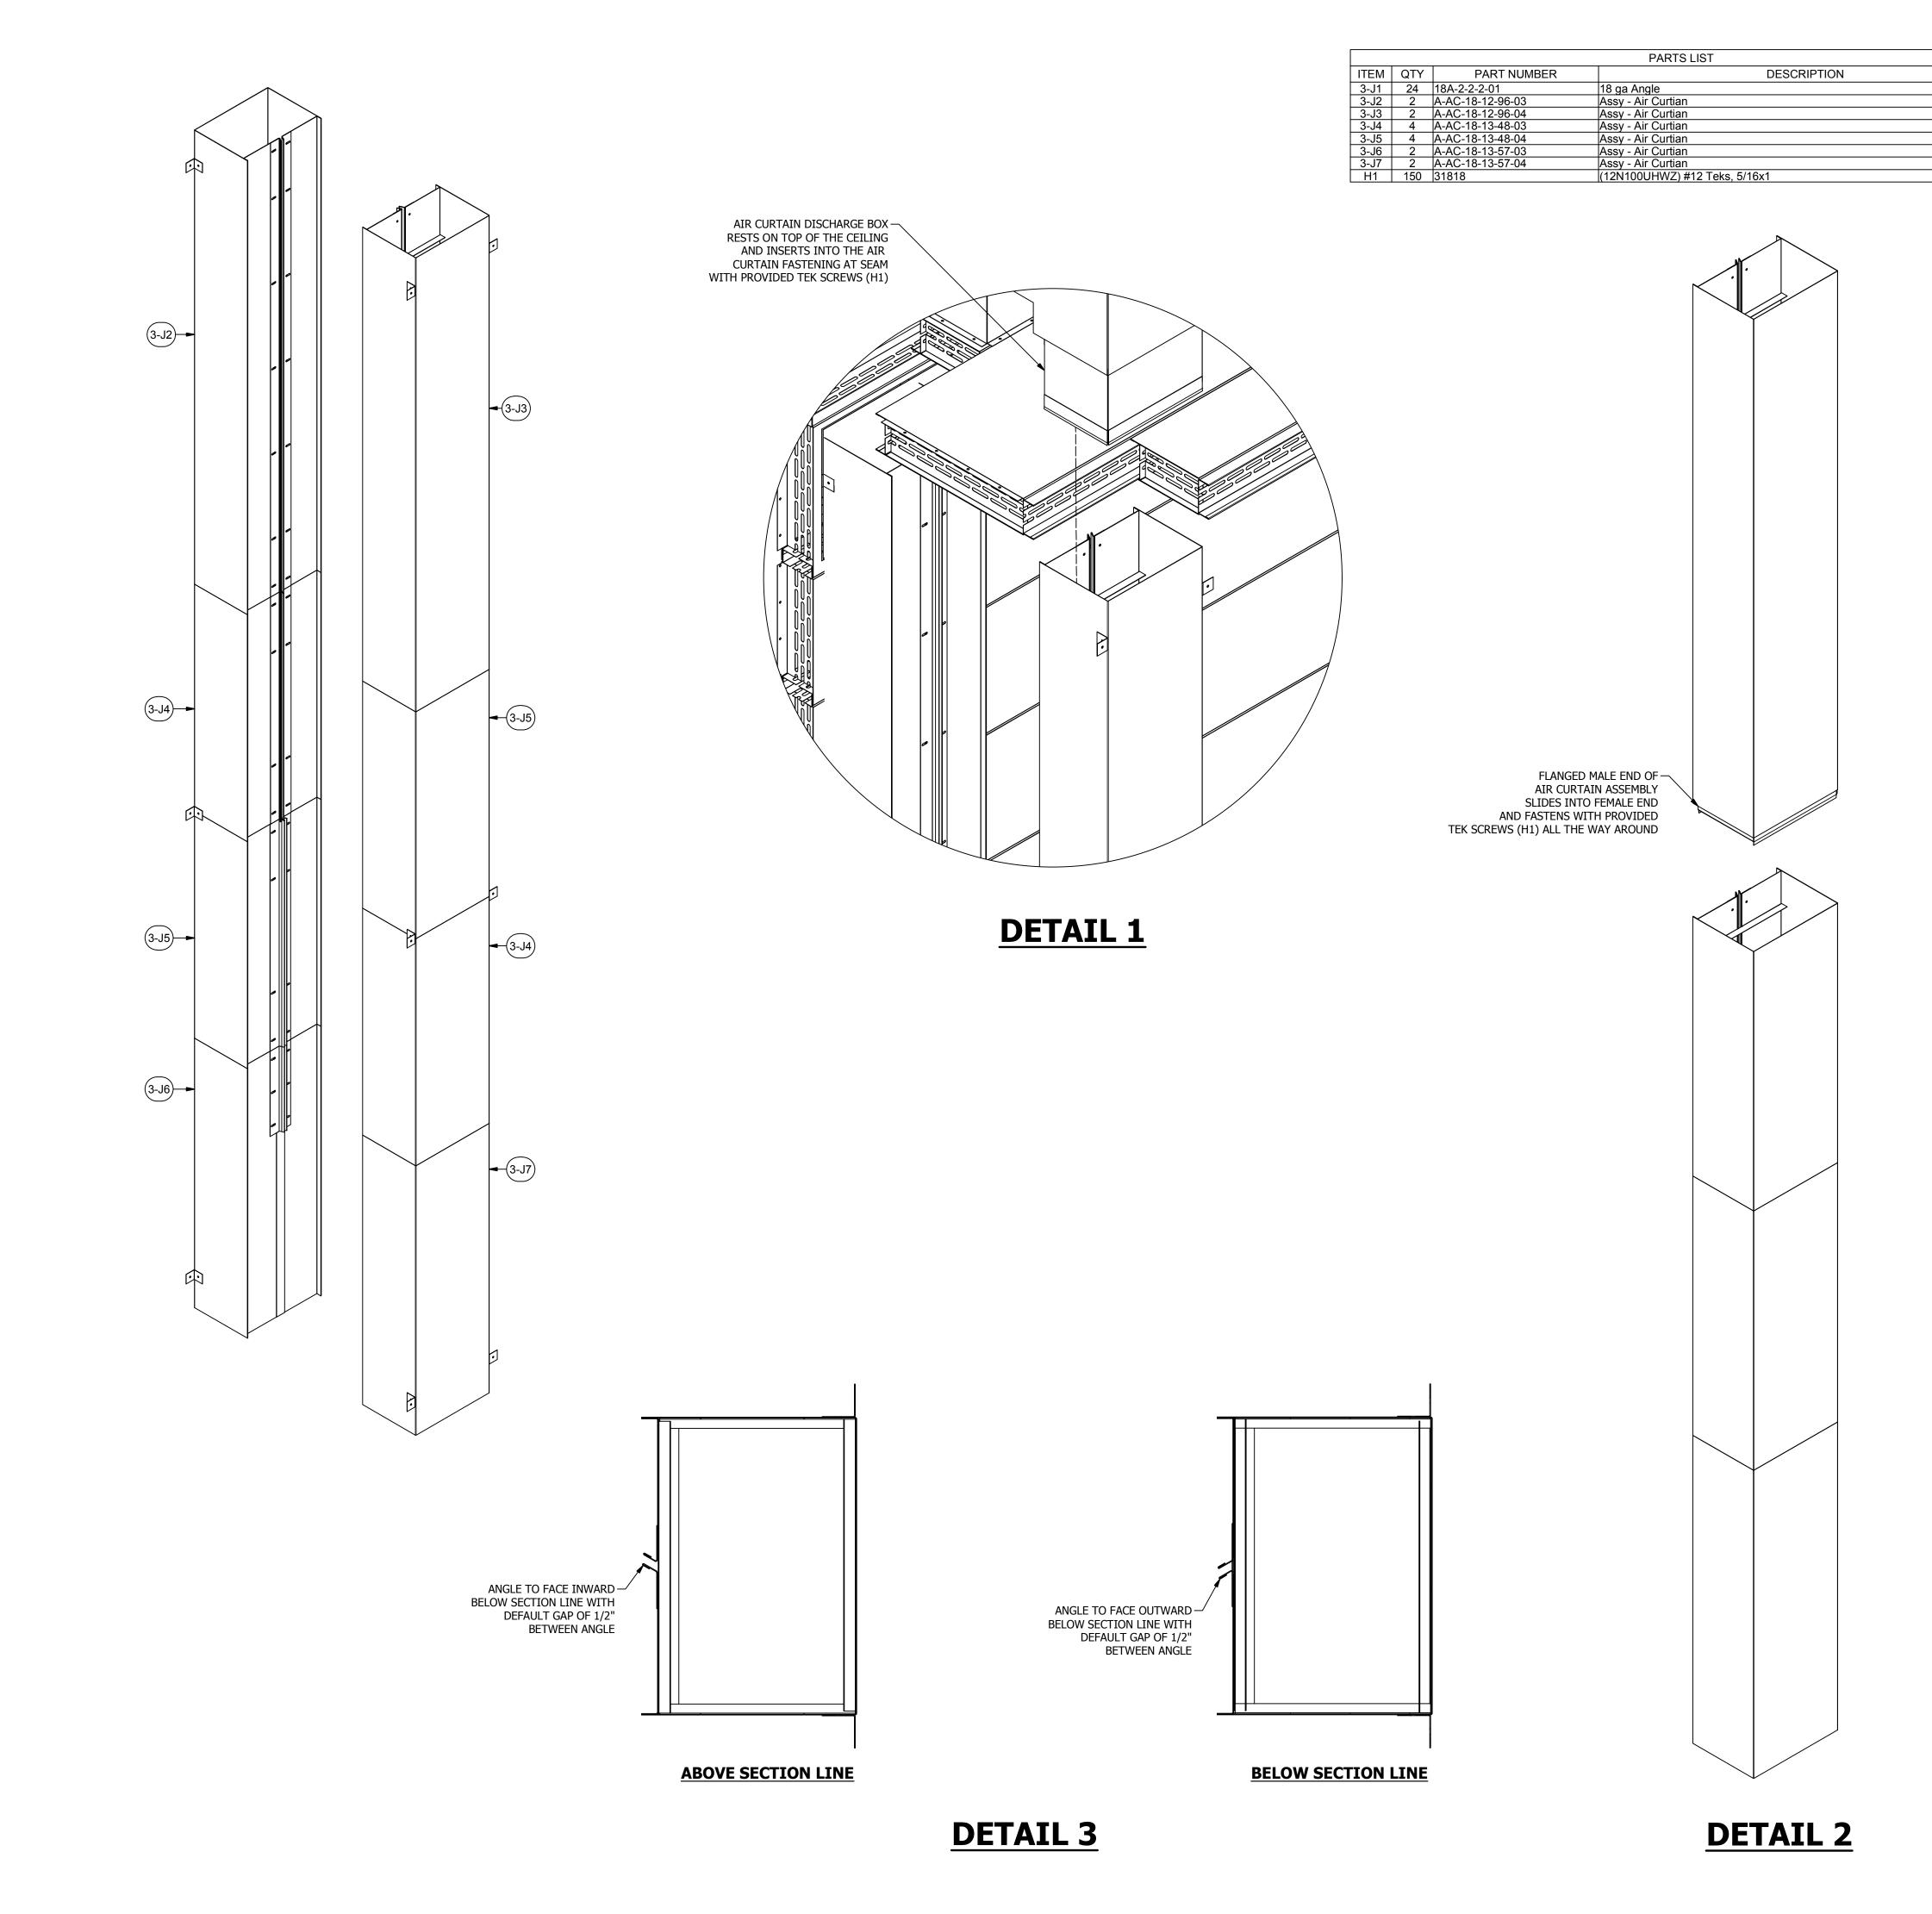(3-J5) **-**

SEE DETAIL 3 FOR SECTION — DETAILS

3-J2)

3-J4)

3-J5)

SE


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REV: 16.1 - 11/18/16
DESCRIPTION OF CHANGE(S):
Construction Set

DRAWING TITLE: EXPLODED ISOMETRIC ASSEMBLY DRAWING

R2016151 POHT-WP-4.5-21.5-17-01

SHEET NO:

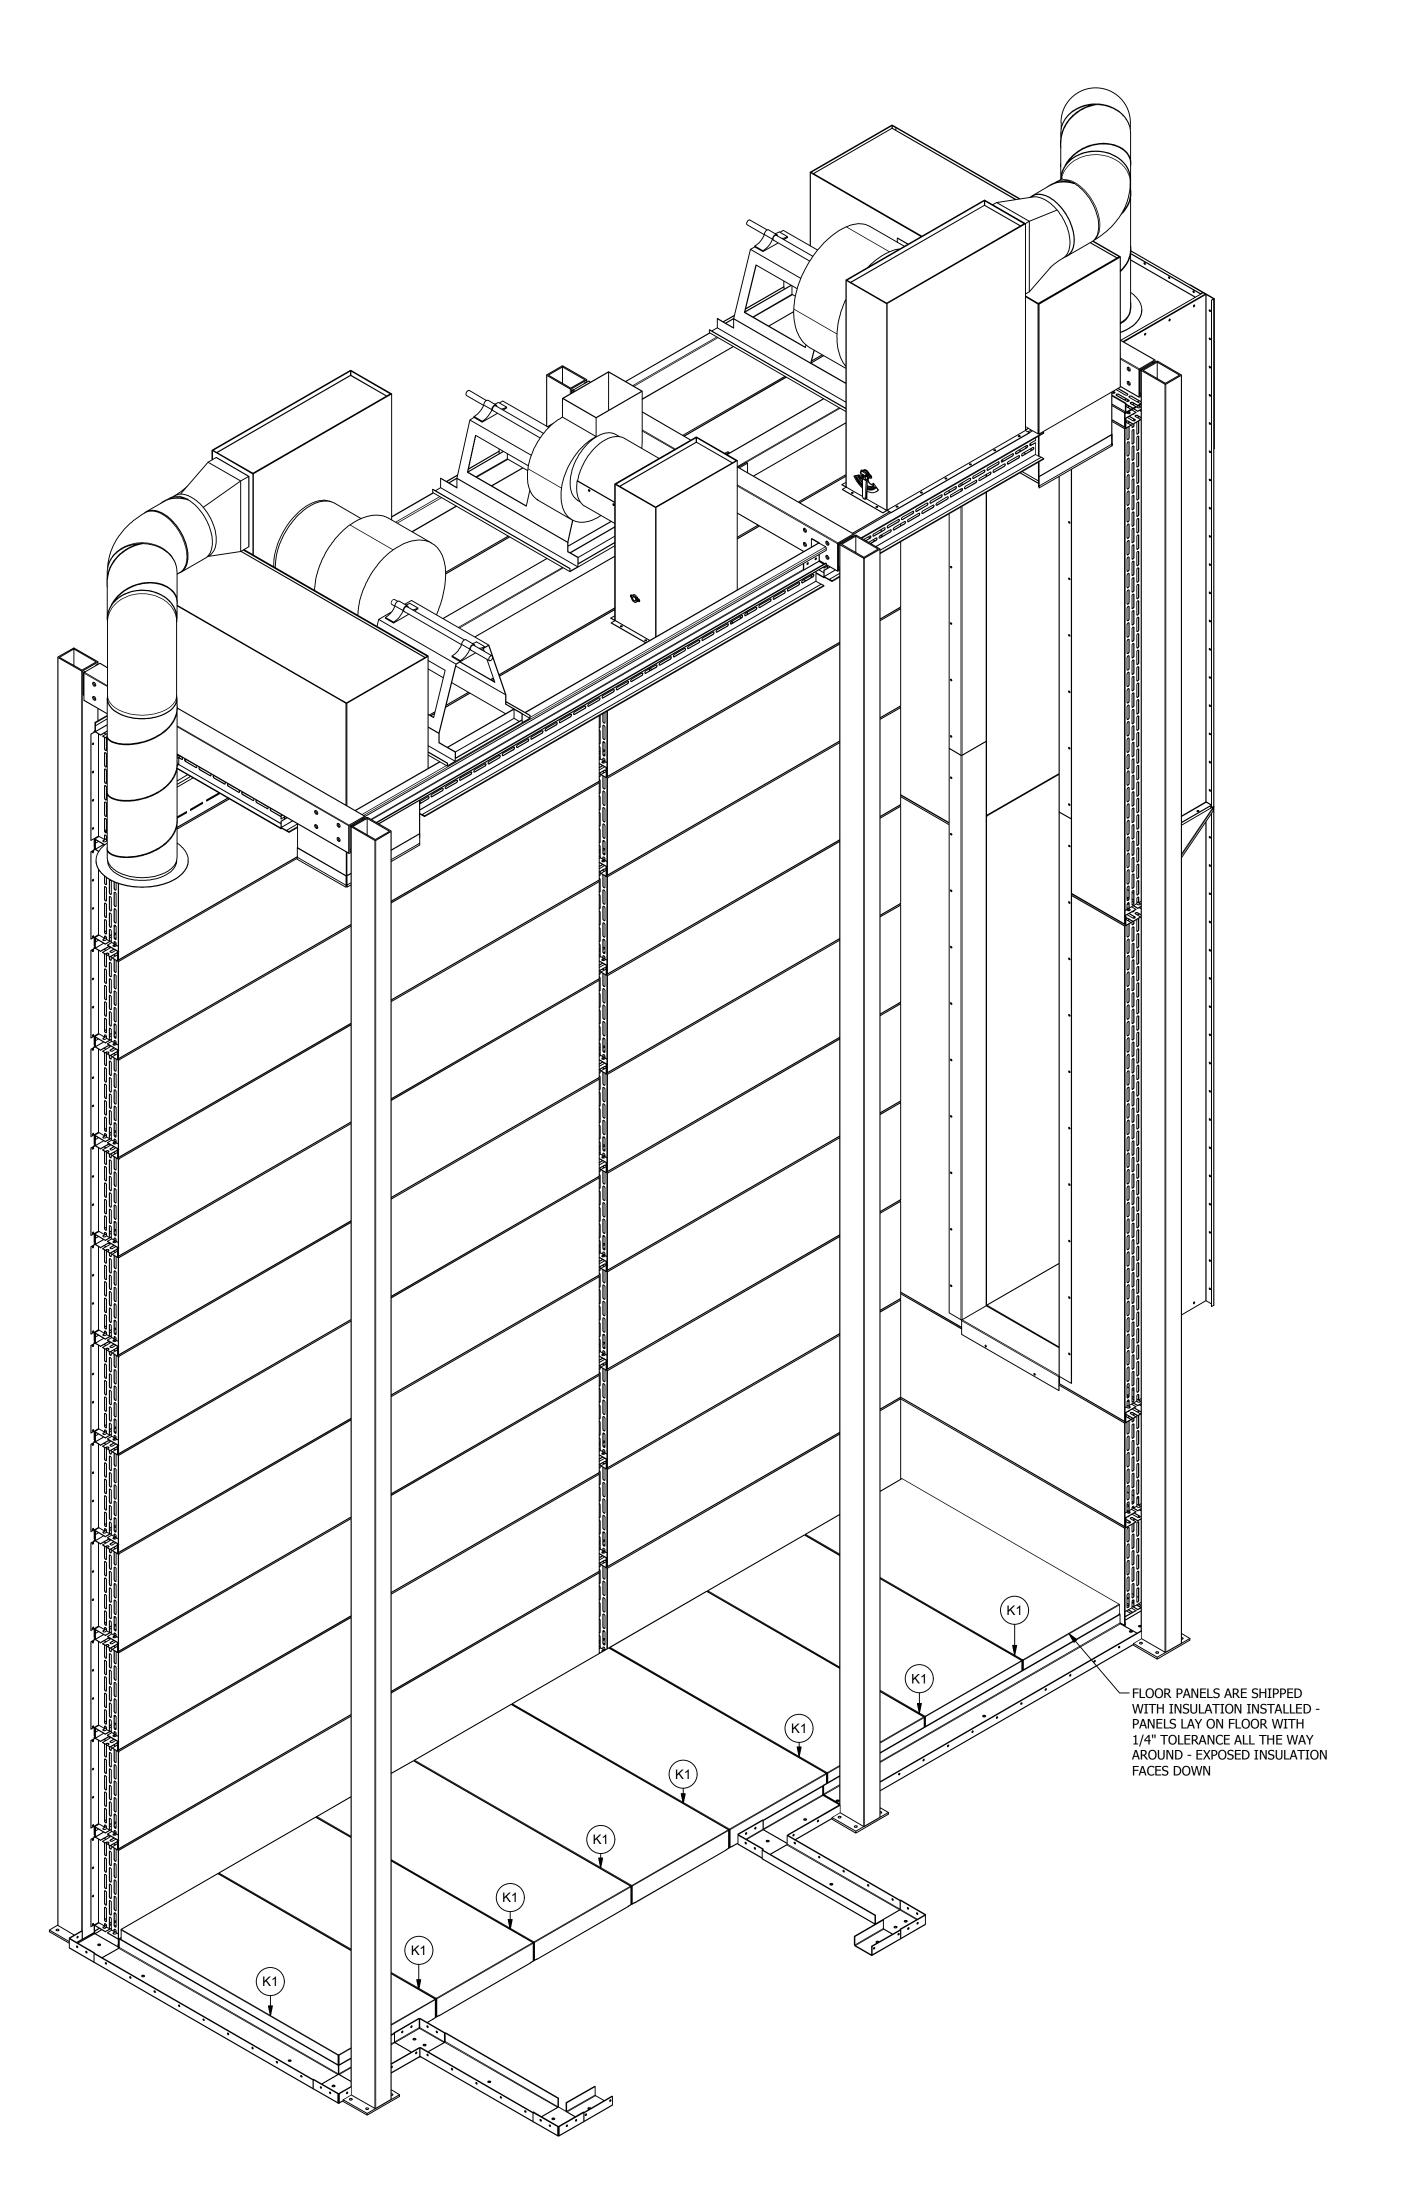

 PARTS LIST

 ITEM
 QTY
 PART NUMBER
 DESCRIPTION

 K1
 8
 BP4-4-24-53.5-01
 18 ga Booth Panel 4-sided pan

ROHNER MECHANICAL, INC.
D.B.A. "ROHNER"
2650 NE ANDRESEN RD.
SUITE 102
VANCOUVER, WA 98661
(360) 885-7641 VOICE
(360) 885-748 FAX
WA. LIC. # ROHNEMI015LH
OR. LIC. # 135549
CA# 792654



IENT SCOTT PARKWAY

SE

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CHECKED BY: DGR

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ISSUED DATE: 11/18/16

REV: 16.1 - 11/18/16

DESCRIPTION OF CHANGE(S):
Construction Set

DRAWING TITLE:
EXPLODED
ISOMETRIC
ASSEMBLY
DRAWING


R2016151

EQUIP. NO:
POHT-WP-4.5-21.5-17-01

3.9

			PARTS LIST
ITEM	QTY	PART NUMBER	DESCRIPTION
3-L1	1	A-18OD-14-76-48-01	Assy - Oven Duct
3-L2	1	A-18OD-14-76-48-02	Assy - Oven Duct
3-L3	1	A-18OD-E-14-76-31-01	Assy - Oven Duct End
3-L4	1	A-18OD-E-14-76-48-01	Assy - Oven Duct End
H1	160	31818	(12N100UHWZ) #12 Teks, 5/16x1
384	2	C-COS 12 ATTO	Custom- Duct- 12" Air Tight Take Off

	PARTS LIST					
М	QTY	PART NUMBER	DESCRIPTION			
.1	1	A-18OD-14-76-48-01	Assy - Oven Duct			
2	1	A-18OD-14-76-48-02	Assy - Oven Duct			
.3	1	A-18OD-E-14-76-31-01	Assy - Oven Duct End			
4	1	A-18OD-E-14-76-48-01	Assy - Oven Duct End			
1	160	31818	(12N100UHWZ) #12 Teks, 5/16x1			
4	2	C-COS 12 ATTO	Custom- Duct- 12" Air Tight Take Off			
			-			

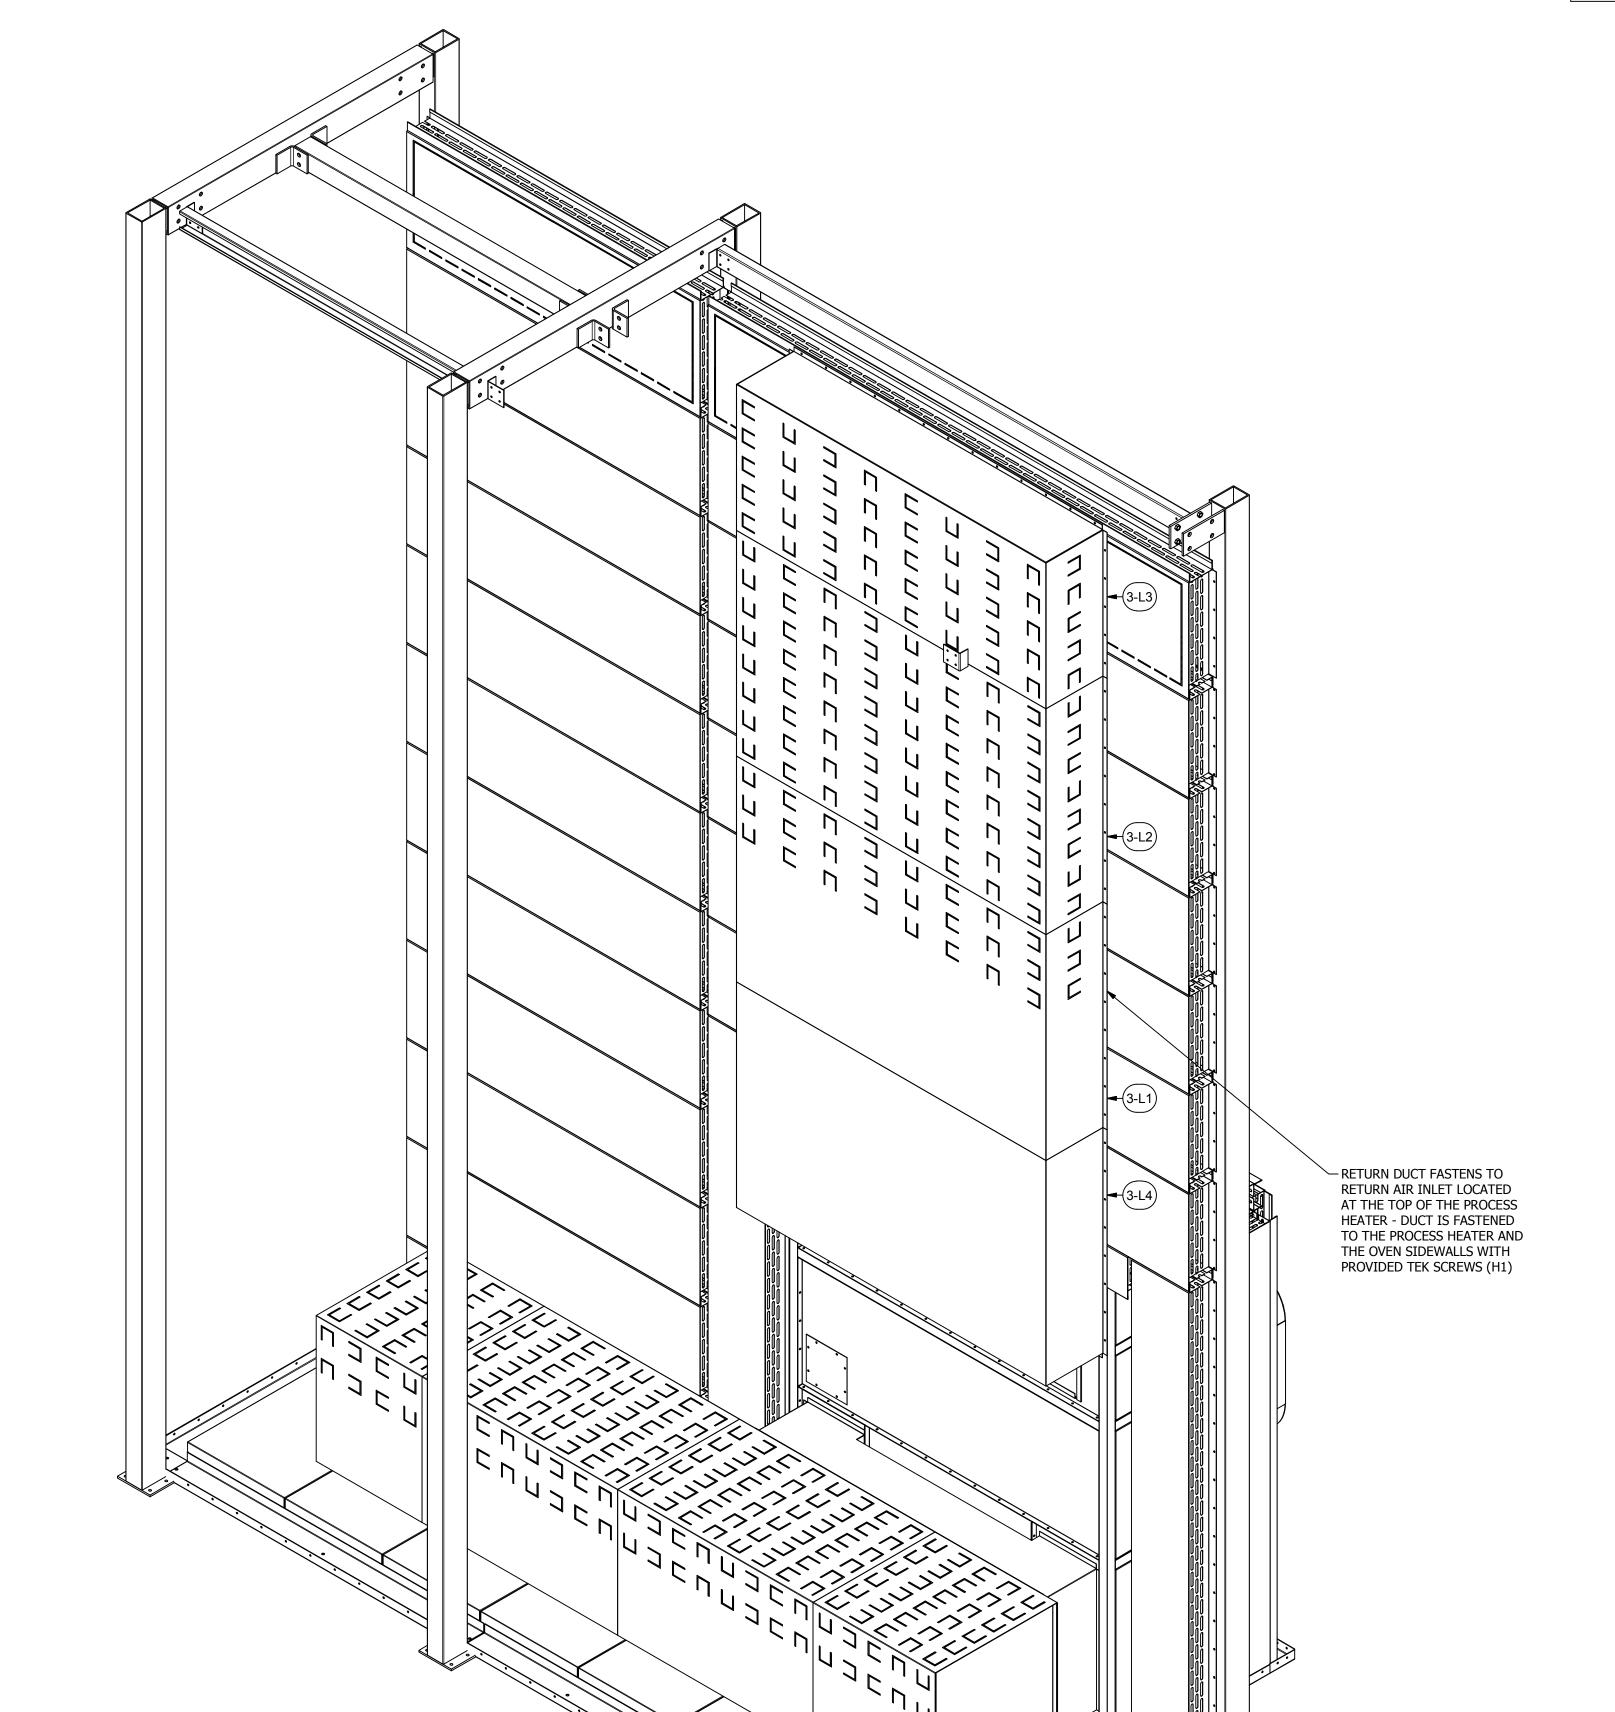



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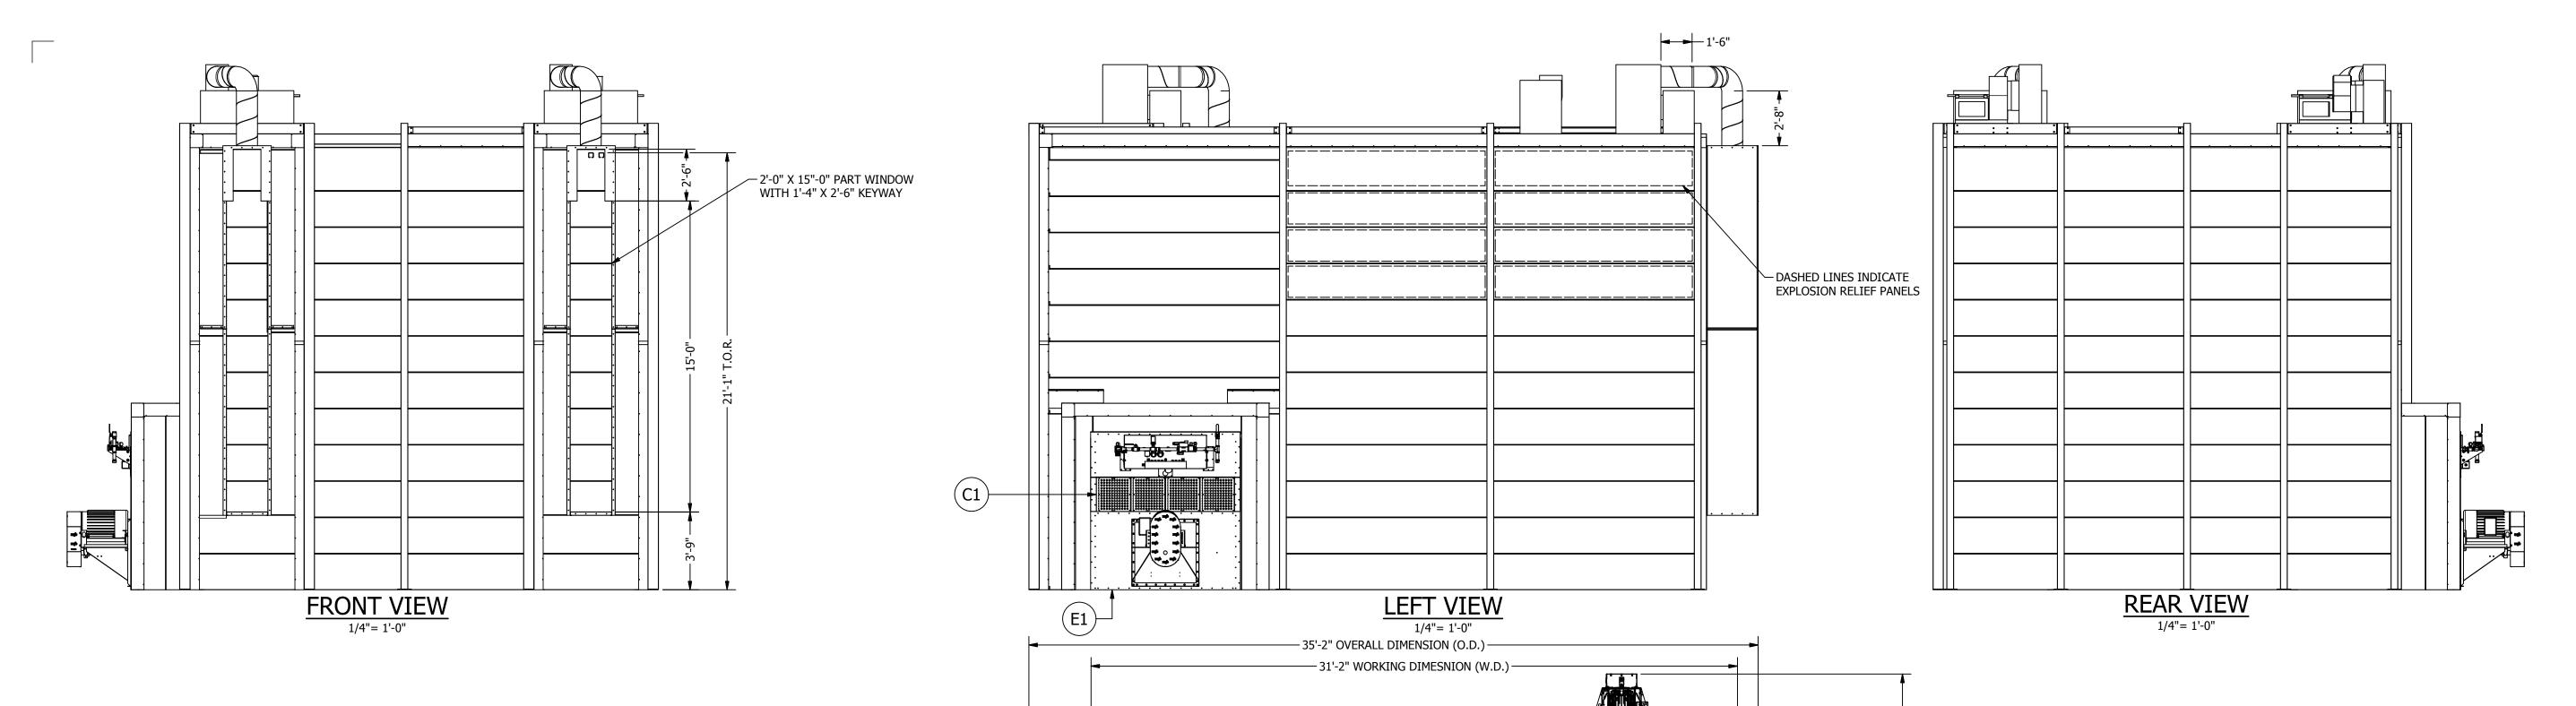
ISSUED DATE: 11/18/16


REV: 16.1 - 11/18/16
DESCRIPTION OF CHANGE(S):
Construction Set

DRAWING TITLE: EXPLODED ISOMETRIC ASSEMBLY DRAWING

R2016151


EQUIP. NO:
POHT-WP-4.5-21.5-17-01
SHEET NO:



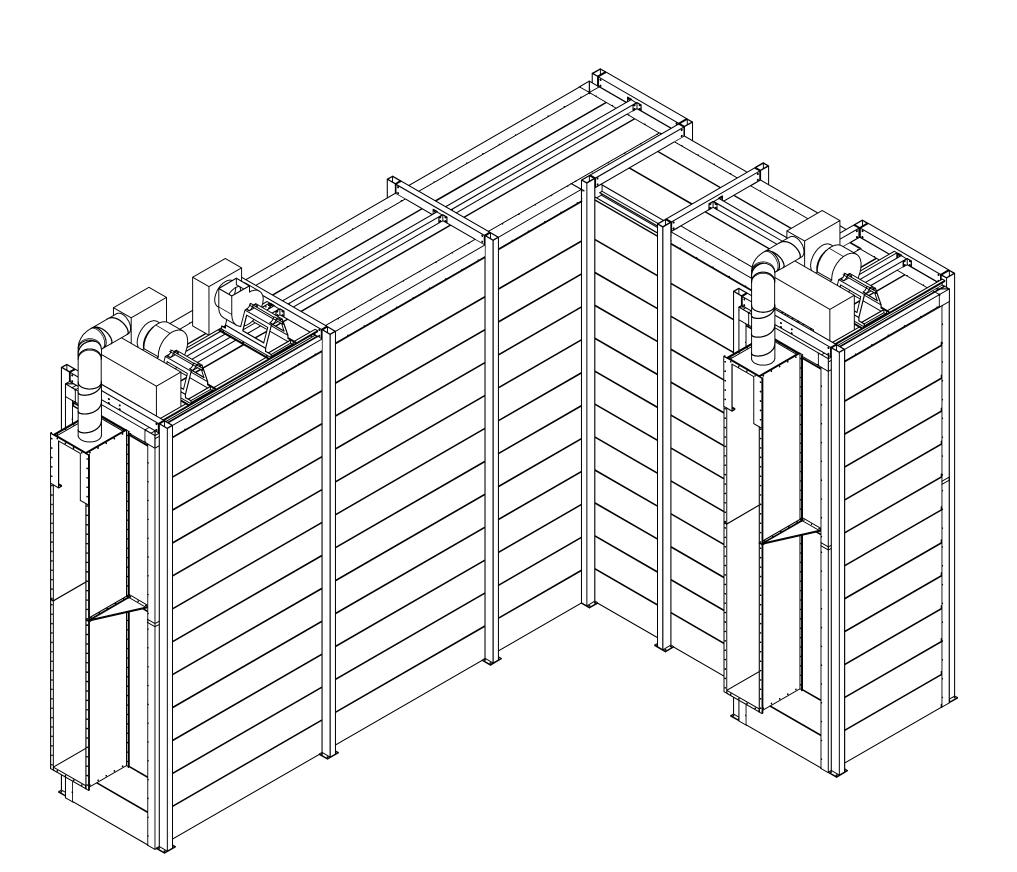

ISOMETRIC VIEW

NOT TO SCALE

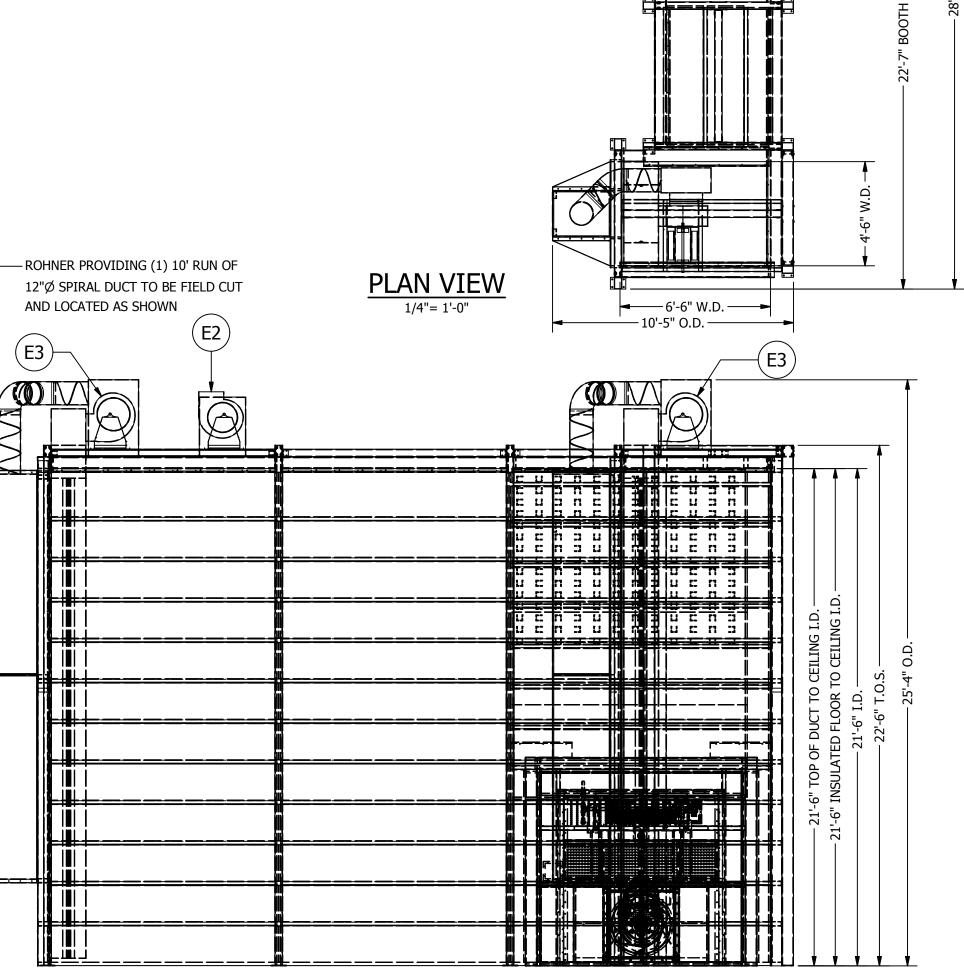

RIGHT VIEW

1/4"= 1'-0"

APPROVED FOR CONSTRUCTION

POHT-WP-4.5-21.5-50-WP - Natural Gas Fired Industrial CURE OVEN High Temp

(1ea) Industrial Insulated Dry-Off Oven with (1) direct fired process heater, oven side wall mounted and one exhaust fan, oven top mounted. Filtered supply air is pulled from the interior of the building. Exhaust air is removed from the enclosure and delivered to the building exterior.

	воотн						
Tag	Qty.	Pck.	Part	Description			
B1	1		POHT-WP-4.5-21.5-50-WP - Sht. 1.1	POHT-WP-4.5-21.5-50-WP - Structure - Sht. 1.1			
B2	2		POHT-WP-4.5-21.5-50-WP - Sht. 1.2	POHT-WP-4.5-21.5-50-WP - Floor Track - Sht. 1.2			
B3	3		POHT-WP-4.5-21.5-50-WP - Sht. 1.3	POHT-WP-4.5-21.5-50-WP - Sidewalls - Sht. 1.3			
B4	4 POHT-WP-4.5-21.5-50-WP - Sht. 1.4 POHT-WP-4.5-21.5-50-WP - Endwalls - Sht. 1.4						
B5	5		POHT-WP-4.5-21.5-50-WP - Sht. 1.5	POHT-WP-4.5-21.5-50-WP - Ceiling - Sht. 1.5			
B6	6		POHT-WP-4.5-21.5-50-WP - Sht. 1.6	POHT-WP-4.5-21.5-50-WP - Duct - Sht. 1.6			
B7	7		POHT-WP-4.5-21.5-50-WP - Sht. 1.7	POHT-WP-4.5-21.5-50-WP - Flashing - Sht. 1.7			
	•		•	EQUIPMENT			
E1	1		A-PH-C	Natural Gas Direct Fired Process Heater 2.0 Million BTU, 20,000 CFM, 20hp			
E 2	1		CSW-12-BI-21-10-I-7	Series 21 Backward Inclined Single Width Fan, 1600 cfm @ .5" s.p., .75 hp			
E3	2		CSW-12-BI-21-10-II-50	Series 21 Backward Inclined Single Width Fan, 3000 cfm @ 3" s.p., 5 hp 460v/3/60			
				COMPONENTS			
C1	4		01AFR2020-20	#01AFR2020-20 - Intake AFR1 Panel - white			
i			•	ASSEMBLIES			
A1	4		A-AC-12-18-180	Air Curtain Assembly - 12" x 18" over 15'			
				CONTROLS			
CO1	1	1 POHT PLC Compact PLC based control center- 24VDC power supply, 24 I/O PLC controller, PID temperature control relay with auto tuning & 5.7" QVGA color touch screen H (1) 20 hp., (2) 5 hp. & (1) 3/4 motor starters.					
			<u> </u>	DUCT			
D1	1		D20-SQR-1013.25-14	Exhaust Duct- Square to Round- 10" x 13.25" to 16" dia. Over 1'			
D2	2		D20-R-16D-48	Exhaust Duct- 16" Dia- Over 4'			
D3	1		D-RWS-20D	Exhaust Duct- Rockwool Sleeve, 20" Dia. Over 4' w/ Storm Collar			
D4	1		SC-16	Exhaust Duct- Storm Collar- 16"			
D5	1		SC-18	Exhaust Duct- Storm Collar- 18"			
D7	1		CC-16	China Cap- 16" Dia			
D8	1		D-RRJ-22D	Exhaust Duct- Flat Conical Roof Jack Assembly- 22" for 20" Duct w/ storm collar			
D9	1		D18-S-18d-45	Exhaust Duct- Sleeve, 18" Dia.			
D10	1		CSP-12-10-26GA	Spiral Pipe 12"X10' 26Ga			
D11	2		CEL-12-24-45	12" Ajustable 45 degree Elbow			
D12	2		COS 12 ATTO D	12" Air Tight Take Off With Damper			
 D13	2		D20-SQR-815-12	Exhaust Duct- Square to Round- 8" x 15" to 12" dia. Over 1'			
D14	2	1	CEL-12-24-90	12" Ajustable 90 degree Elbow			
			1	GENERAL NOTES			

Includes all assembly materials, fasteners and caulking

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ISSUED DATE: 10-5-16

REV: 16.1 - 10/11/16


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1. 6'-0" ADDED TO CENTER SECTION
AND REMOVED FROM EXIT SECTION


DRAWING TITLE:
FLOOR PLANS/
ELEVATIONS/
SECTIONS

R2016151

EQUIP. NO:
POHT-WP-4.5-21.5-50-WP




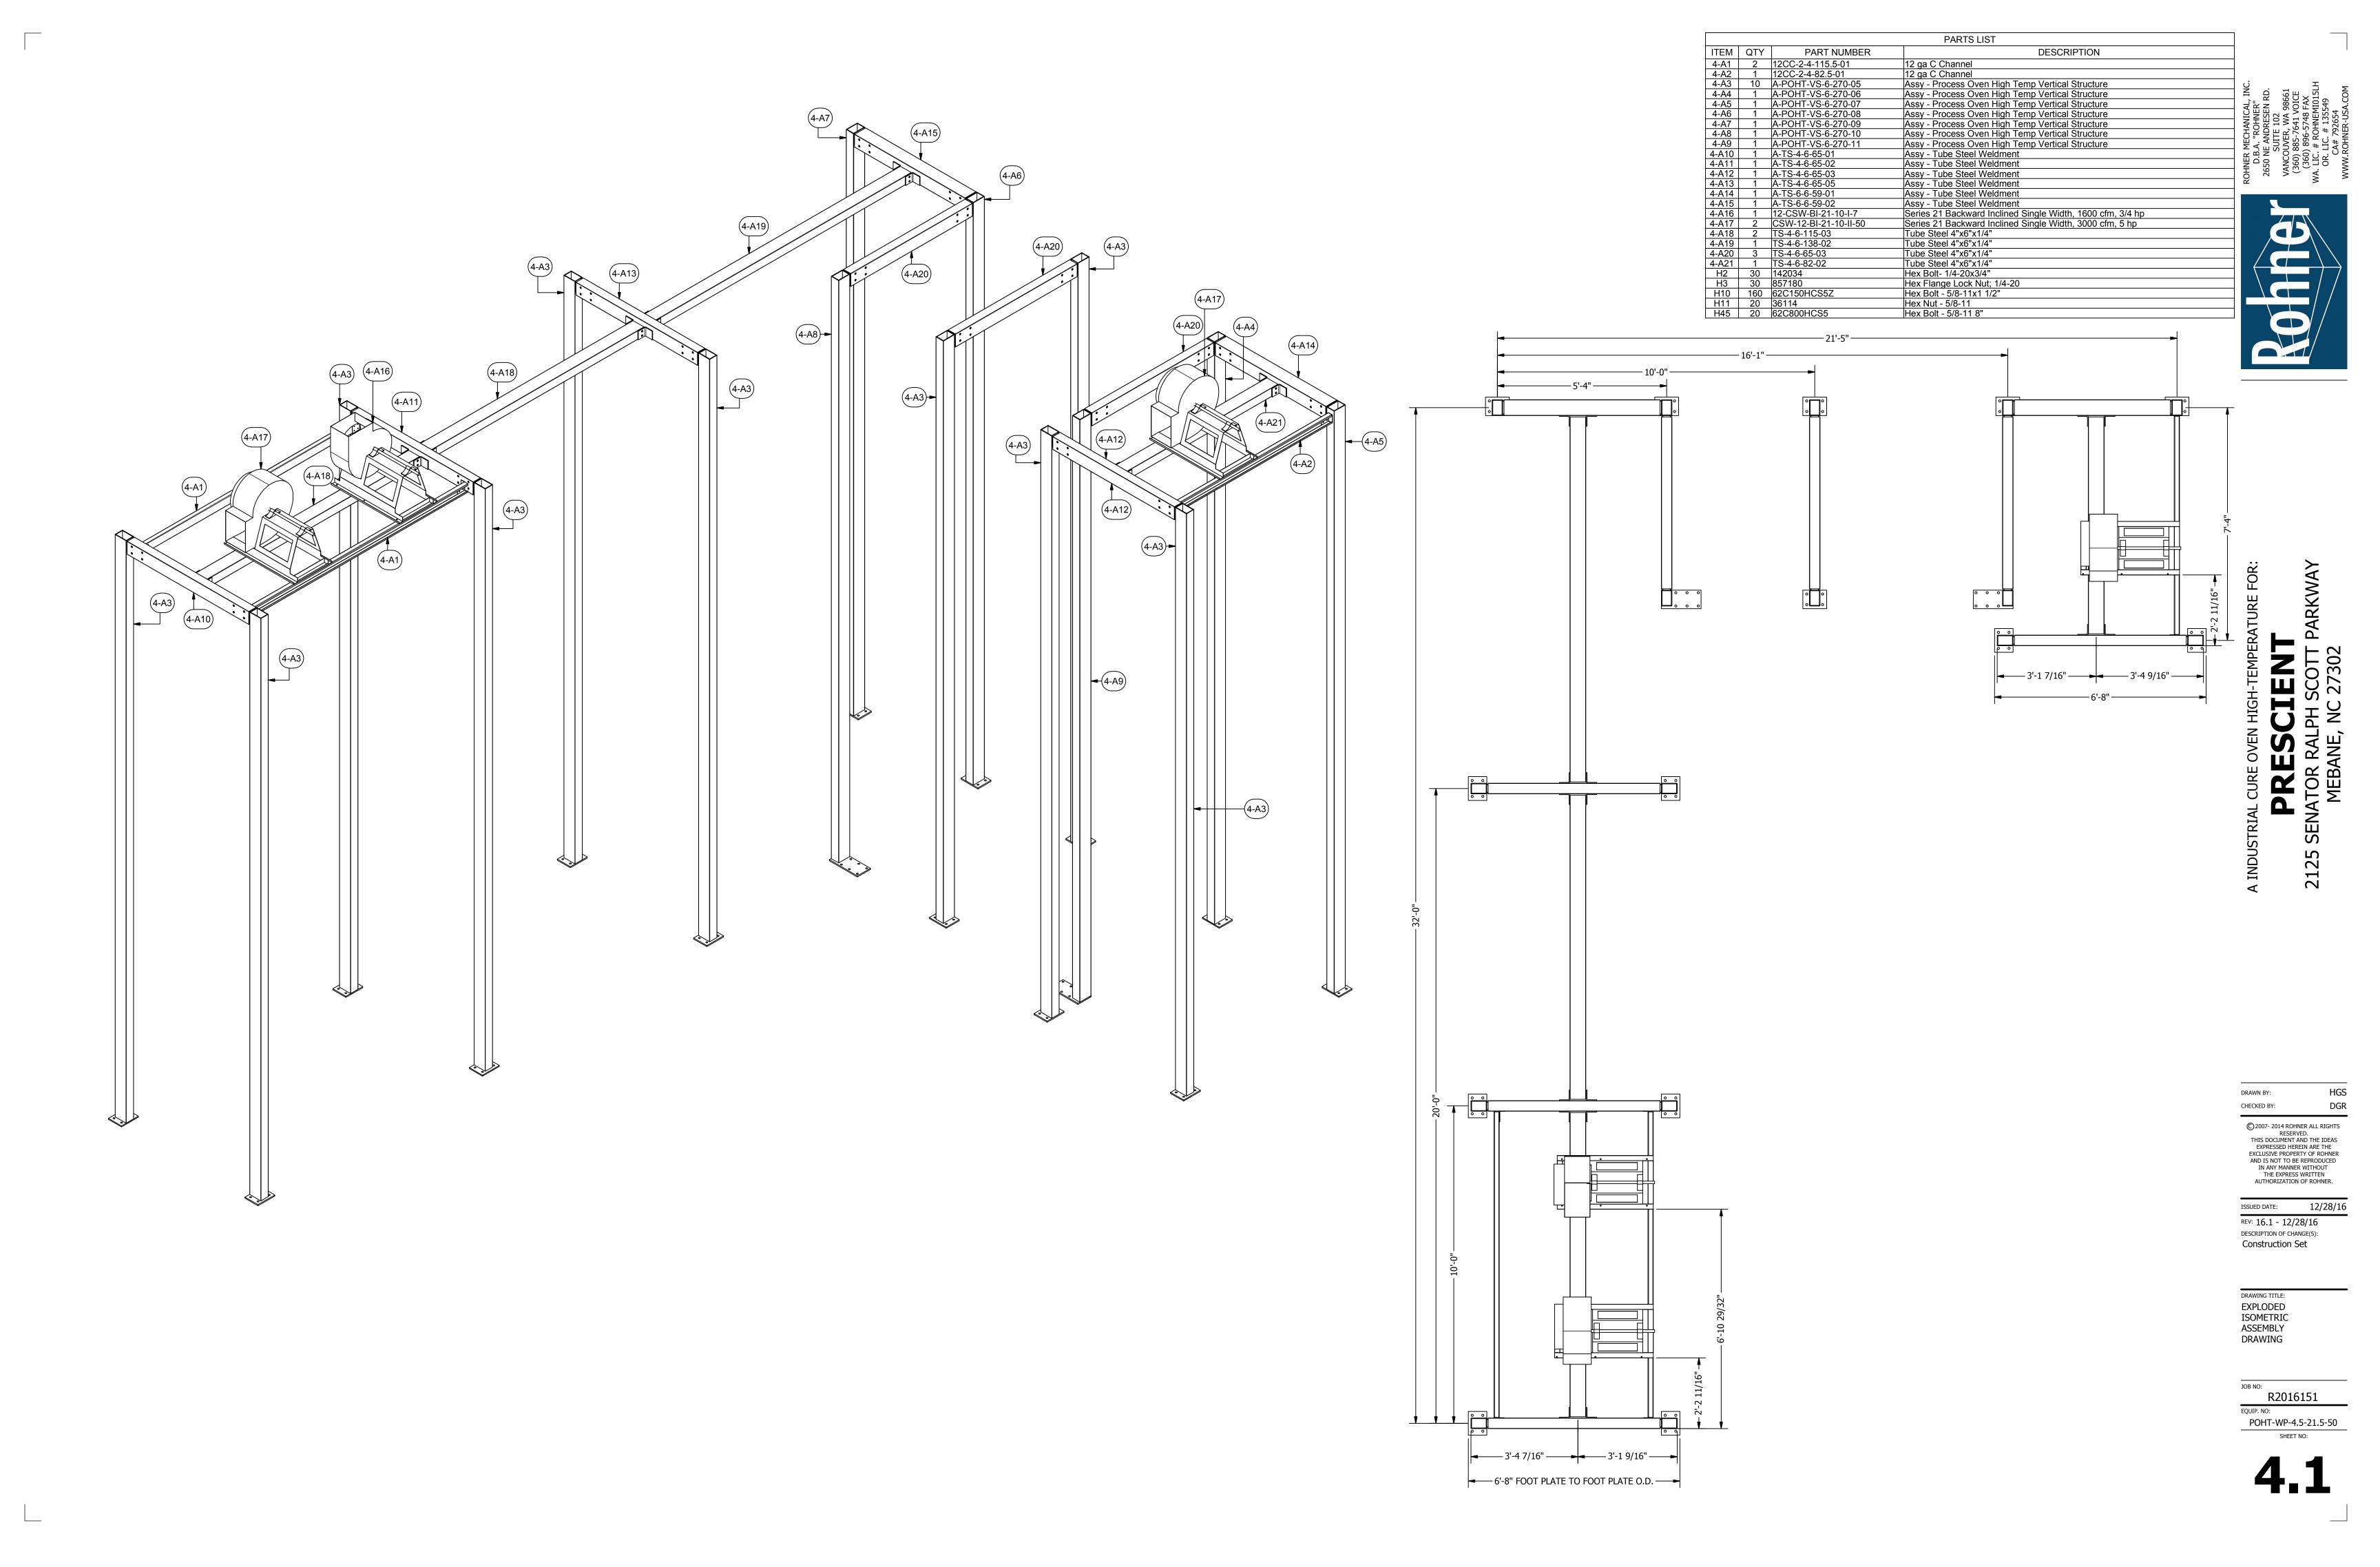

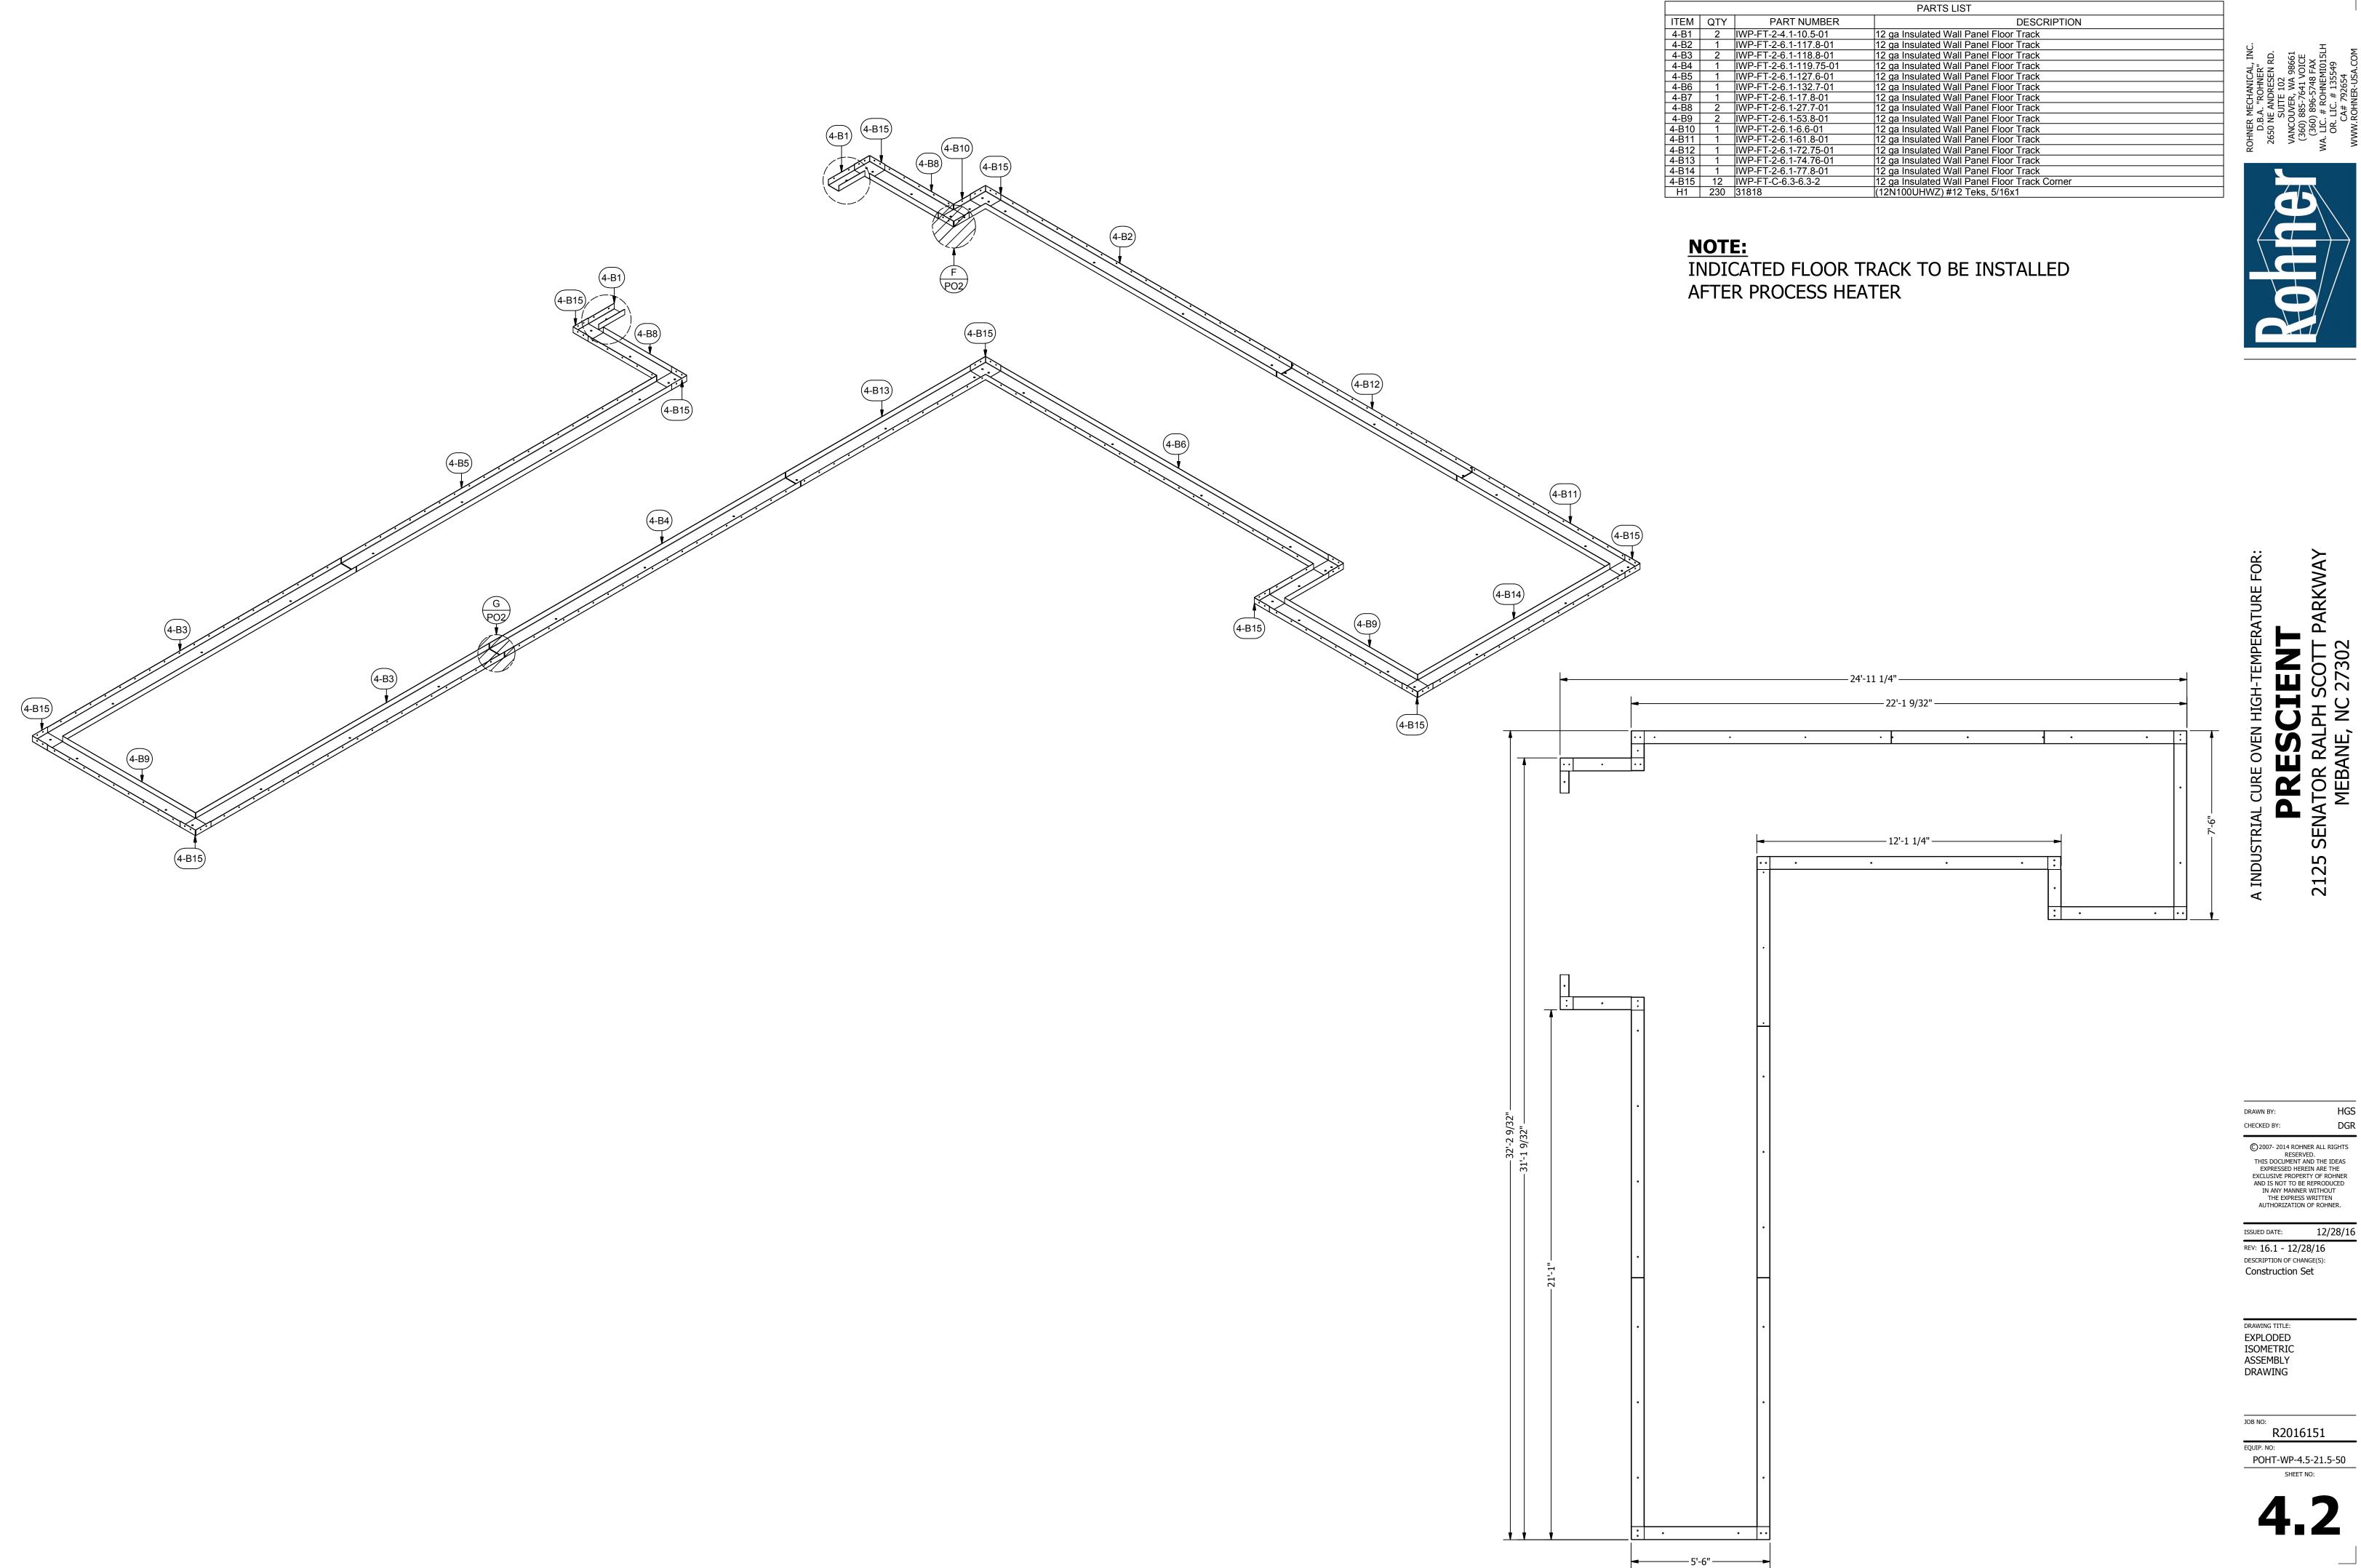



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REV: 16.1 - 12/28/16 DESCRIPTION OF CHANGE(S): Construction Set

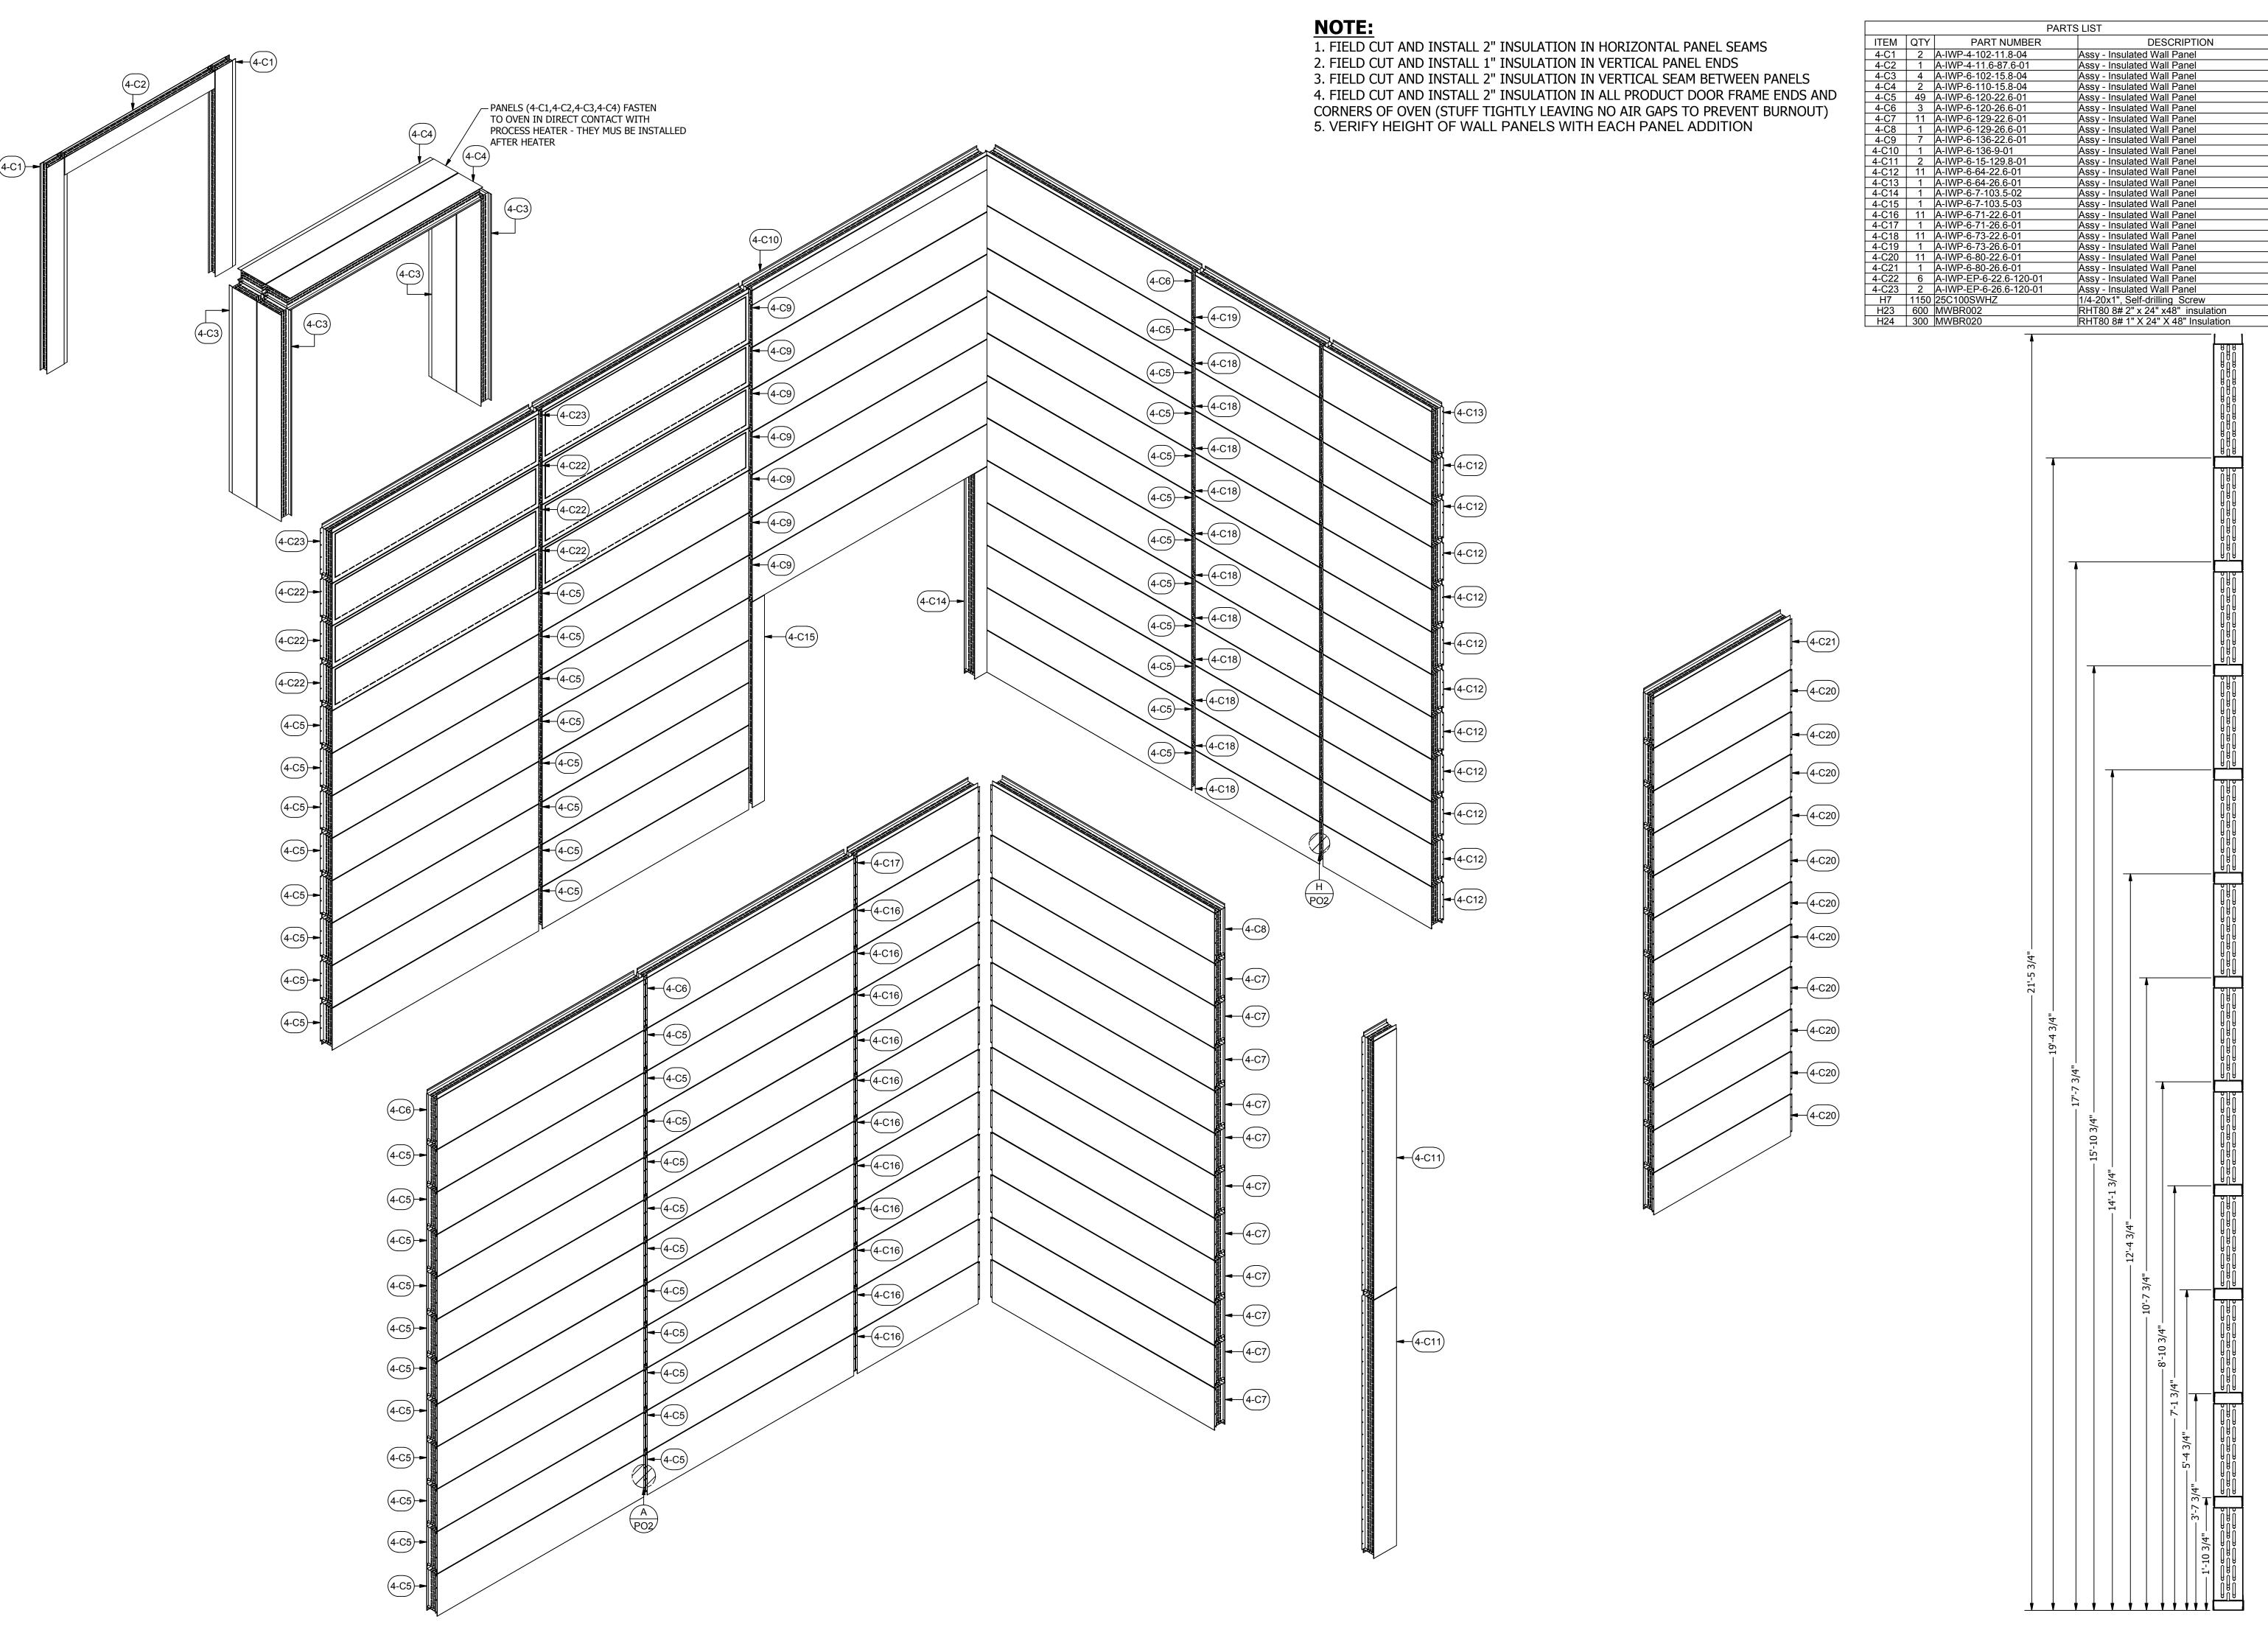AUTHORIZATION OF ROHNER.

DRAWING TITLE: EXPLODED ISOMETRIC ASSEMBLY DRAWING


NOTE:

1. FIELD CUT AND INSTALL 2" INSULATION IN HORIZONTAL PANEL SEAMS


2. FIELD CUT AND INSTALL 1" INSULATION IN VERTICAL PANEL ENDS

3. FIELD CUT AND INSTALL 2" INSULATION IN VERTICAL SEAM BETWEEN PANELS
4. FIELD CUT AND INSTALL 2" INSULATION IN ALL PRODUCT DOOR FRAME ENDS AND

CORNERS OF OVEN (STUFF TIGHTLY LEAVING NO AIR GAPS TO PREVENT BURNOUT)
5. VERIFY HEIGHT OF WALL PANELS WITH EACH PANEL ADDITION

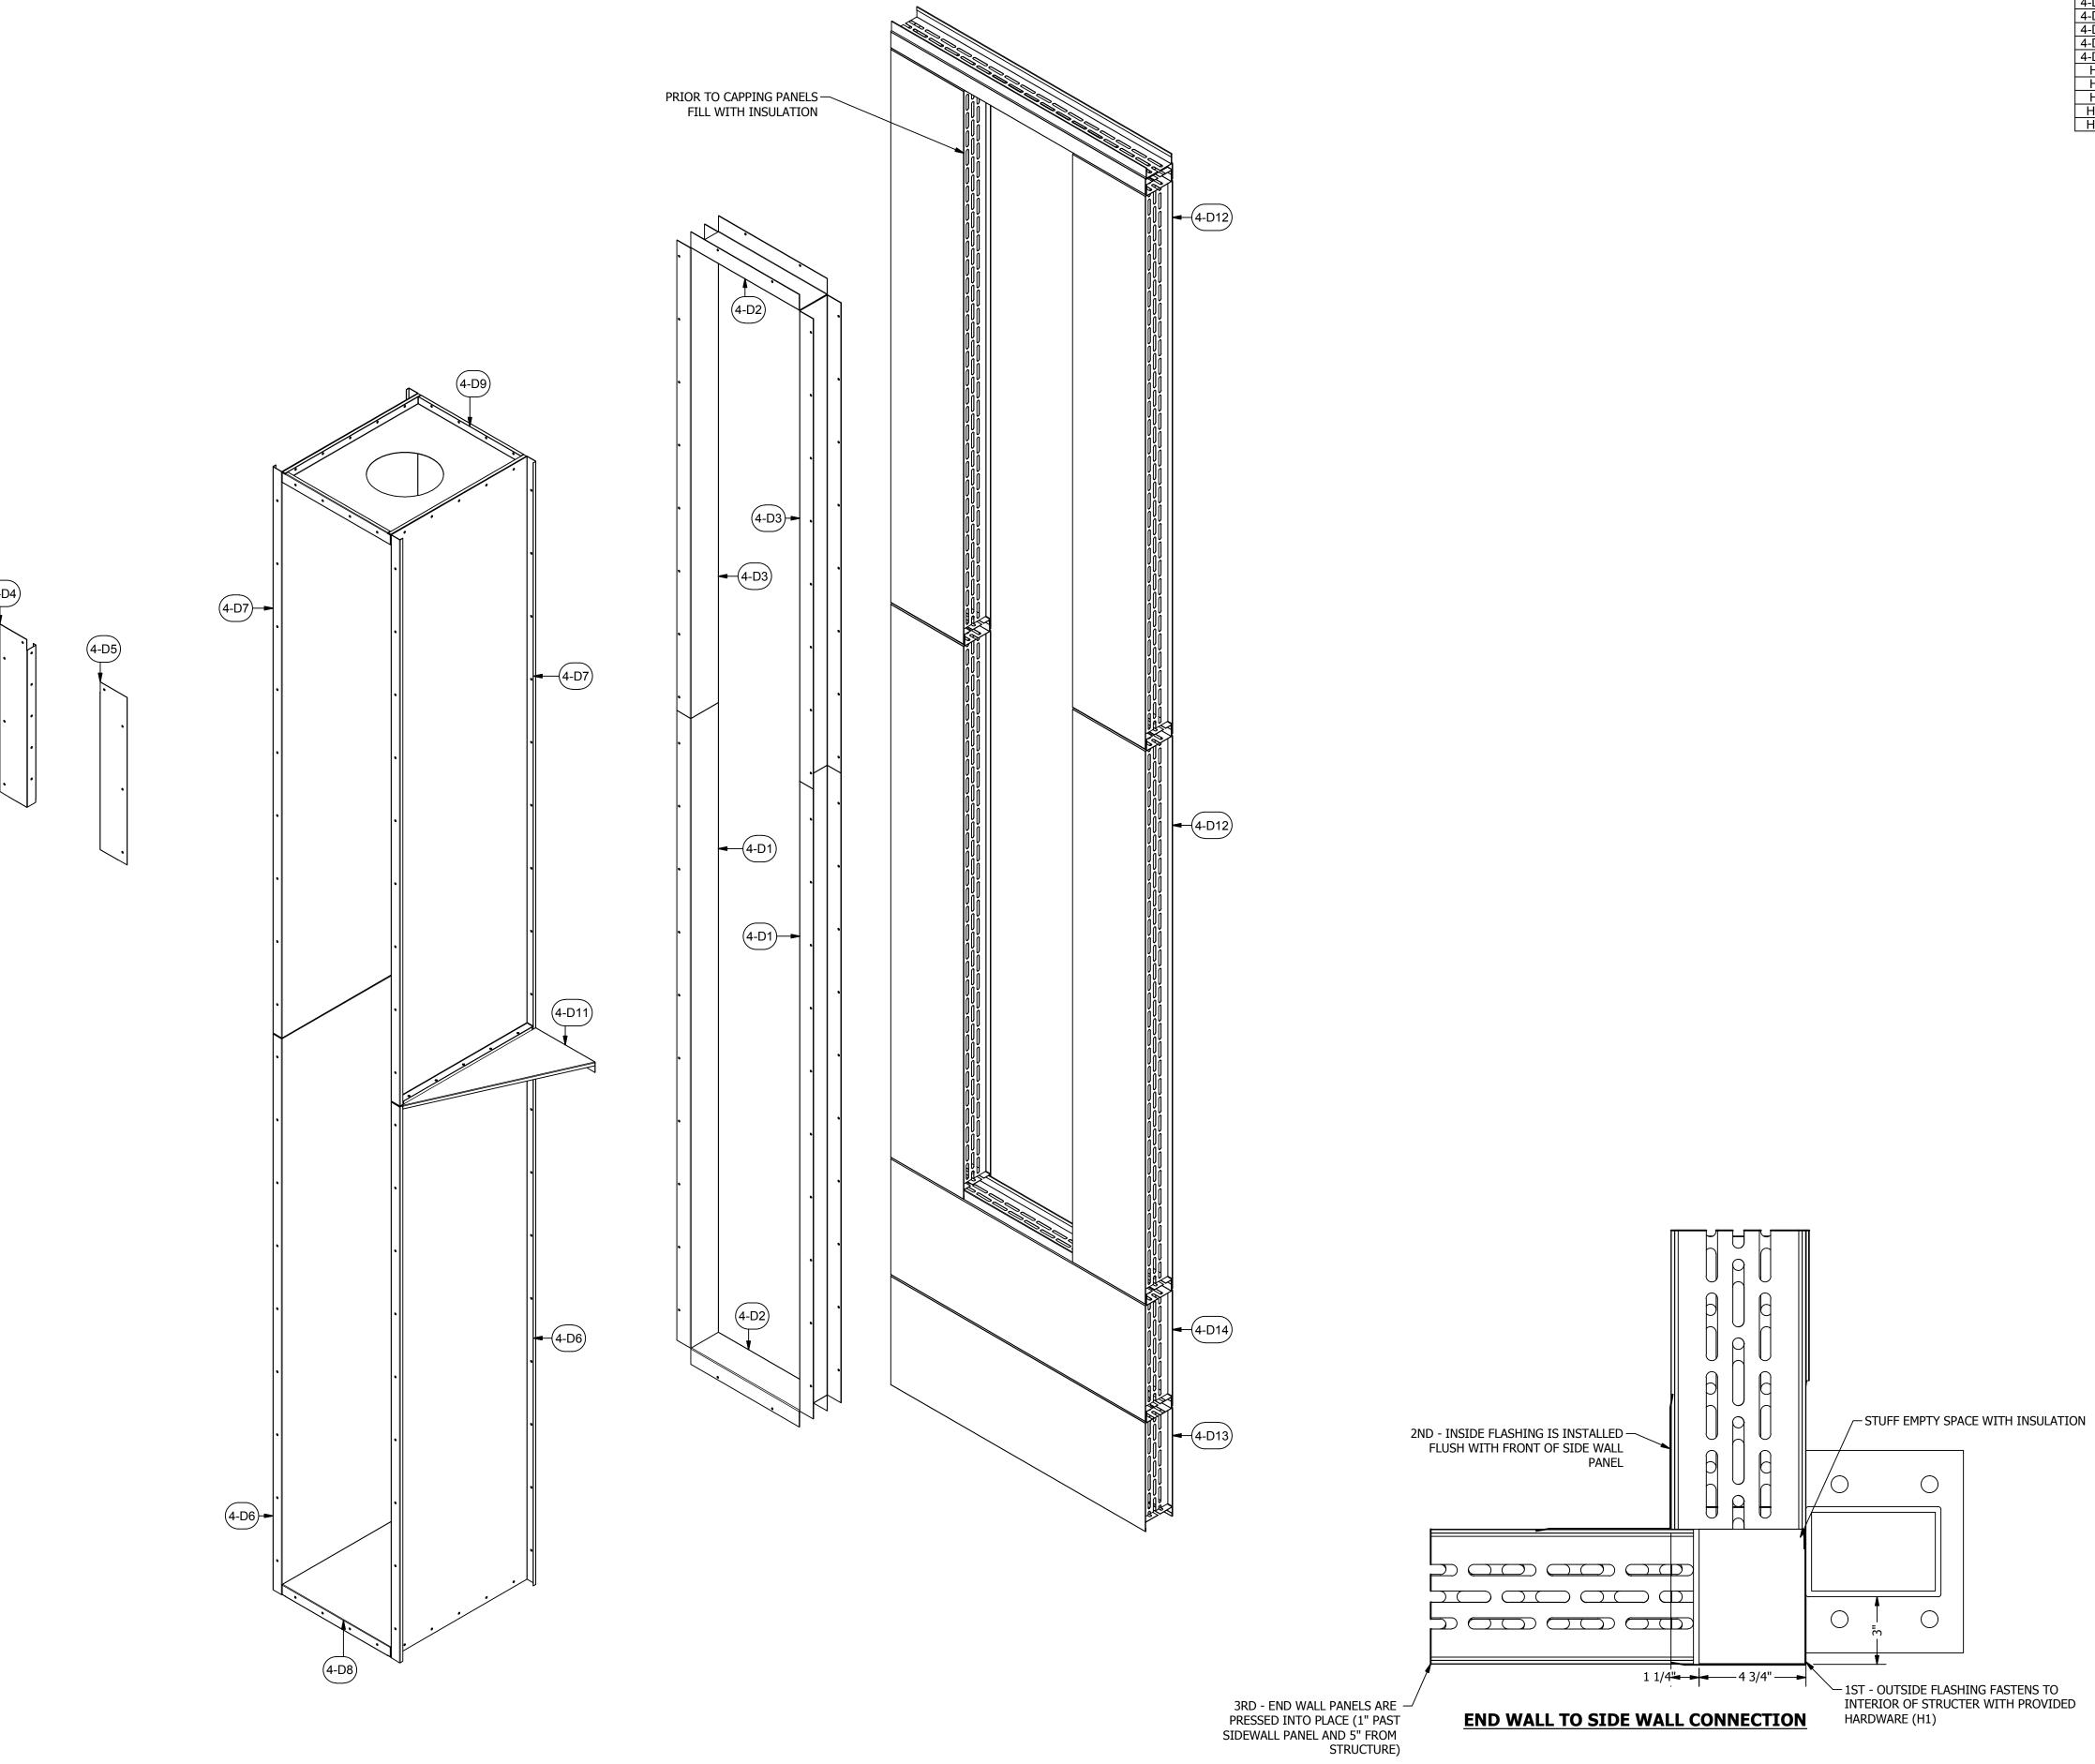

			PARTS LIST	
ITEM	QTY	PART NUMBER	DESCRIPTION	
4-D1	4	18CC-3-6-120-01	14 ga C Channel	
4-D2	4	18CC-3-6-24-01	14 ga C Channel	
4-D3	4	8CC-3-6-89.6-01 14 ga C Channel		
4-D4	2	BP2-L-6-32-01	18 ga Booth Panel 2-sided Pan Left	
4-D5	2	BP2-R-6-32-01	18 ga Booth Panel 2-sided Pan Left	
4-D6	4	BP3-30-106-02	18 ga Booth Panel 3-sided pan	
4-D7	4	BP3-30-108-02	18 ga Booth Panel 3-sided pan	
4-D8	2	BP4-24-30	18 ga Booth Panel 4-sided pan	
4-D9	2	BP4-24-30-02	18 ga Booth Panel 4-sided pan	
4-D10	2	18SG-30-15-2-01	18 ga Stiffening Gusset	
4-D11	2	18SG-30-15-2-02	18 ga Stiffening Gusset	
4-D12	8	A-IWP-6-16-107.3-04	Assy - Insulated Wall Panel	
4-D13	2	A-IWP-6-56-22.6-04	Assy - Insulated Wall Panel	
4-D14	2	A-IWP-6-56-24-04	Assy - Insulated Wall Panel	
4-D15	2	A-IWP-6-56-5-04	Assy - Insulated Wall Panel	
H1	60	31818	(12N100UHWZ) #12 Teks, 5/16x1	
H2	60	142034	Hex Bolt- 1/4-20x3/4"	
H3	100	857180	Hex Flange Lock Nut; 1/4-20	
H23	100	MWBR002	RHT80 8# 2" x 24" x48" insulation	
H24	75	MWBR020	RHT80 8# 1" X 24" X 48" Insulation	

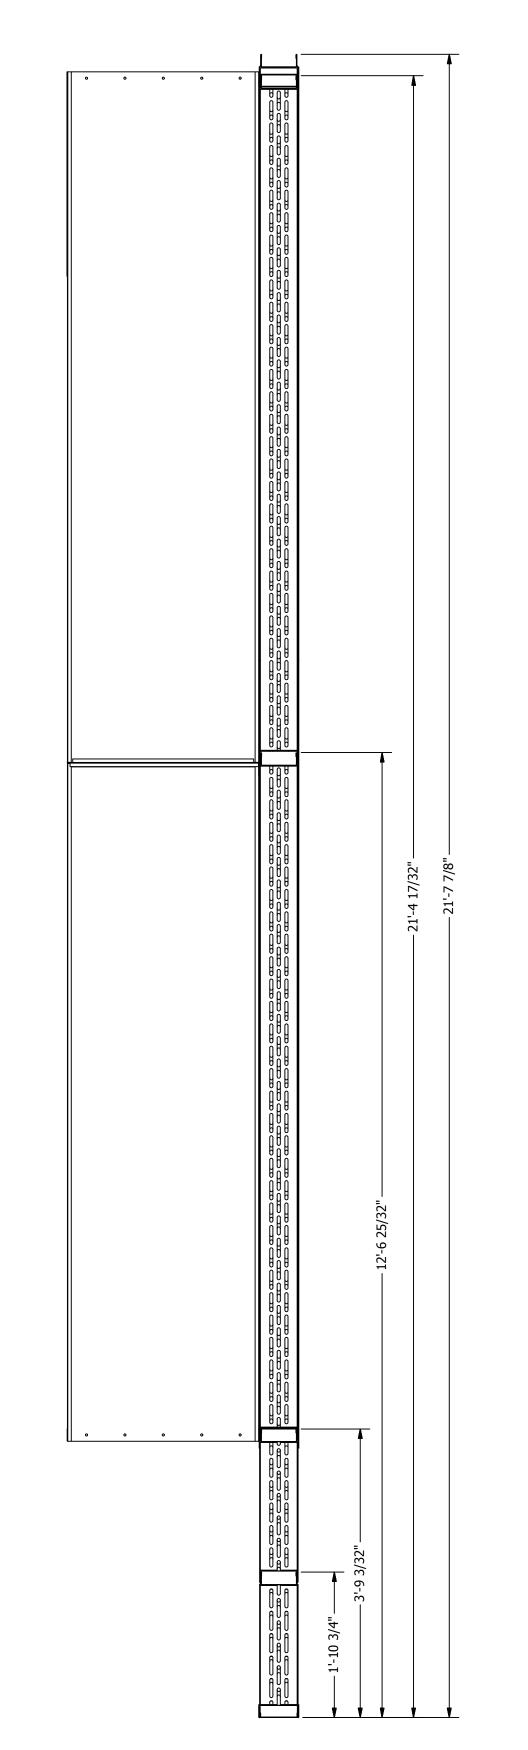





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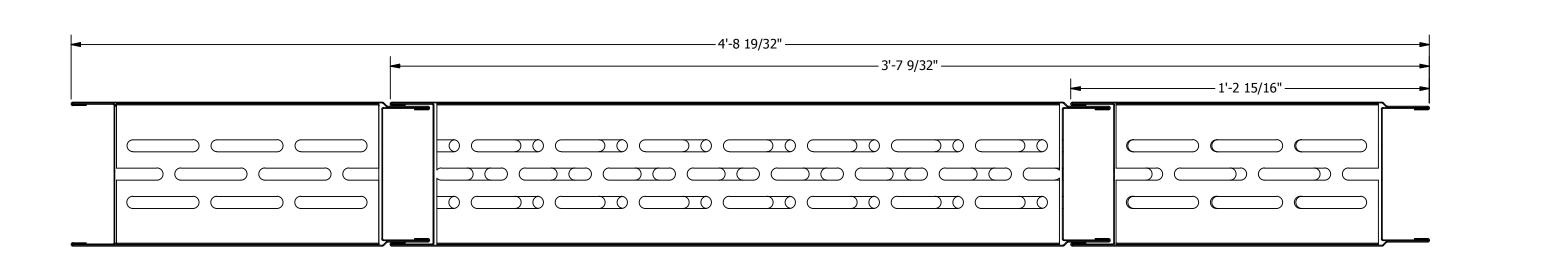
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REV: 16.1 - 12/28/16 DESCRIPTION OF CHANGE(S): Construction Set

DRAWING TITLE: EXPLODED ISOMETRIC ASSEMBLY DRAWING





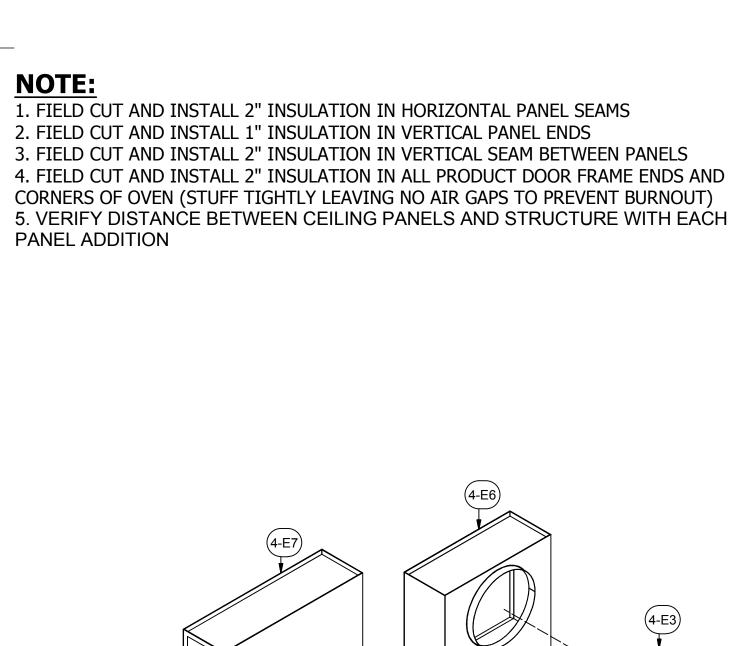

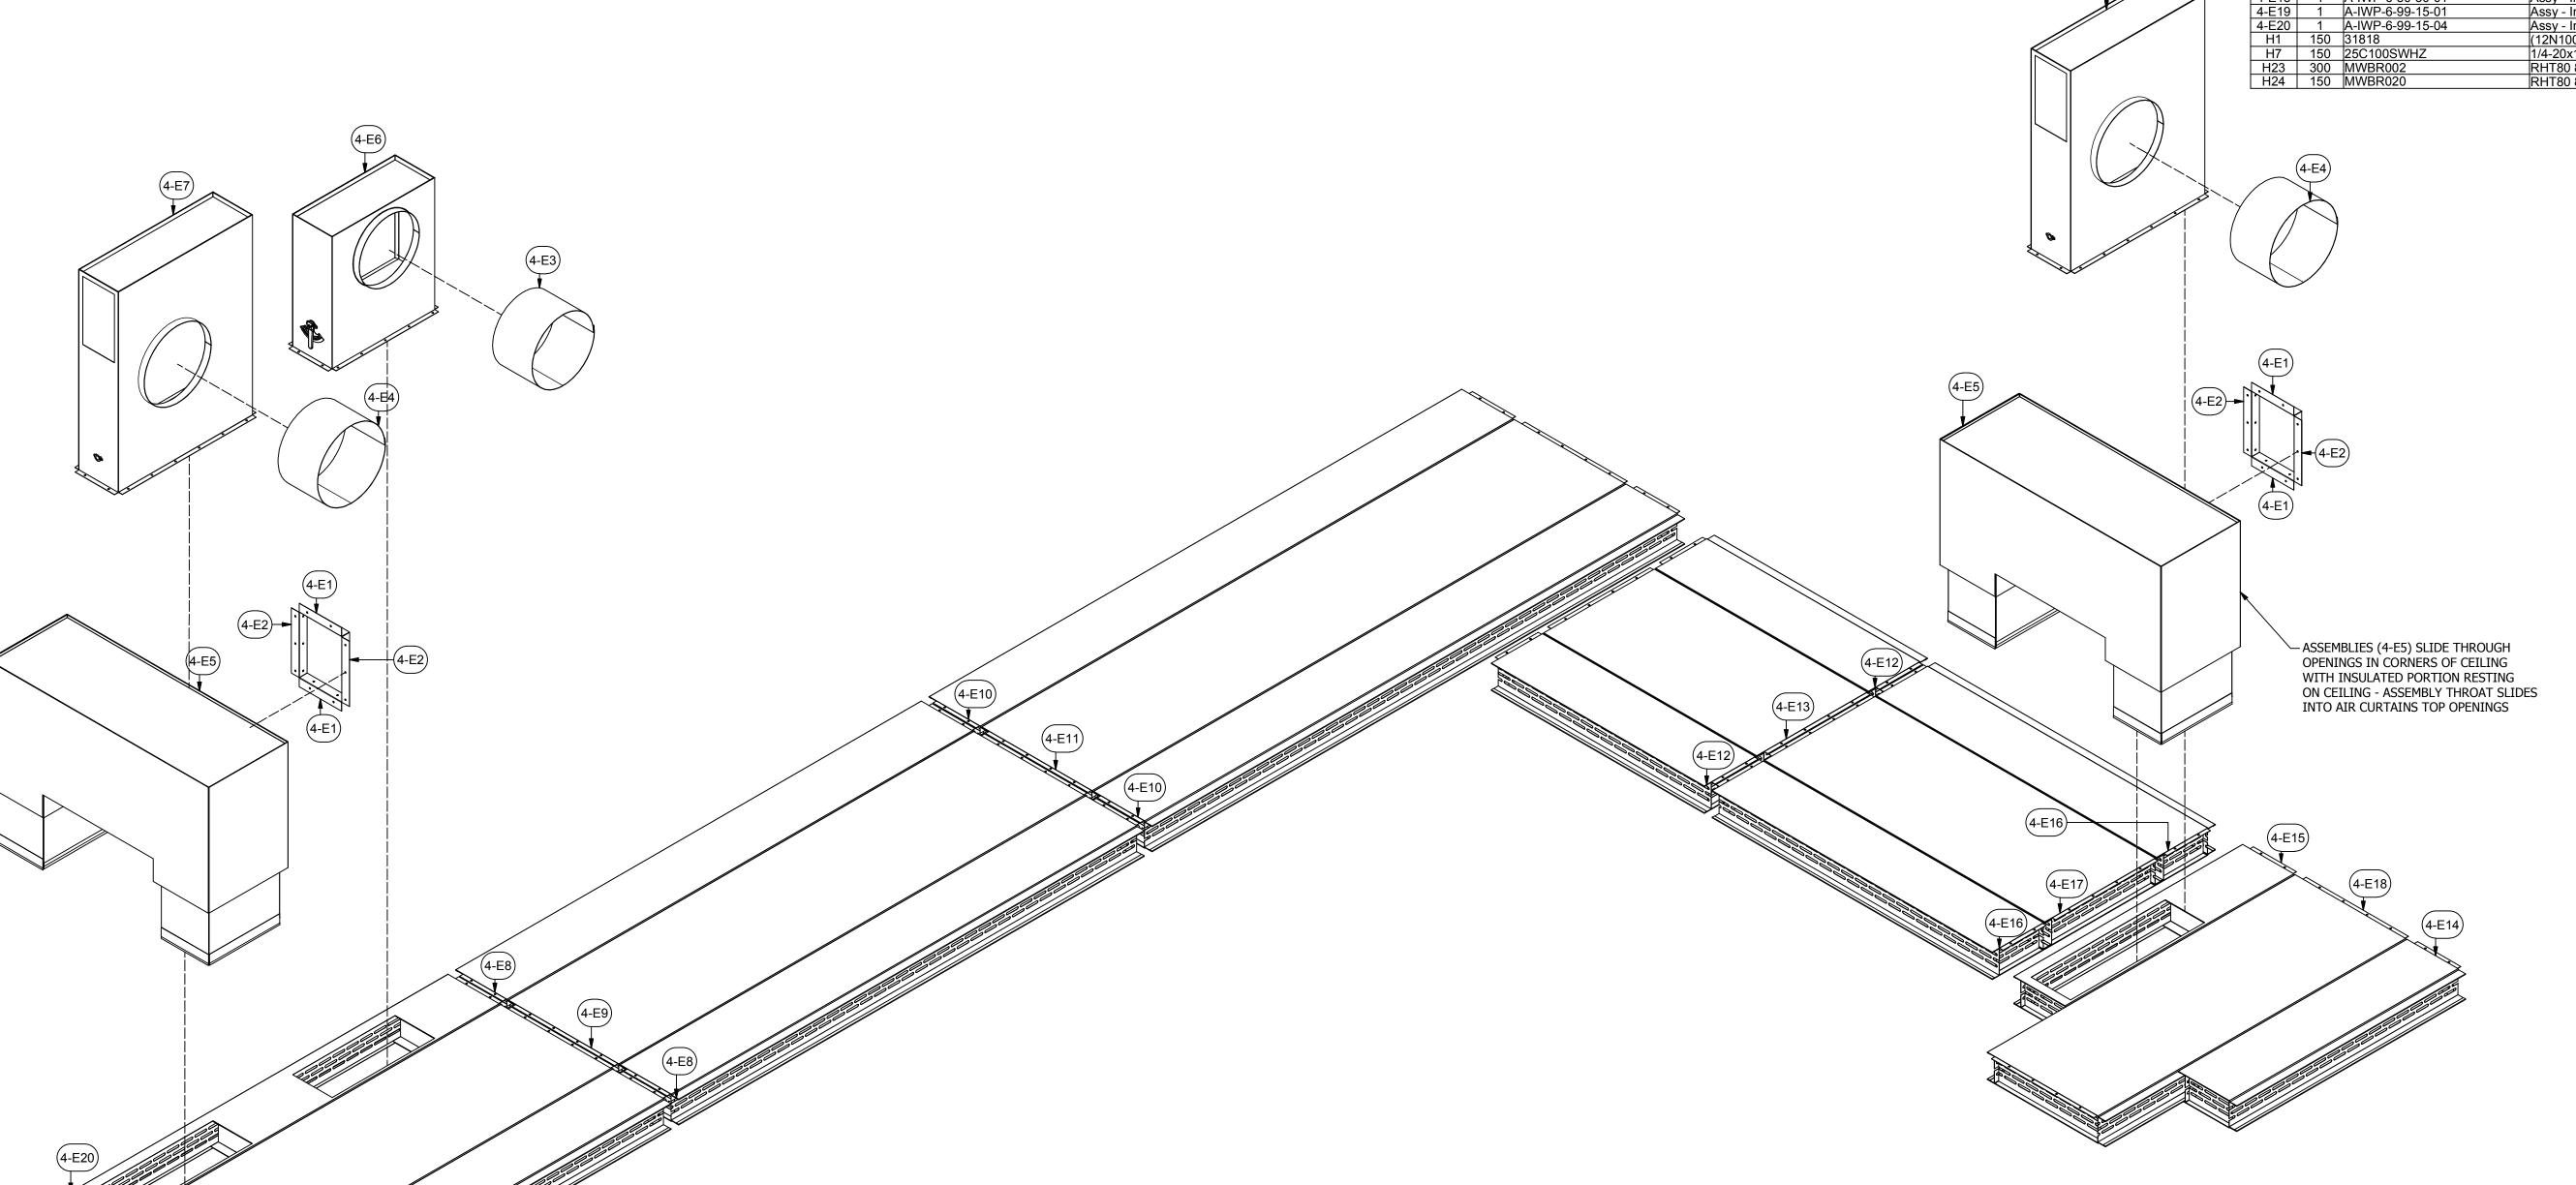PRESCIENT

VATOR RALPH SCOTT PARKW

MFRANE NC 27302

SE

2125

DRAWN BY: H
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ISSUED DATE: 12/28/16

REV: 16.1 - 12/28/16

DESCRIPTION OF CHANGE(S):

Construction Set

DRAWING TITLE:
EXPLODED
ISOMETRIC
ASSEMBLY
DRAWING

R2016151
EQUIP. NO:
POHT-WP-4.5-21.5

POHT-WP-4.5-21.5-50

SHEET NO:

4.5

NOTE:

1. FEMALE END OF THE DUCT SLIPS OVER FLANGED MALE END AND IS FASTENED WITH #12 X 3/4" TEK SCREWS 6" O.C.

			PARTS LIST		
ITEM	QTY	PART NUMBER	DESCRIPTION		
4-F1	1	A-18OD-30-100-13-01	Assy - 18 ga Oven Duct		
4-F2	1	A-18OD-E-31-30-42-01	Assy - 18 ga Oven Duct		
4-F3	1	A-18OD-31-30-48-03	Assy - 18 ga Oven Duct		
4-F4	1	A-18OD-31-30-48-04	Assy - 18 ga Oven Duct		
4-F5	7	A-18OD-31-30-48-05	Assy - 18 ga Oven Duct		
4-F6	1	A-18OD-E-31-30-19-01	Assy - 18 ga Oven Duct		
4-F7	1	A-18OD-31-30-48-06	Assy - 18 ga Oven Duct		
4-F8	1	A-18OD-E-31-30-16-01	Assy - 18 ga Oven Duct		
4-AD1	1	A-18OD-37-104-12-01	Assy - 18 ga Oven Duct		

(12N100UHWZ) #12 Teks, 5/16x1



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ISSUED DATE: 12/28/16

REV: 16.1 - 12/28/16

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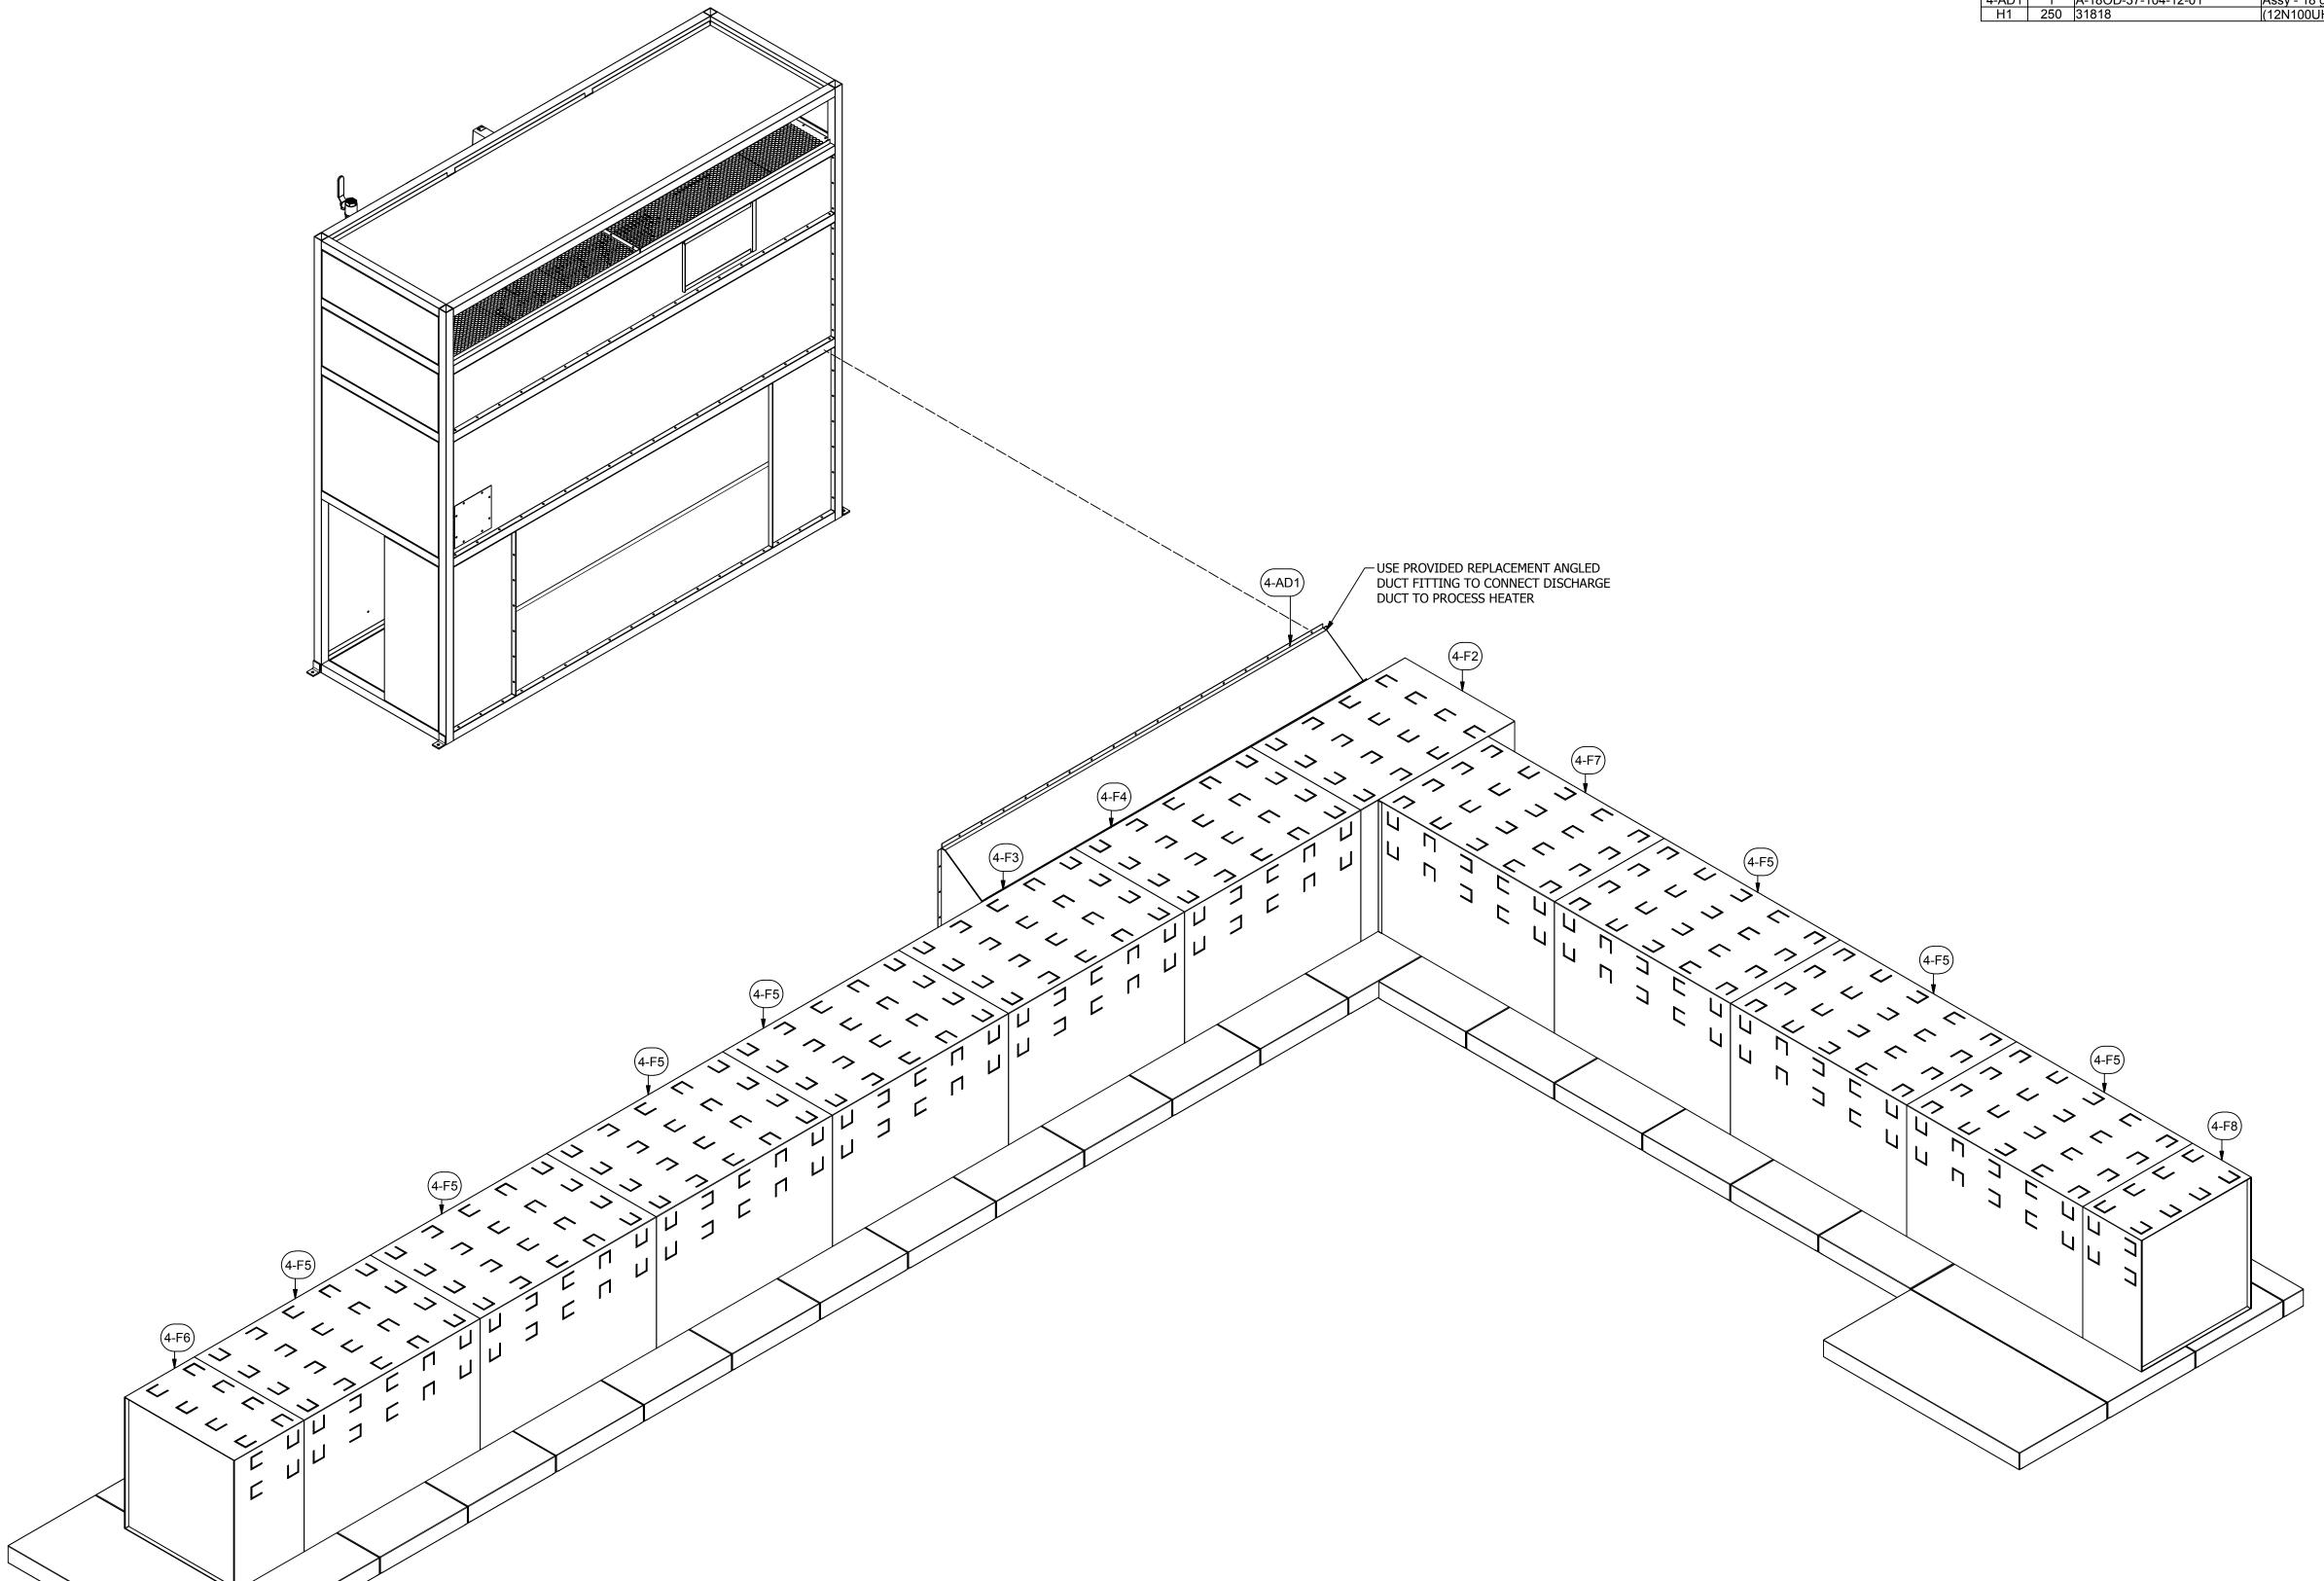
Construction Set

DRAWING TITLE:
EXPLODED
ISOMETRIC
ASSEMBLY
DRAWING


R2016151

EQUIP. NO:
POHT-WP-4.5-21.5-50

SHEET NO:



NOTE:
- EXTERIOR FLASHING FASTENS TO OVEN
WITH PROVIDED HARDWARE (H1) 12" O.C.
- SOME FLASHING WILL REQUIRE FIELD
COPING

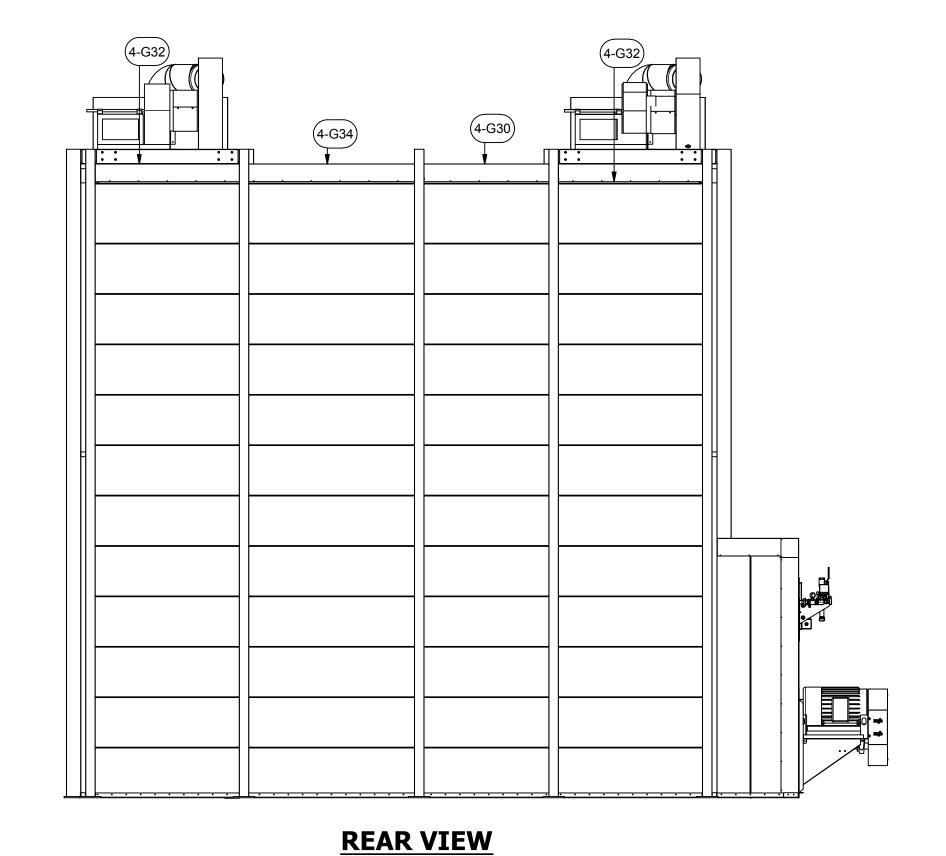

	PARTS LIST					
ITEM	QTY	PART NUMBER	DESCRIPTION			
4-G1	8	20RI-CCA-8-8-8-02	20 ga Rigid Insulation Corner Cap Angle			
4-G2	2	20RI-C-10-65-01	20 ga Rigid Insulation- Cap			
4-G3	2	20RI-C-12-54-01	20 ga Rigid Insulation- Cap			
4-G4	12	20RI-C-6-132-01	20 ga Rigid Insulation- Cap			
4-G5	3	20RI-C-6-52-01	20 ga Rigid Insulation- Cap			
4-G6	2	20RI-C-8-106-01	20 ga Rigid Insulation- Cap			
4-G7	1	20RI-C-8-108-01	20 ga Rigid Insulation- Cap			
4-G8	4	20RI-CA-12-10-132-02	20 ga Rigid Insulation- Cap Angle			
4-G9	2	20RI-CA-6-3-52-02	20 ga Rigid Insulation- Cap Angle			
4-G10	1	20RI-CA-6-6-117-02	20 ga Rigid Insulation- Cap Angle			
4-G11	6	20RI-CA-6-6-120	20 ga Rigid Insulation- Cap Angle			
4-G12	2	20RI-CA-6-6-120-02	20 ga Rigid Insulation- Cap Angle			
4-G13	1	20RI-CA-6-6-127-02	20 ga Rigid Insulation- Cap Angle			
4-G14	12	20RI-CA-6-6-132-02	20 ga Rigid Insulation- Cap Angle			
4-G15	1	20RI-CA-6-6-134-02	20 ga Rigid Insulation- Cap Angle			
4-G16	6	20RI-CA-6-6-144	20 ga Rigid Insulation- Cap Angle			
4-G17	1	20RI-CA-6-6-55.5-02	20 ga Rigid Insulation- Cap Angle			
4-G18	1	20RI-CA-6-6-57.8-02	20 ga Rigid Insulation- Cap Angle			
4-G19	1	20RI-CA-6-6-73-02	20 ga Rigid Insulation- Cap Angle			
4-G20	1	20RI-CA-6-6-81-02	20 ga Rigid Insulation- Cap Angle			
4-G21	2	20RI-CA-6-6-99-02	20 ga Rigid Insulation- Cap Angle			
4-G22	2	20RI-CA-8-8-102-01	20 ga Rigid Insulation- Cap Angle			
4-G23	1	20RI-CA-8-8-108-01	20 ga Rigid Insulation- Cap Angle			
4-G24	1	20RI-CA-8-8-11-01	20 ga Rigid Insulation- Cap Angle			
4-G25	4	20RI-CA-8-8-117-01	20 ga Rigid Insulation- Cap Angle			
4-G26	1	20RI-CA-8-8-132-01	20 ga Rigid Insulation- Cap Angle			
4-G27	2	20RI-CA-8-8-26.5-01	20 ga Rigid Insulation- Cap Angle			
4-G28	1	20RI-CA-8-8-32-02	20 ga Rigid Insulation- Cap Angle			
4-G29	1	20RI-CA-8-8-32-03	20 ga Rigid Insulation- Cap Angle			
4-G30	2	20RI-CA-8-8-53-01	20 ga Rigid Insulation- Cap Angle			
4-G31	2	20RI-CA-8-8-58-01	20 ga Rigid Insulation- Cap Angle			
4-G32	2	20RI-CA-8-8-60-01	20 ga Rigid Insulation- Cap Angle			
4-G33	1	20RI-CA-8-8-67-01	20 ga Rigid Insulation- Cap Angle			
4-G34	2	20RI-CA-8-8-70-01	20 ga Rigid Insulation- Cap Angle			
4-G35	1	20RI-CA-8-8-80-01	20 ga Rigid Insulation- Cap Angle			
H1	1400	31818	(12N100UHWZ) #12 Teks, 5/16x1			
H23	600	MWBR002	RHT80 8# 2" x 24" x48" insulation			






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Construction Set DRAWING TITLE: EXPLODED ISOMETRIC ASSEMBLY DRAWING


POHT-WP-4.5-21.5-50
SHEET NO:








NOTE:- EXTERIOR FLASHING FASTENS TO OVEN WITH PROVIDED HARDWARE (H1) 12" O.C.
- SOME FLASHING WILL REQUIRE FIELD
COPING

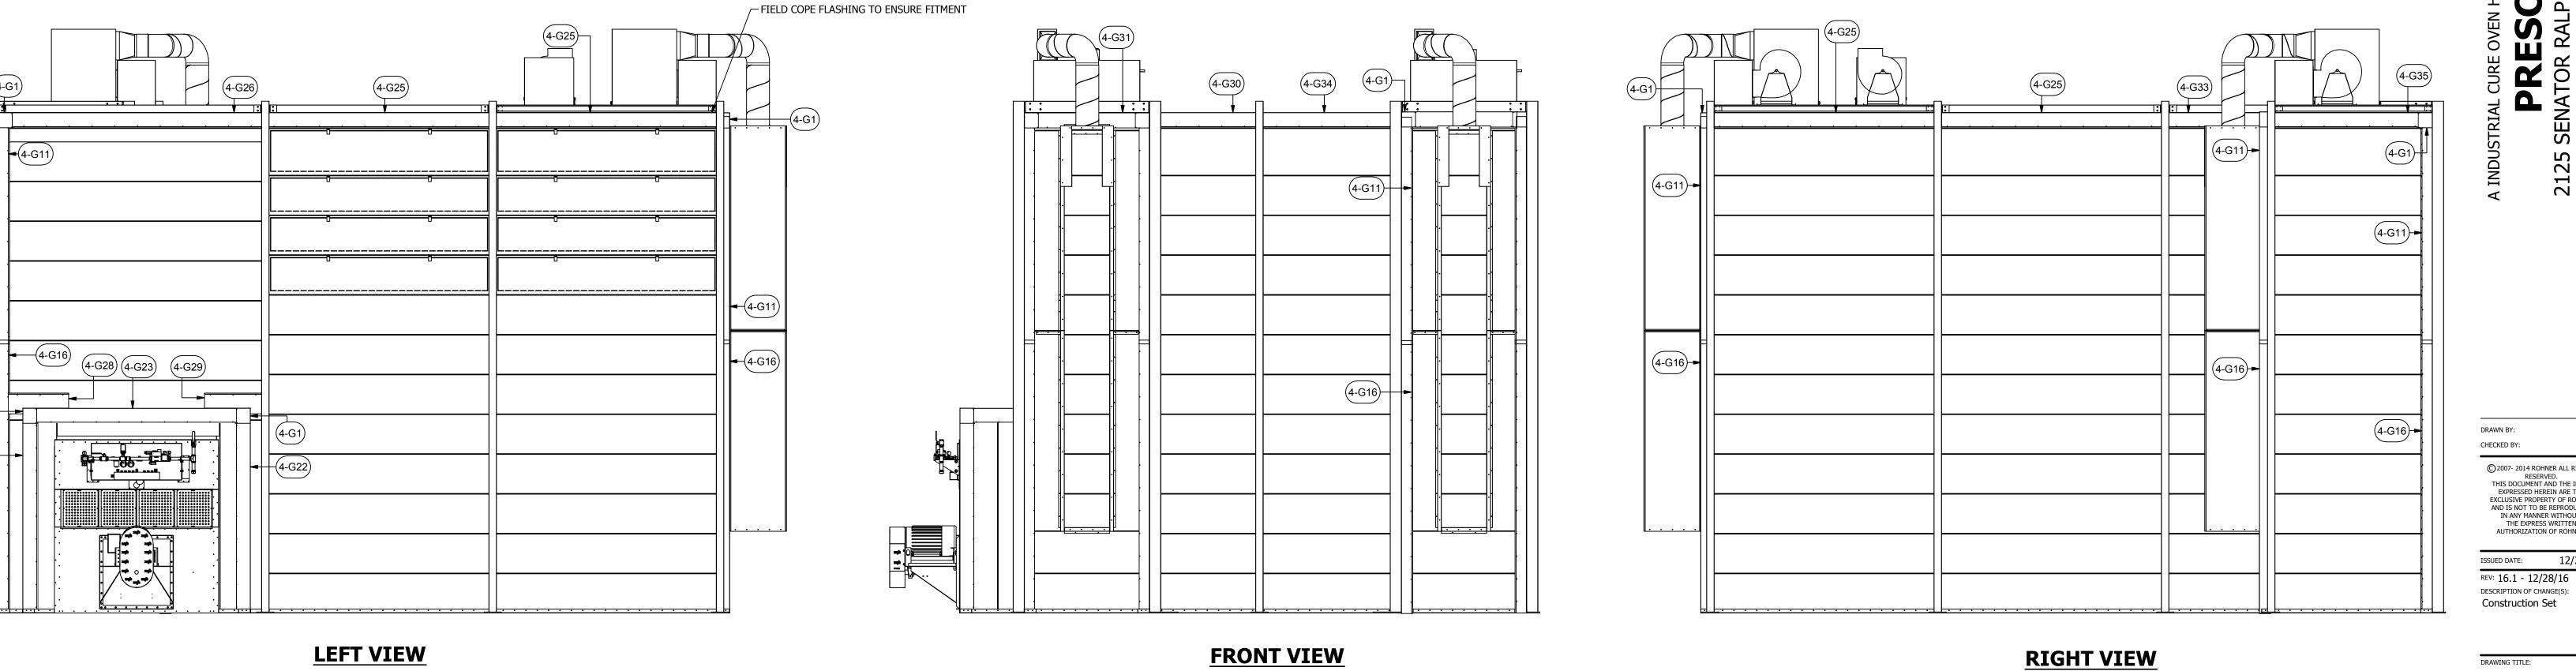			PARTS LIST
ITEM QTY PART NUMBER		PART NUMBER	DESCRIPTION
4-G1	8	20RI-CCA-8-8-8-02	20 ga Rigid Insulation Corner Cap Angle
4-G2	2	20RI-C-10-65-01	20 ga Rigid Insulation- Cap
4-G3	2	20RI-C-12-54-01	20 ga Rigid Insulation- Cap
4-G4	12	20RI-C-6-132-01	20 ga Rigid Insulation- Cap
4-G5	3	20RI-C-6-52-01	20 ga Rigid Insulation- Cap
4-G6	2	20RI-C-8-106-01	20 ga Rigid Insulation- Cap
4-G7	1	20RI-C-8-108-01	20 ga Rigid Insulation- Cap
4-G8	4	20RI-CA-12-10-132-02	20 ga Rigid Insulation- Cap Angle
4-G9	2	20RI-CA-6-3-52-02	20 ga Rigid Insulation- Cap Angle
4-G10	1	20RI-CA-6-6-117-02	20 ga Rigid Insulation- Cap Angle
4-G11	6	20RI-CA-6-6-120	20 ga Rigid Insulation- Cap Angle
4-G12	2	20RI-CA-6-6-120-02	20 ga Rigid Insulation- Cap Angle
4-G13	1	20RI-CA-6-6-127-02	20 ga Rigid Insulation- Cap Angle
4-G14	12	20RI-CA-6-6-132-02	20 ga Rigid Insulation- Cap Angle
4-G15	1	20RI-CA-6-6-134-02	20 ga Rigid Insulation- Cap Angle
4-G16	6	20RI-CA-6-6-144	20 ga Rigid Insulation- Cap Angle
4-G17	1	20RI-CA-6-6-55.5-02	20 ga Rigid Insulation- Cap Angle
4-G18	1	20RI-CA-6-6-57.8-02	20 ga Rigid Insulation- Cap Angle
4-G19	1	20RI-CA-6-6-73-02	20 ga Rigid Insulation- Cap Angle
4-G20	1	20RI-CA-6-6-81-02	20 ga Rigid Insulation- Cap Angle
4-G21	2	20RI-CA-6-6-99-02	20 ga Rigid Insulation- Cap Angle
4-G22	2	20RI-CA-8-8-102-01	20 ga Rigid Insulation- Cap Angle
4-G23	1	20RI-CA-8-8-108-01	20 ga Rigid Insulation- Cap Angle
4-G24	1	20RI-CA-8-8-11-01	20 ga Rigid Insulation- Cap Angle
4-G25	4	20RI-CA-8-8-117-01	20 ga Rigid Insulation- Cap Angle
4-G26	1	20RI-CA-8-8-132-01	20 ga Rigid Insulation- Cap Angle
4-G27	2	20RI-CA-8-8-26.5-01	20 ga Rigid Insulation- Cap Angle
4-G28	1	20RI-CA-8-8-32-02	20 ga Rigid Insulation- Cap Angle
4-G29	1	20RI-CA-8-8-32-03	20 ga Rigid Insulation- Cap Angle
4-G30	2	20RI-CA-8-8-53-01	20 ga Rigid Insulation- Cap Angle
4-G31	2	20RI-CA-8-8-58-01	20 ga Rigid Insulation- Cap Angle
4-G32	2	20RI-CA-8-8-60-01	20 ga Rigid Insulation- Cap Angle
4-G33	1	20RI-CA-8-8-67-01	20 ga Rigid Insulation- Cap Angle
4-G34	2	20RI-CA-8-8-70-01	20 ga Rigid Insulation- Cap Angle
4-G35	1	20RI-CA-8-8-80-01	20 ga Rigid Insulation- Cap Angle
H1		31818	(12N100UHWZ) #12 Teks, 5/16x1
H23	600	MWBR002	RHT80 8# 2" x 24" x48" insulation

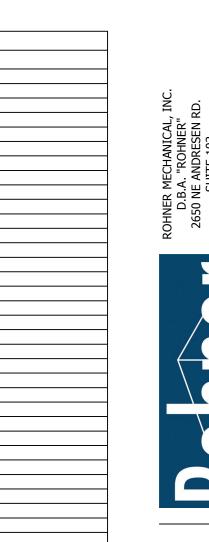

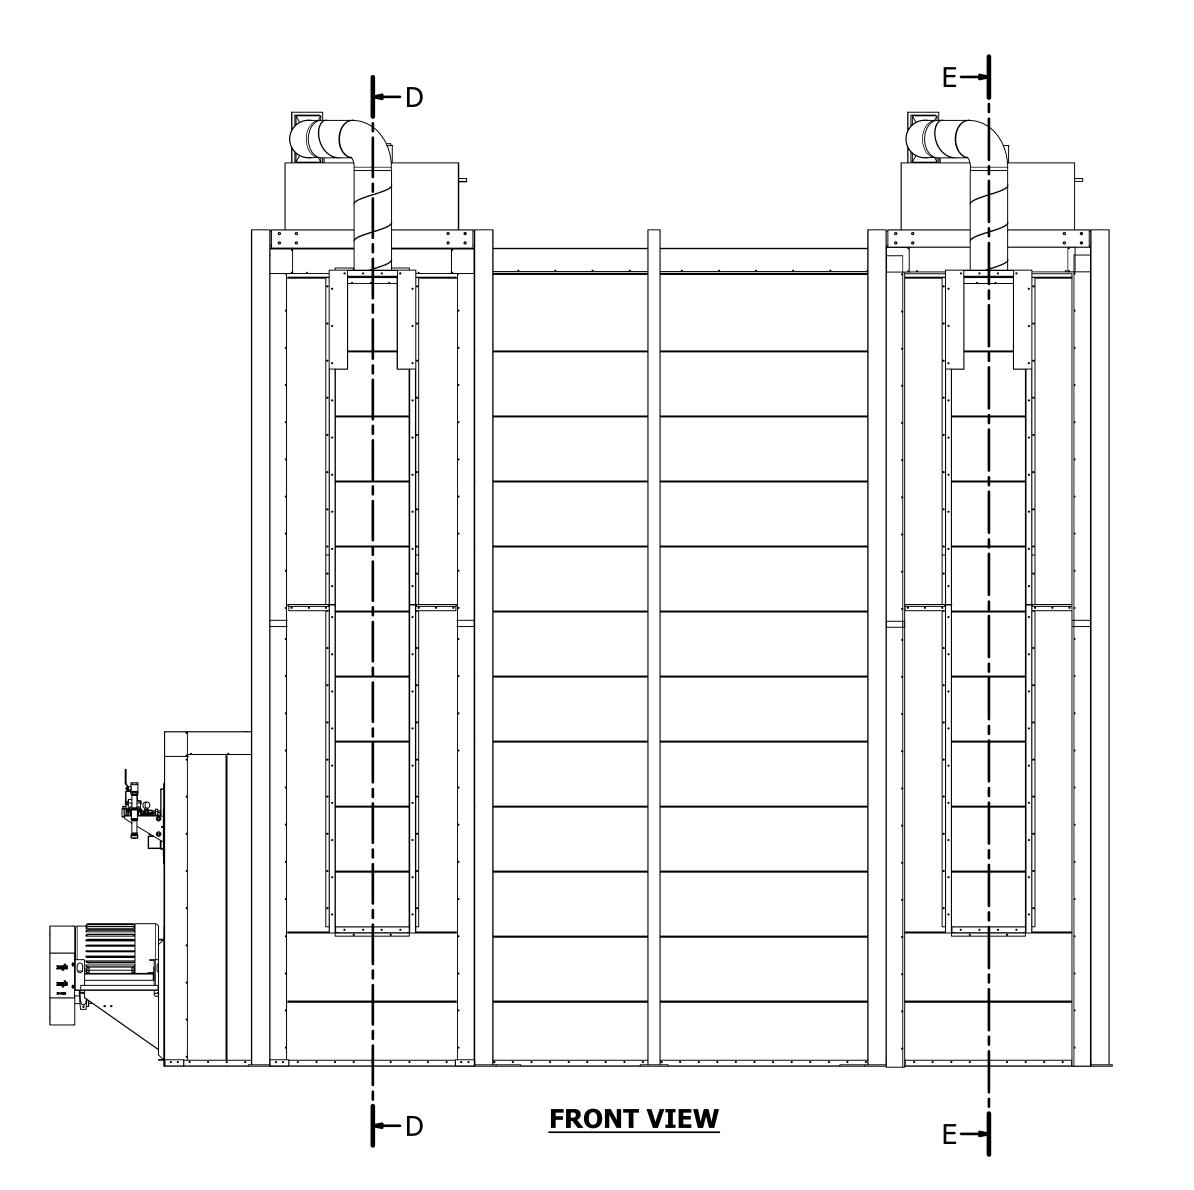

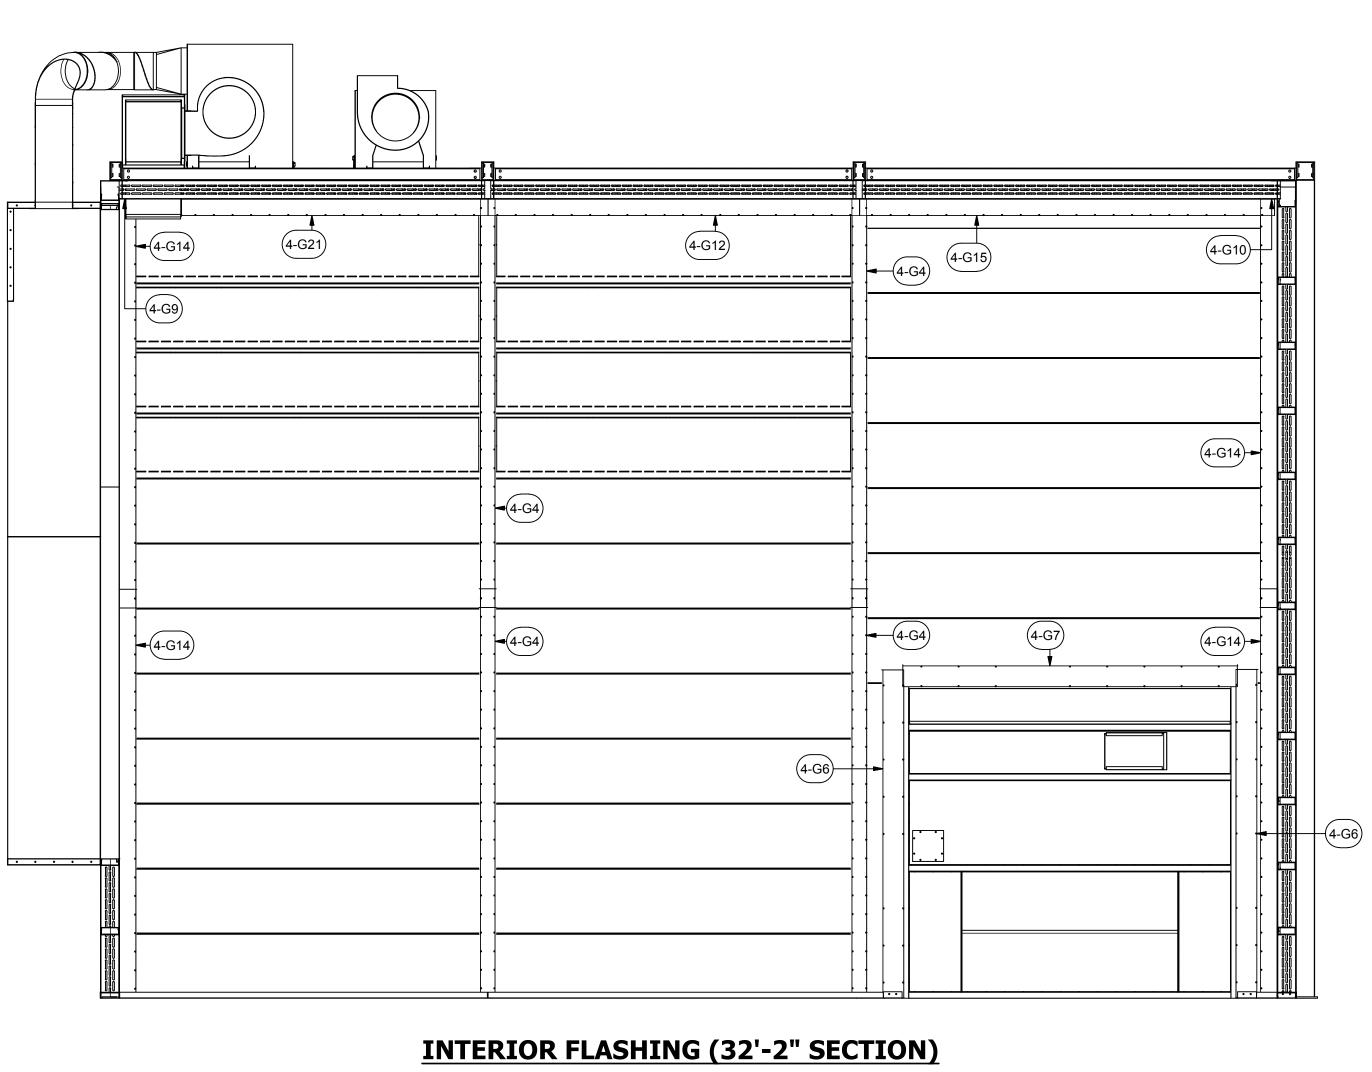

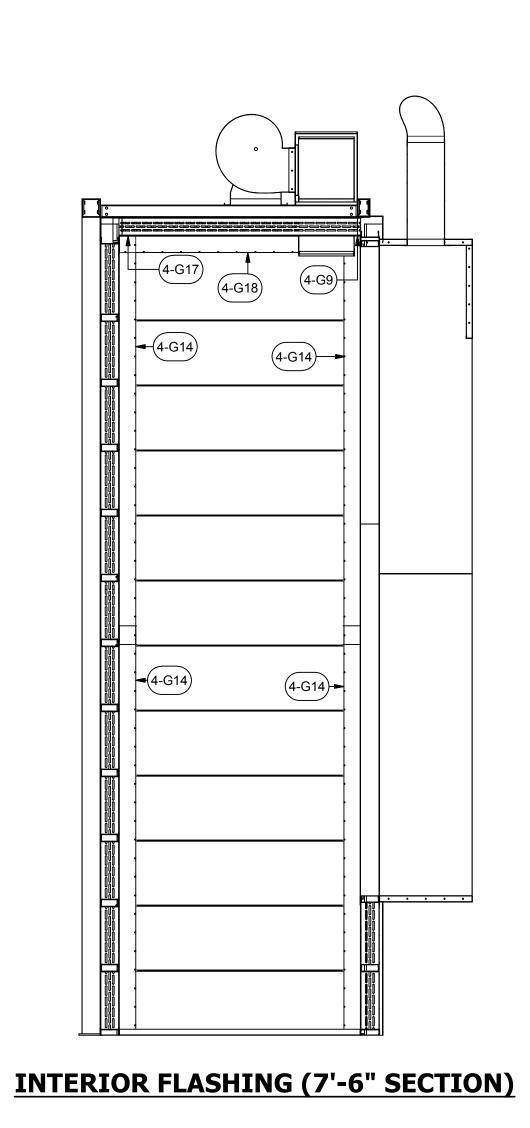

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ISSUED DATE: 12/28/16 REV: 16.1 - 12/28/16
DESCRIPTION OF CHANGE(S):
Construction Set

DRAWING TITLE: EXPLODED ISOMETRIC ASSEMBLY DRAWING


R2016151

EQUIP. NO:
POHT-WP-4.5-21.5-50
SHEET NO:

NOTE:
- EXTERIOR FLASHING FASTENS TO OVEN
WITH PROVIDED HARDWARE (H1) 12" O.C.
- SOME FLASHING WILL REQUIRE FIELD
COPING

PARTS LIST						
ITEM	QTY	PART NUMBER	DESCRIPTION			
4-G1	8	20RI-CCA-8-8-8-02	20 ga Rigid Insulation Corner Cap Angle			
4-G2	2	20RI-C-10-65-01	20 ga Rigid Insulation- Cap			
4-G3	2	20RI-C-12-54-01	20 ga Rigid Insulation- Cap			
4-G4	12	20RI-C-6-132-01	20 ga Rigid Insulation- Cap			
4-G5	3	20RI-C-6-52-01	20 ga Rigid Insulation- Cap			
4-G6	2	20RI-C-8-106-01	20 ga Rigid Insulation- Cap			
4-G7	1	20RI-C-8-108-01	20 ga Rigid Insulation- Cap			
4-G8	4	20RI-CA-12-10-132-02	20 ga Rigid Insulation- Cap Angle			
4-G9	2	20RI-CA-6-3-52-02	20 ga Rigid Insulation- Cap Angle			
4-G10	1	20RI-CA-6-6-117-02	20 ga Rigid Insulation- Cap Angle			
4-G11	6	20RI-CA-6-6-120	20 ga Rigid Insulation- Cap Angle			
4-G12	2	20RI-CA-6-6-120-02	20 ga Rigid Insulation- Cap Angle			
4-G13	1	20RI-CA-6-6-127-02	20 ga Rigid Insulation- Cap Angle			
4-G14	12	20RI-CA-6-6-132-02	20 ga Rigid Insulation- Cap Angle			
4-G15	1	20RI-CA-6-6-134-02	20 ga Rigid Insulation- Cap Angle			
4-G16	6	20RI-CA-6-6-144	20 ga Rigid Insulation- Cap Angle			
4-G17	1	20RI-CA-6-6-55.5-02	20 ga Rigid Insulation- Cap Angle			
4-G18	1	20RI-CA-6-6-57.8-02	20 ga Rigid Insulation- Cap Angle			
4-G19	1	20RI-CA-6-6-73-02	20 ga Rigid Insulation- Cap Angle			
4-G20	1	20RI-CA-6-6-81-02	20 ga Rigid Insulation- Cap Angle			
4-G21	2	20RI-CA-6-6-99-02	20 ga Rigid Insulation- Cap Angle			
4-G22	2	20RI-CA-8-8-102-01	20 ga Rigid Insulation- Cap Angle			
4-G23	1	20RI-CA-8-8-108-01	20 ga Rigid Insulation- Cap Angle			
4-G24	1	20RI-CA-8-8-11-01	20 ga Rigid Insulation- Cap Angle			
4-G25	4	20RI-CA-8-8-117-01	20 ga Rigid Insulation- Cap Angle			
4-G26	1	20RI-CA-8-8-132-01	20 ga Rigid Insulation- Cap Angle			
4-G27	2	20RI-CA-8-8-26.5-01	20 ga Rigid Insulation- Cap Angle			
4-G28	1	20RI-CA-8-8-32-02	20 ga Rigid Insulation- Cap Angle			
4-G29	1	20RI-CA-8-8-32-03	20 ga Rigid Insulation- Cap Angle			
4-G30	2	20RI-CA-8-8-53-01	20 ga Rigid Insulation- Cap Angle			
4-G31	2	20RI-CA-8-8-58-01	20 ga Rigid Insulation- Cap Angle			
4-G32	2	20RI-CA-8-8-60-01	20 ga Rigid Insulation- Cap Angle			
4-G33	1	20RI-CA-8-8-67-01	20 ga Rigid Insulation- Cap Angle			
4-G34	2	20RI-CA-8-8-70-01	20 ga Rigid Insulation- Cap Angle			
4-G35	1	20RI-CA-8-8-80-01	20 ga Rigid Insulation- Cap Angle			
H1		31818	(12N100UHWZ) #12 Teks, 5/16x1			
H23	600	MWBR002	RHT80 8# 2" x 24" x48" insulation			



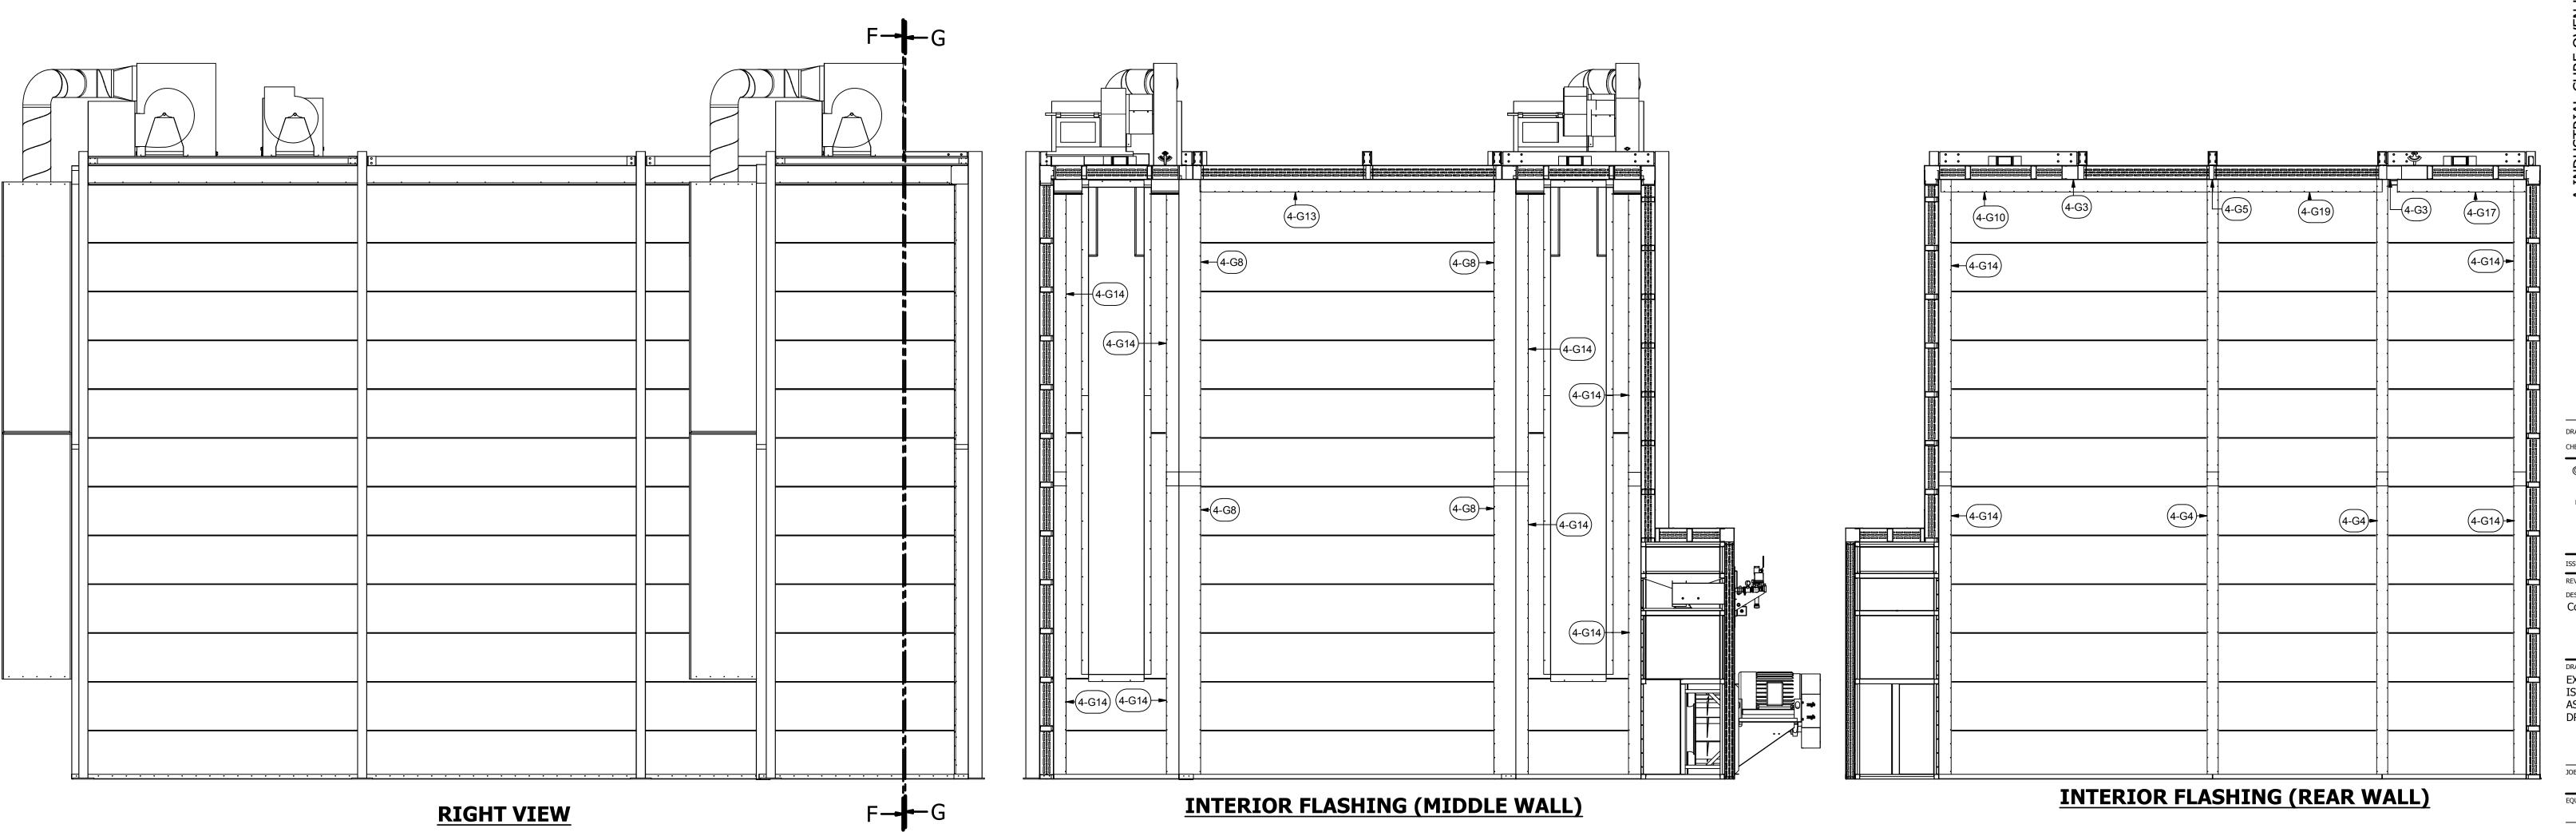

2125 SE


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REV: 16.1 - 12/28/16
DESCRIPTION OF CHANGE(S): Construction Set

EXPLODED ISOMETRIC ASSEMBLY DRAWING

R2016151

EQUIP. NO:
POHT-WP-4.5-21.5-50
SHEET NO:

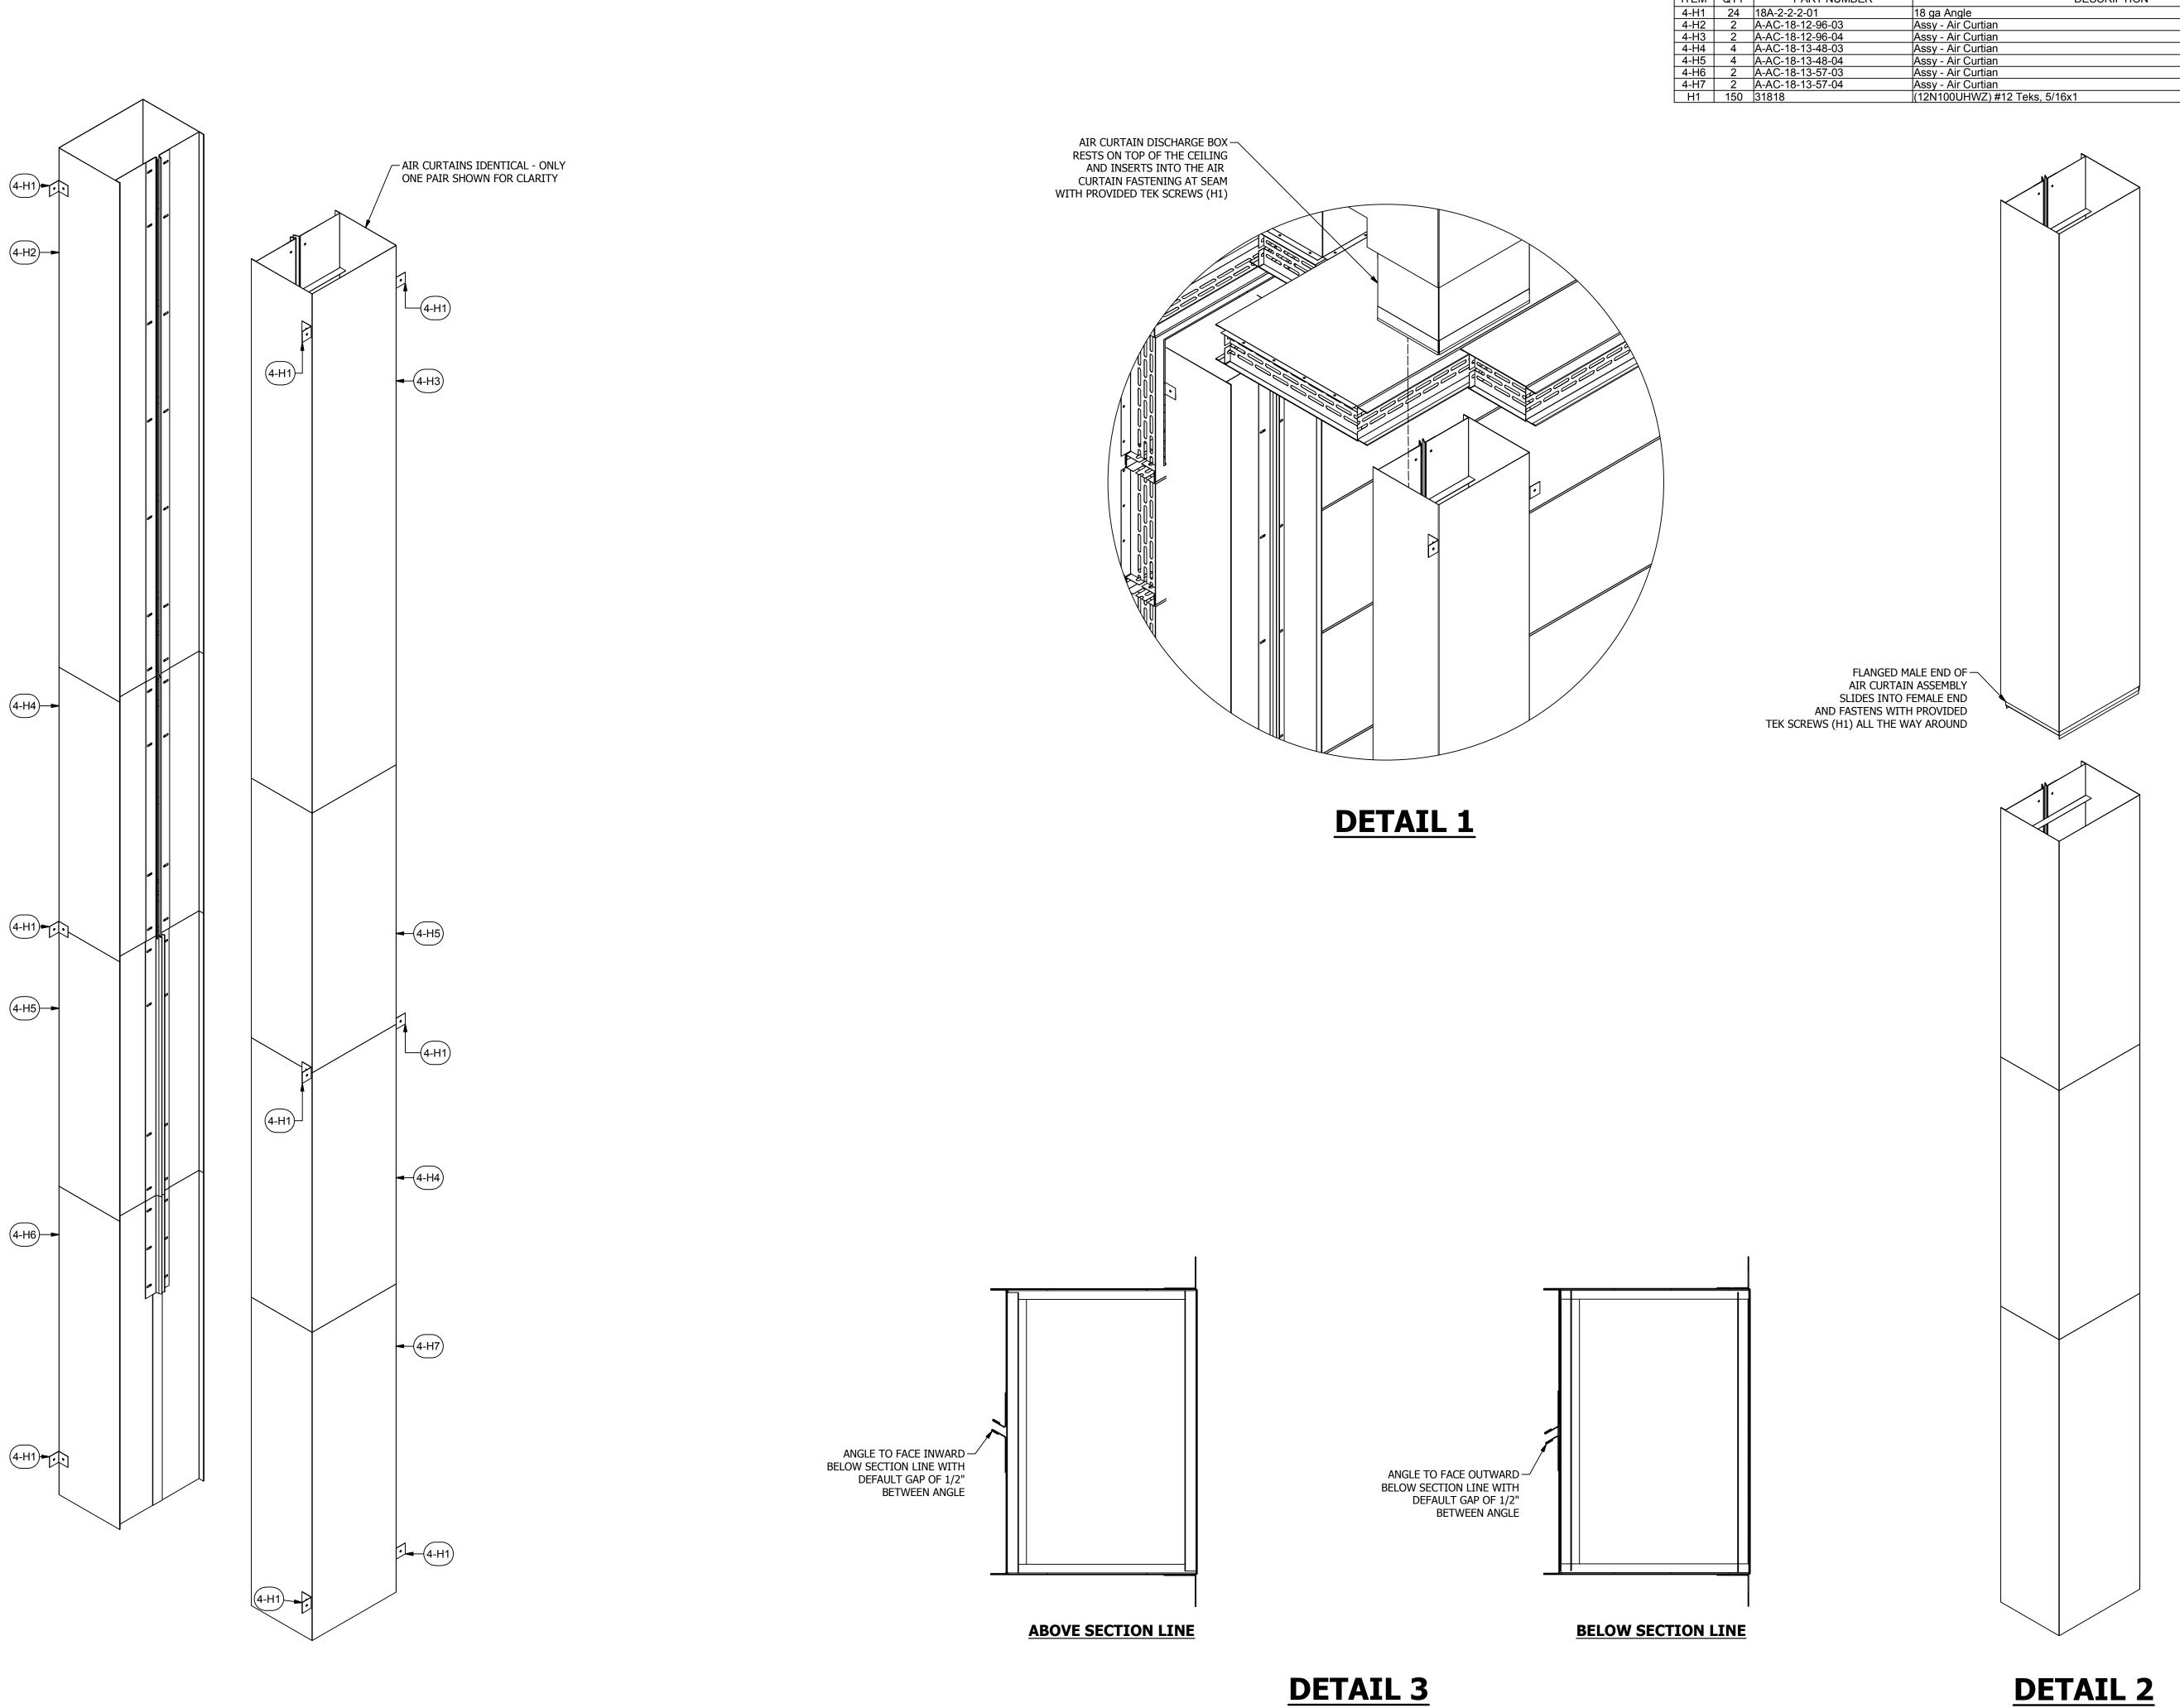

PARTS LIST

DESCRIPTION

PART NUMBER

2125 SE

DGR


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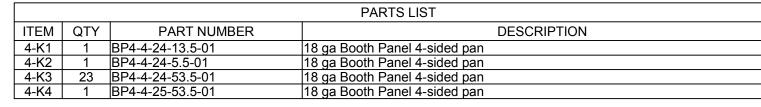
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DESCRIPTION OF CHANGE(S):
Construction Set

DRAWING TITLE: EXPLODED ISOMETRIC ASSEMBLY DRAWING

R2016151 POHT-WP-4.5-21.5-50-01
SHEET NO:

DETAIL 2



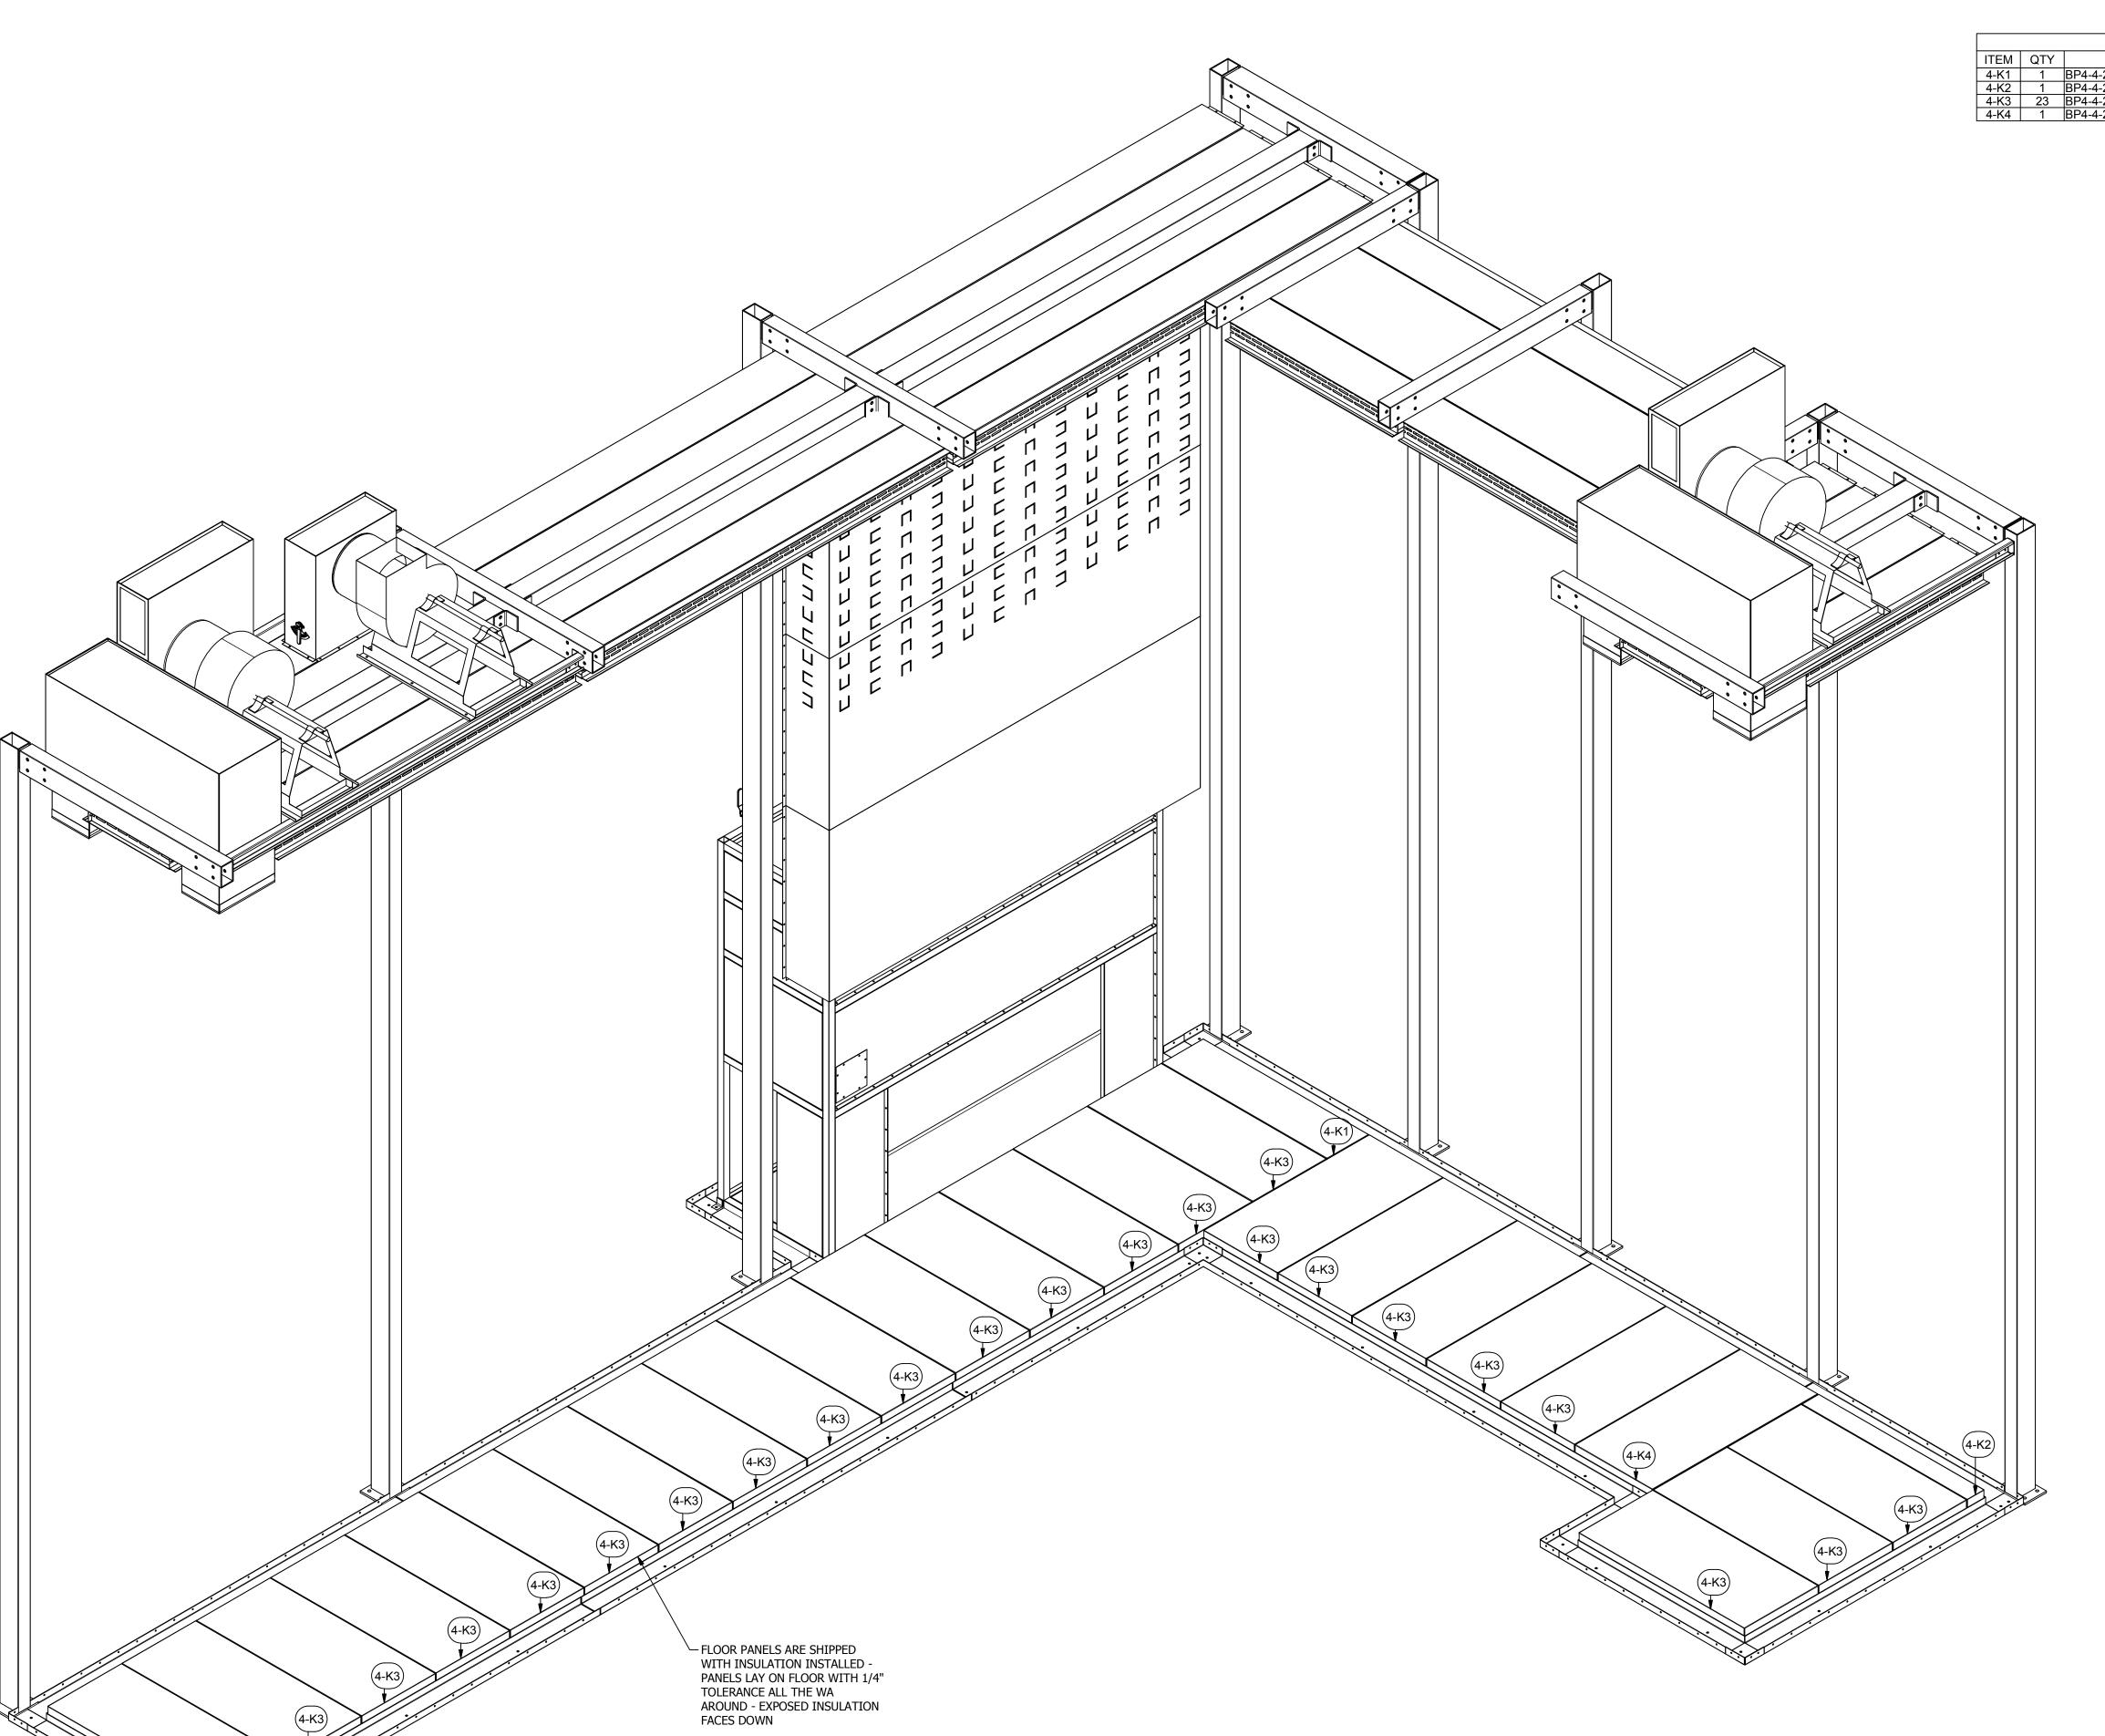





¥ ∀

PRESCIENT 2125 SENATOR RALPH SCOTT PA

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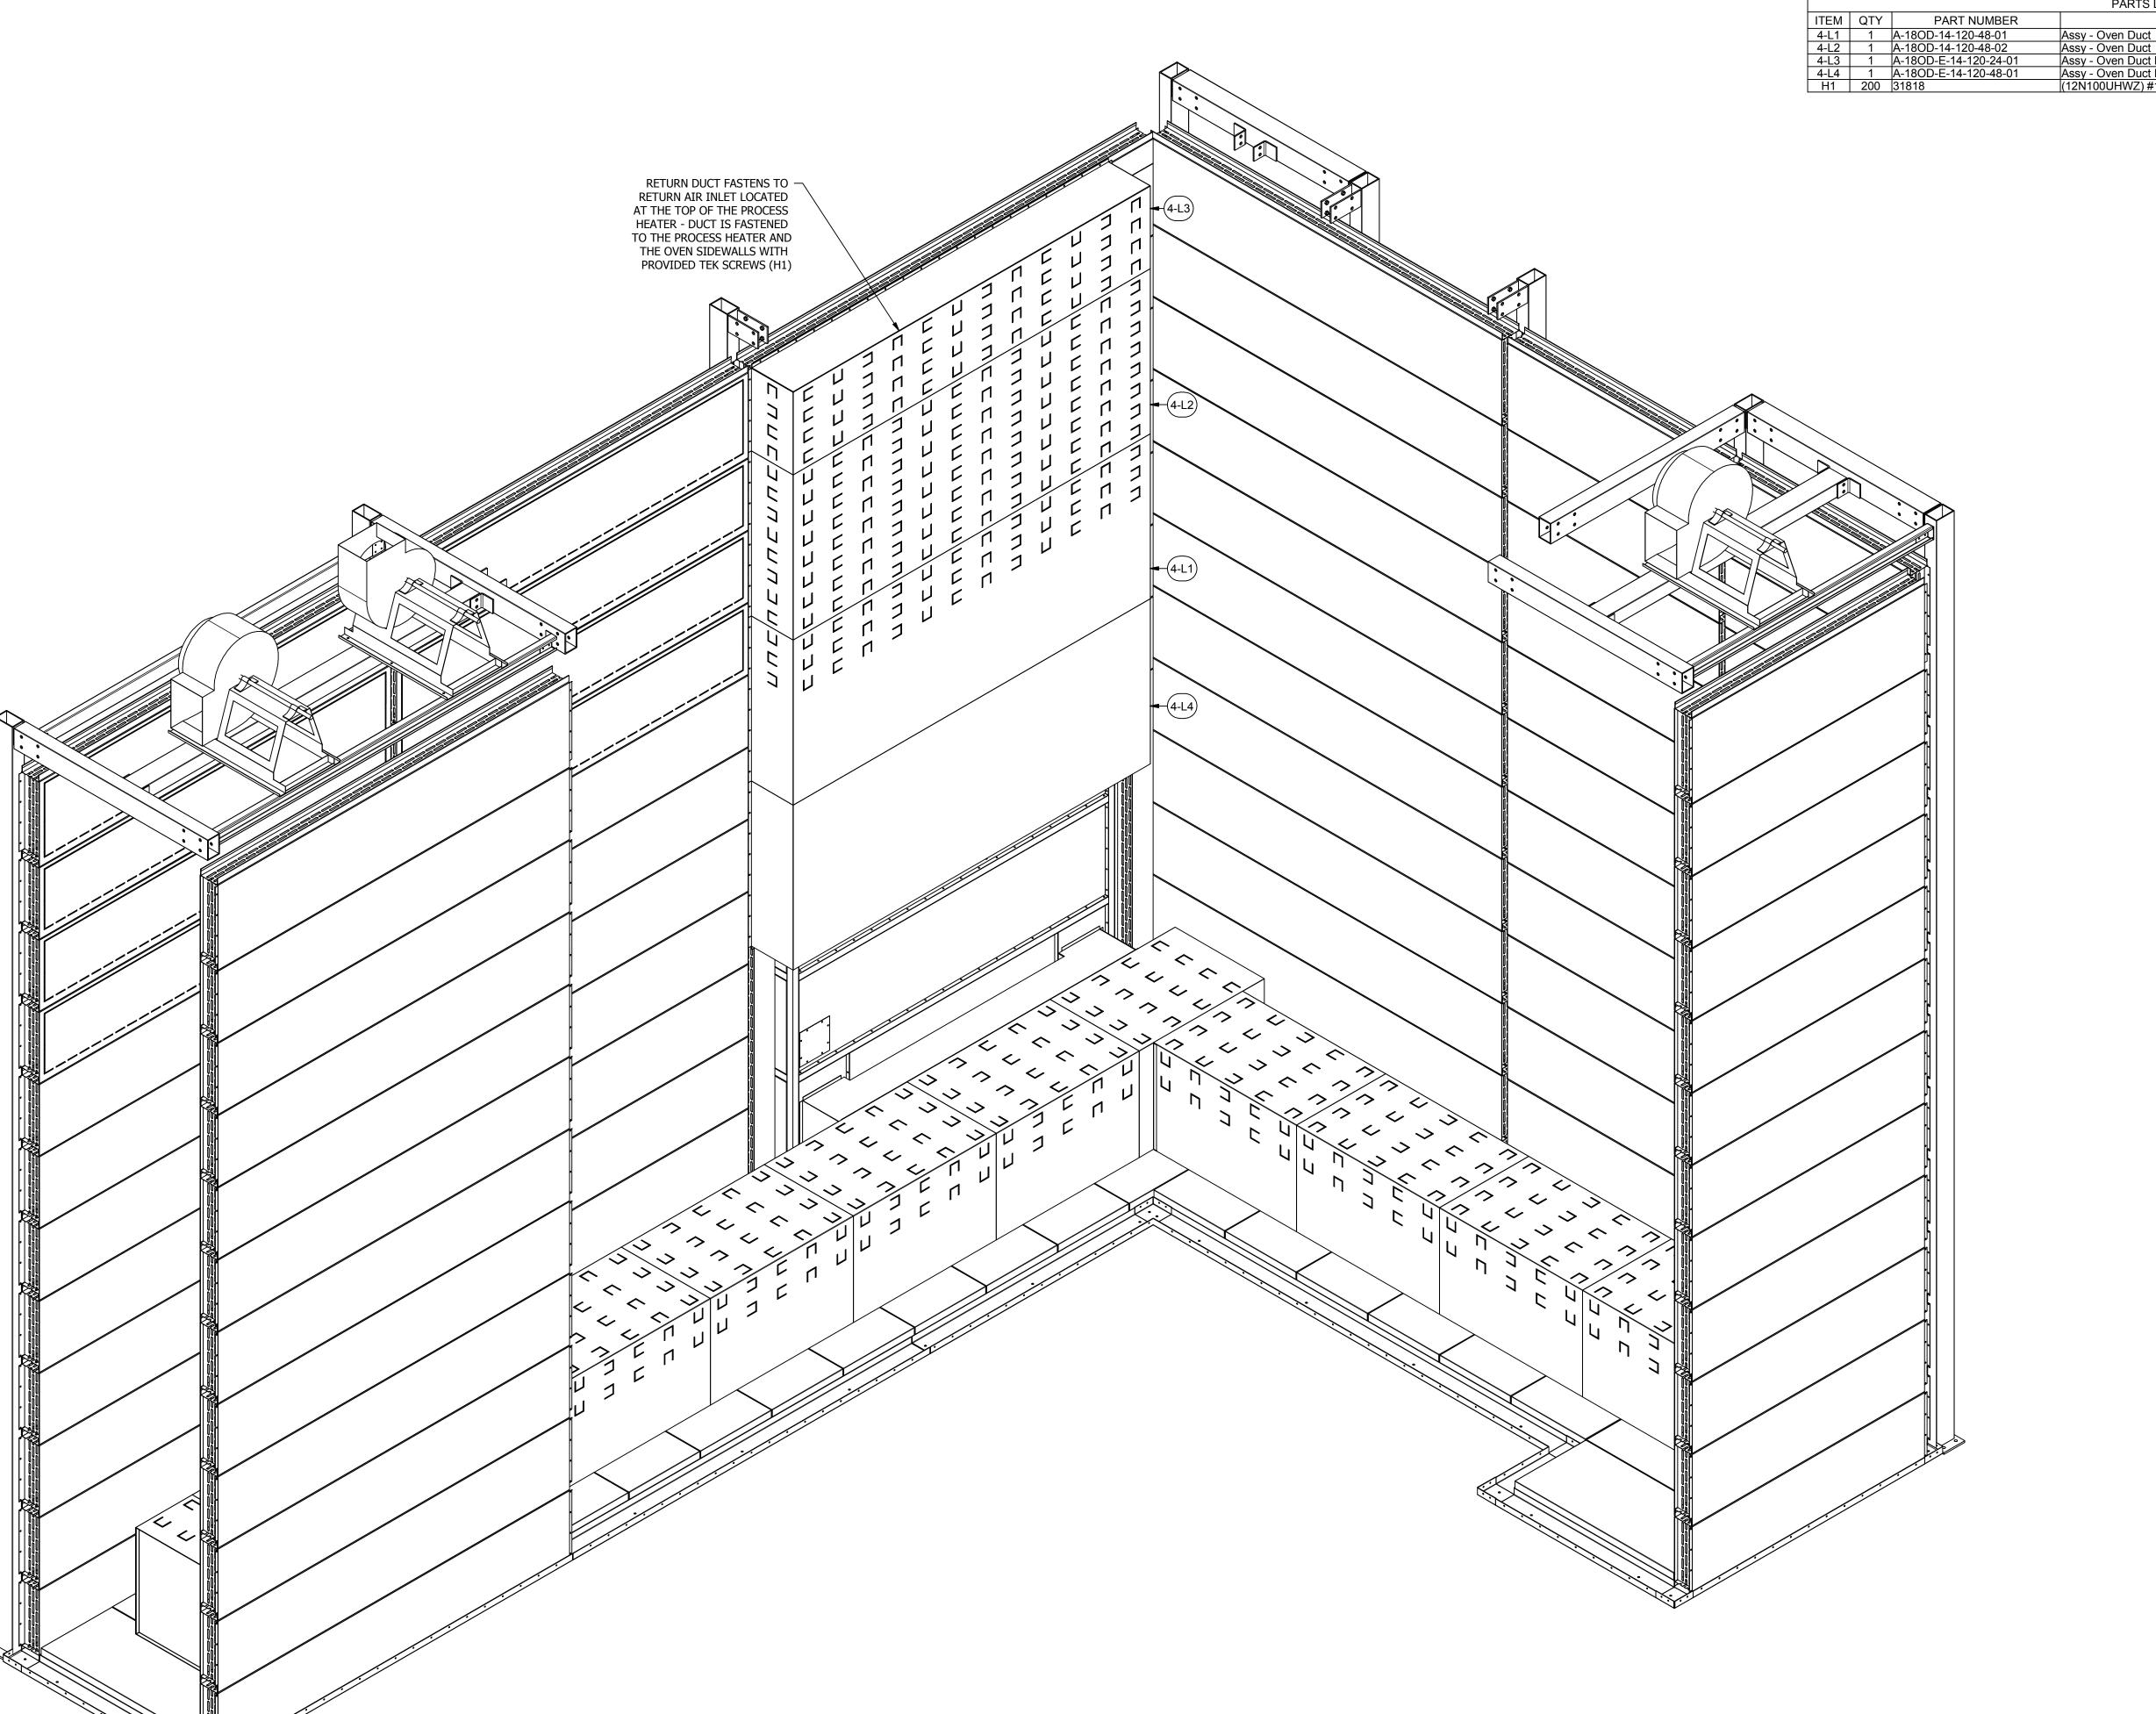
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DESCRIPTION OF CHANGE(S):
Construction Set

DRAWING TITLE:
EXPLODED
ISOMETRIC
ASSEMBLY
DRAWING

R2016151

EQUIP. NO:
POHT-WP-4.5-21.5-50-01

A O



PARTS LIST

M QTY PART NUMBER DESCRIPTION

1 1 A-18OD-14-120-48-01 Assy - Oven Duct
2 1 A-18OD-14-120-48-02 Assy - Oven Duct
3 1 A-18OD-E-14-120-24-01 Assy - Oven Duct End
4 1 A-18OD-E-14-120-48-01 Assy - Oven Duct End
200 31818 (12N100UHWZ) #12 Teks, 5/16x1





PRESCIENT
ATOR RALPH SCOTT PARKWAY

2125 SE

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HGS DGR


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Construction Set


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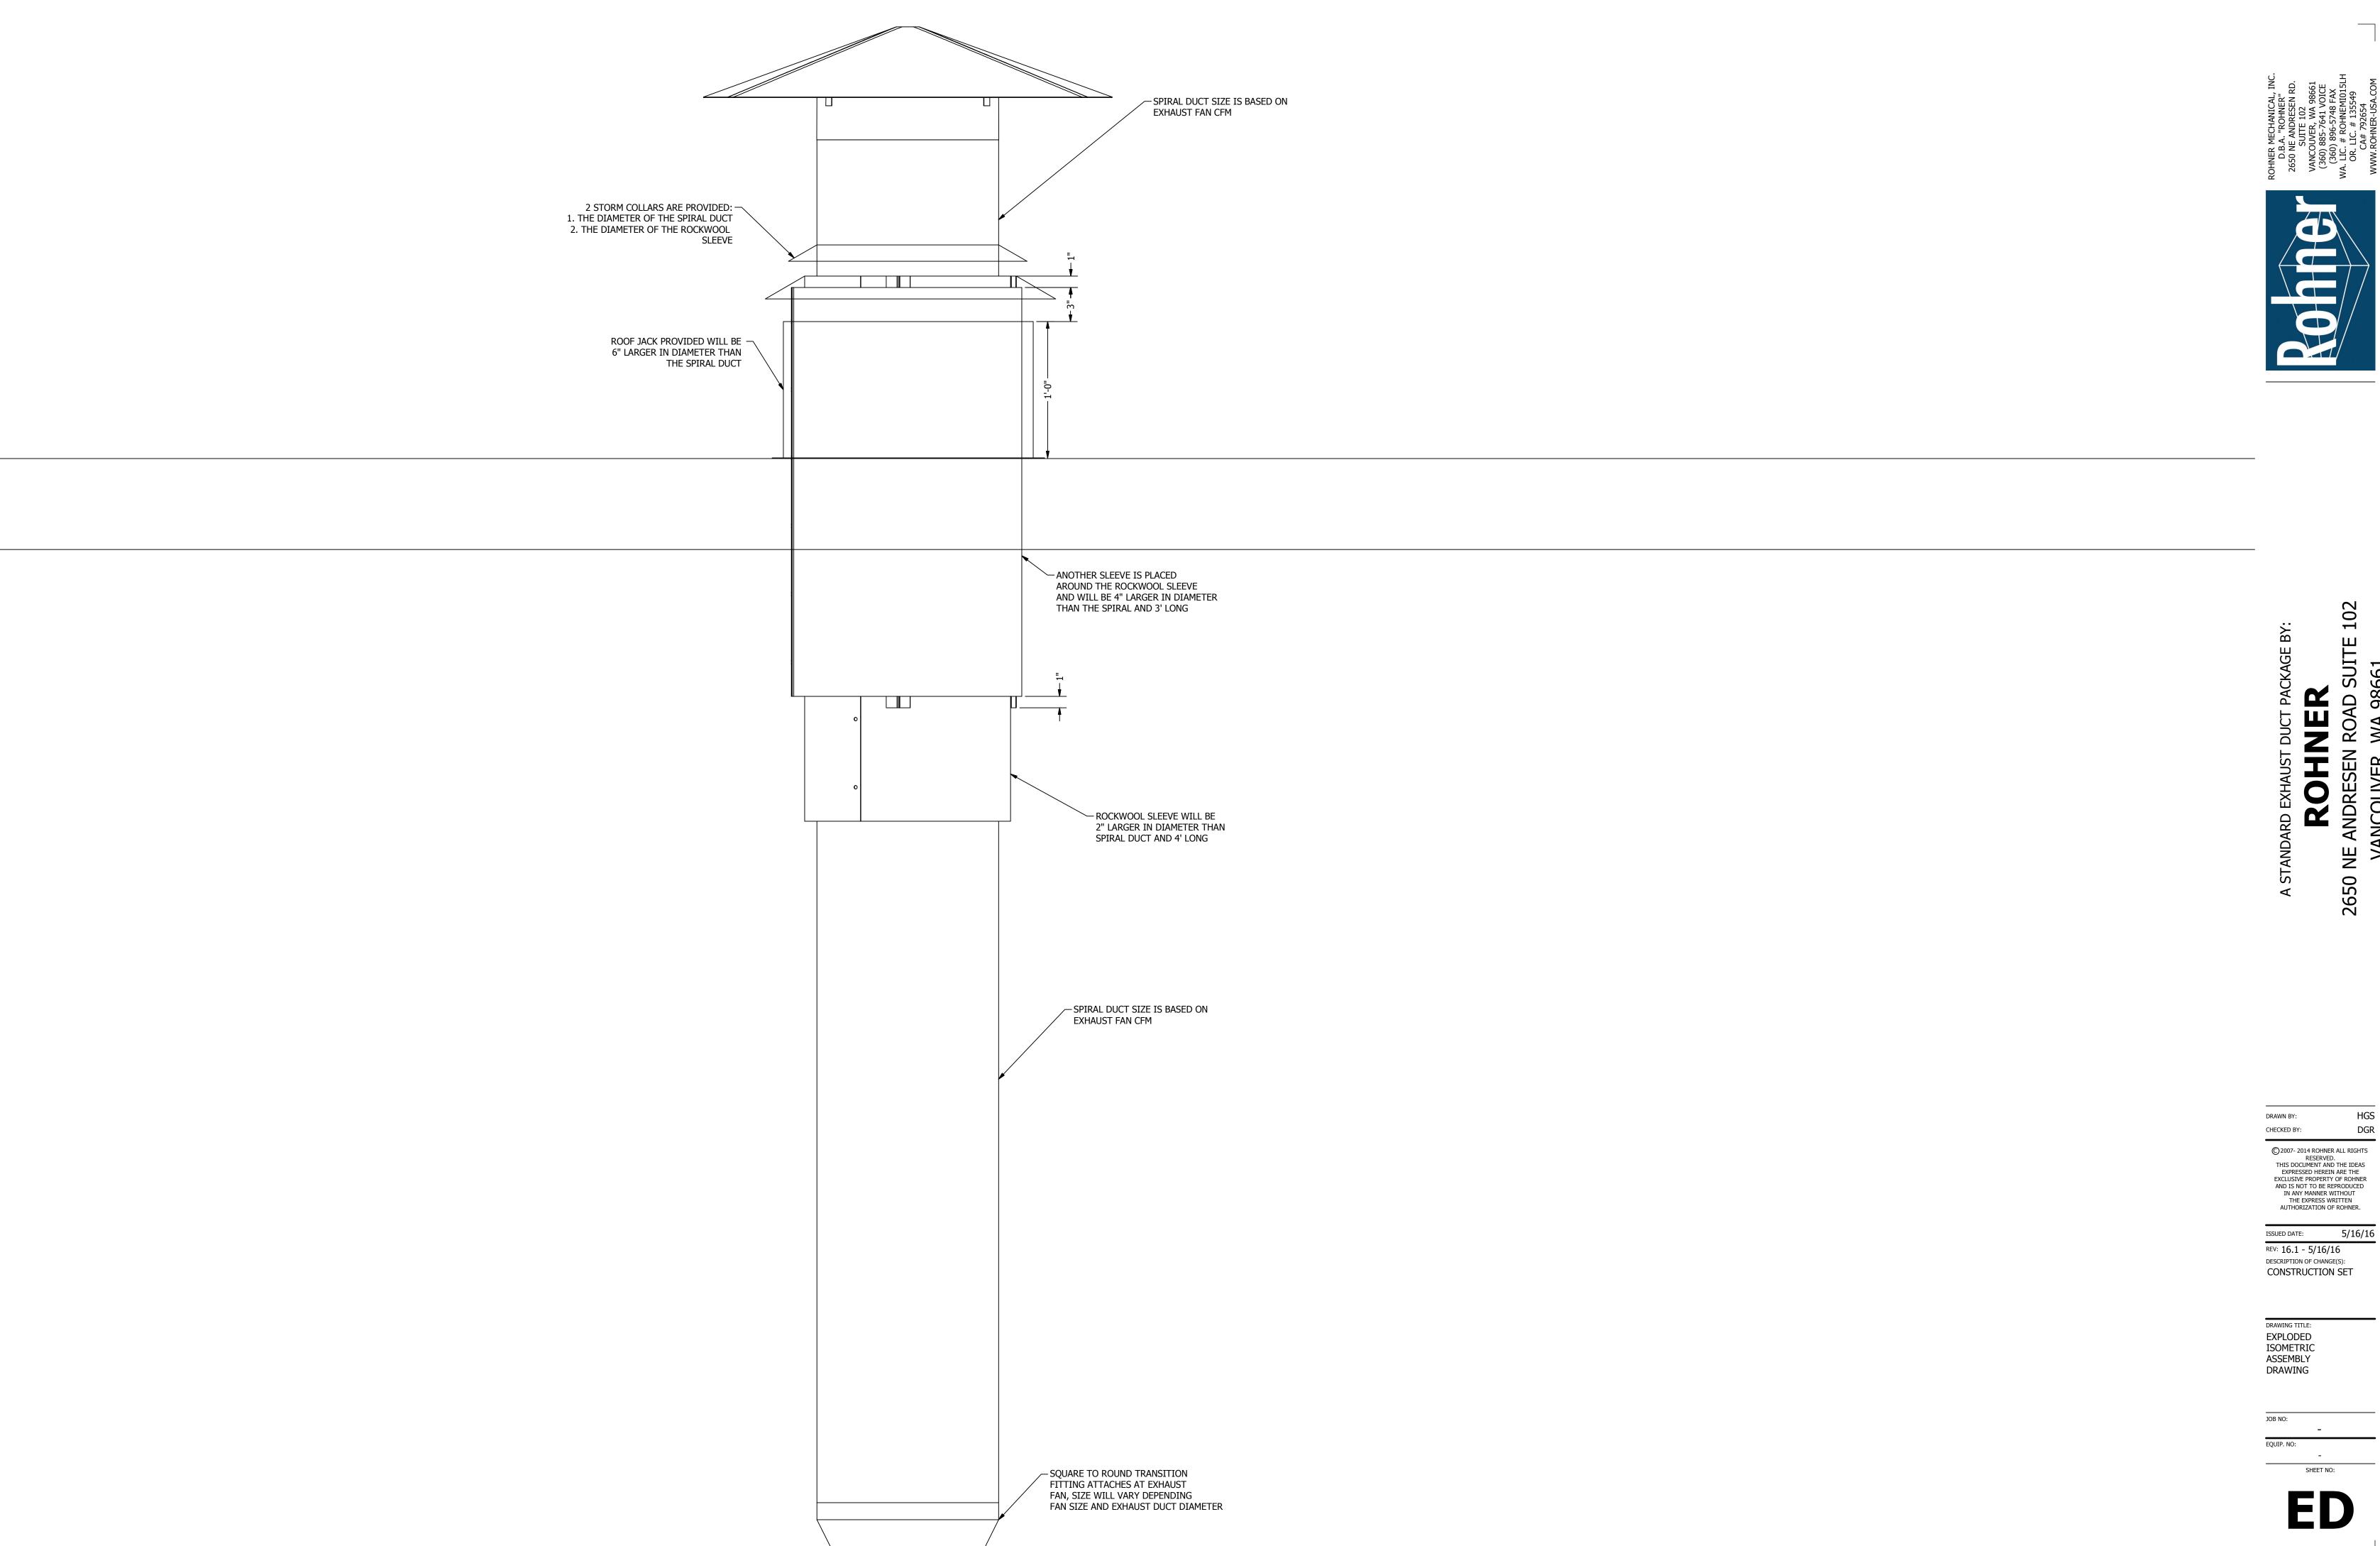
R2016151

EQUIP. NO:
POHT-WP-4.5-21.5-50-01
SHEET NO:

4.10



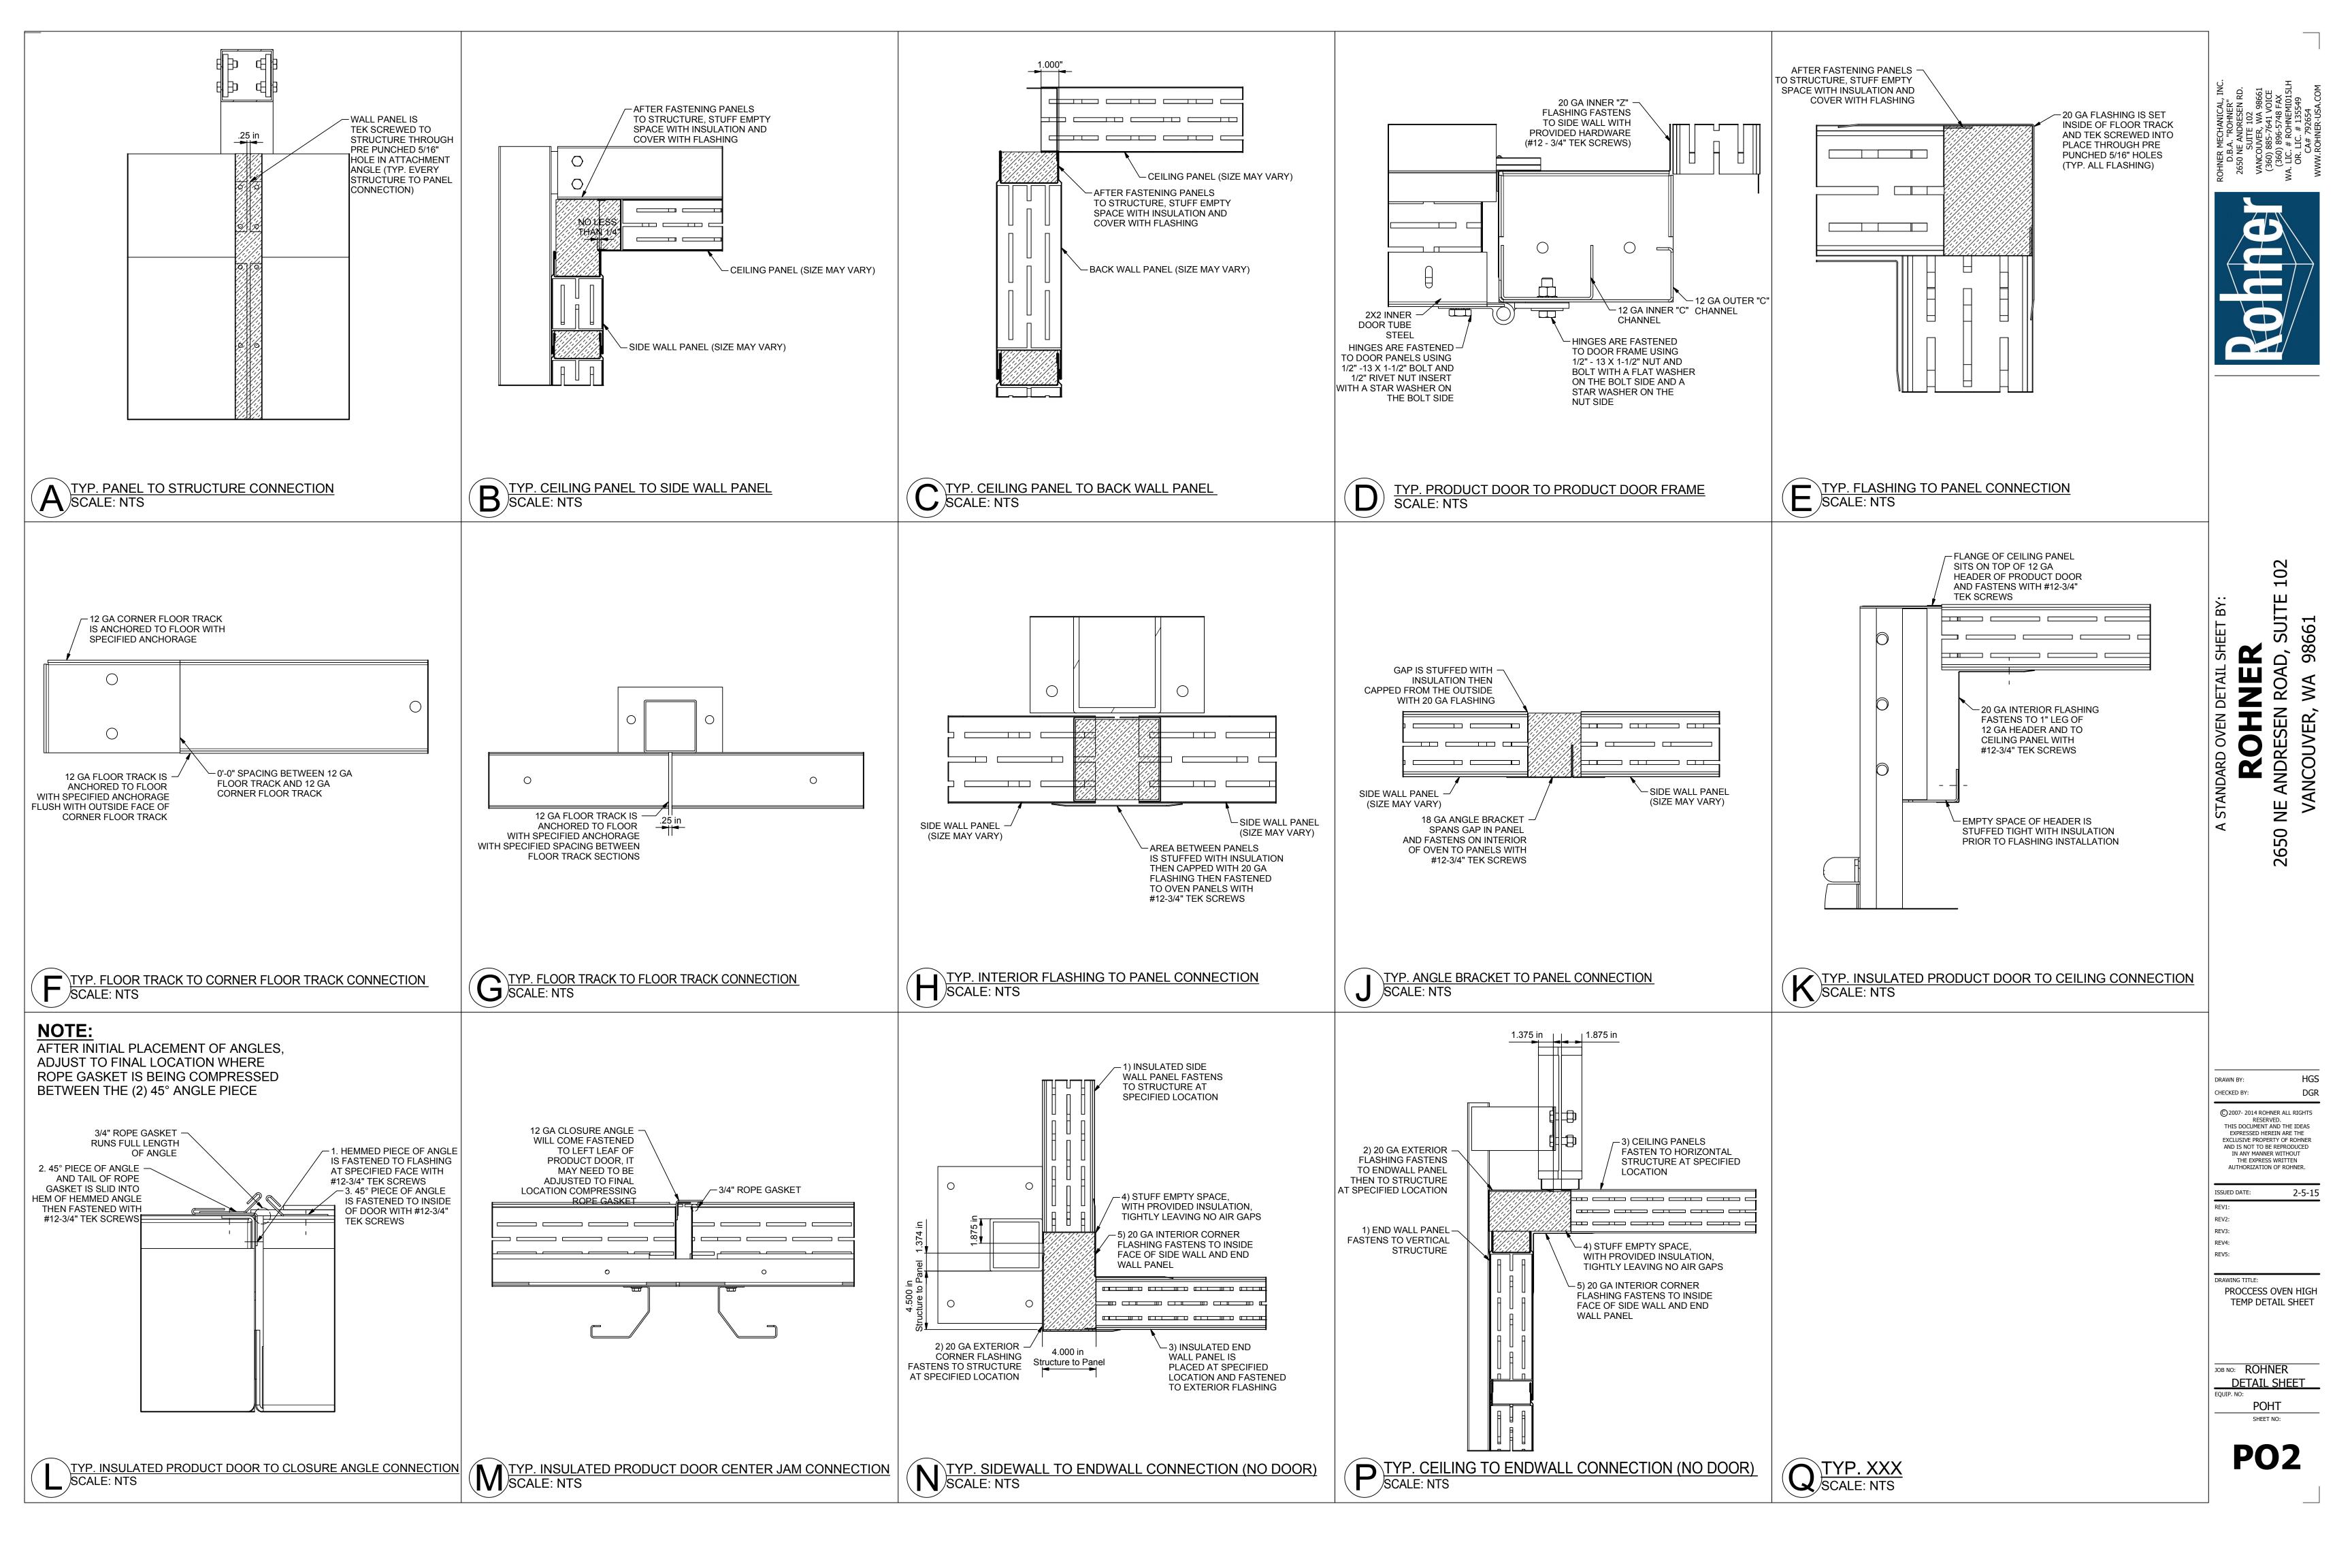

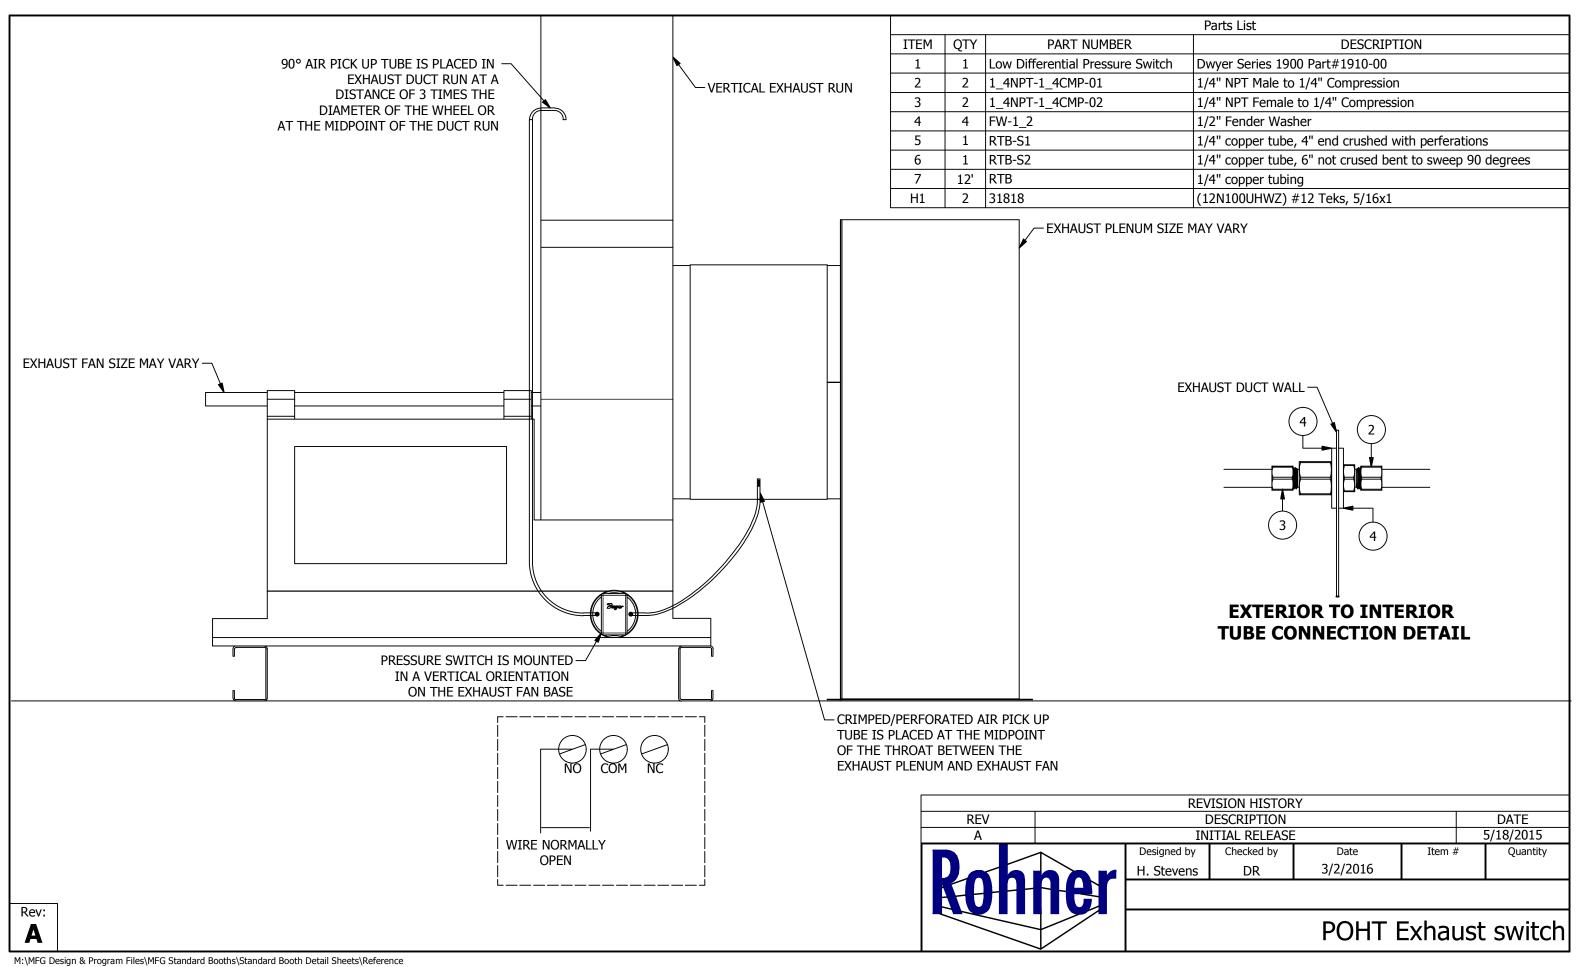




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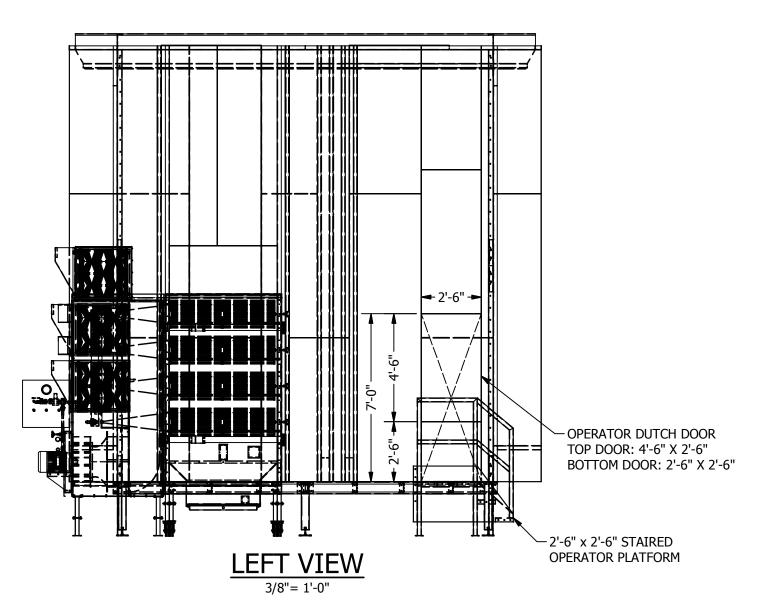
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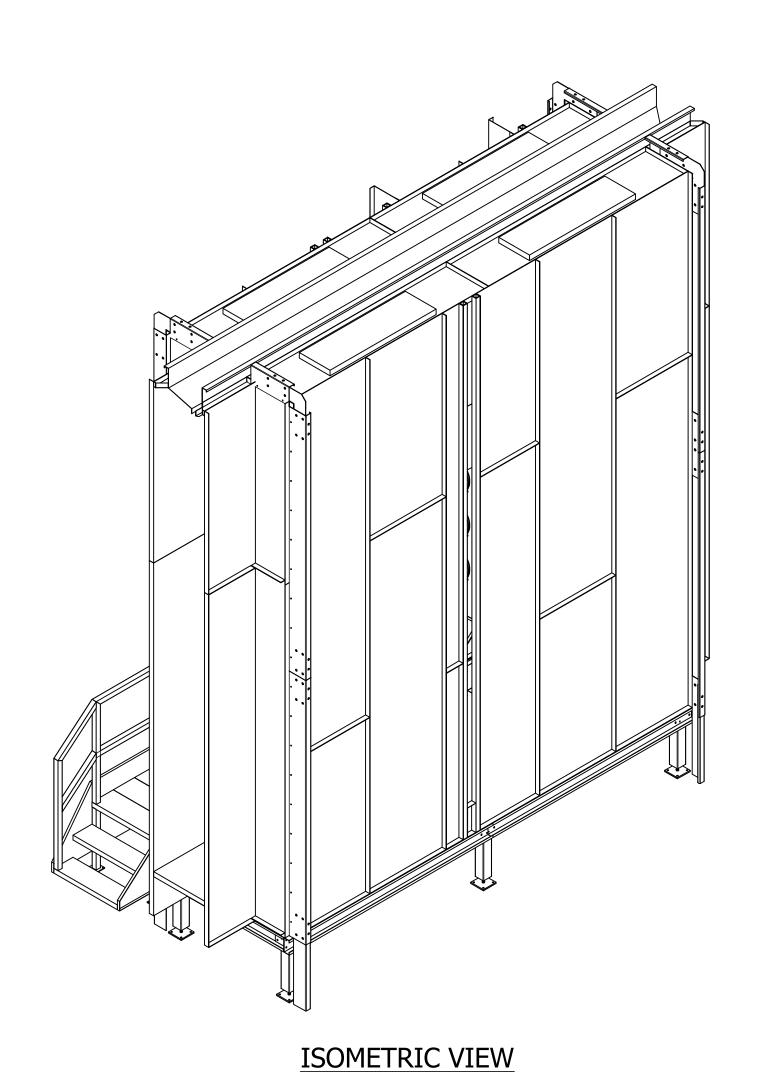
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REV: 16.1 - 5/16/16 DESCRIPTION OF CHANGE(S):
CONSTRUCTION SET


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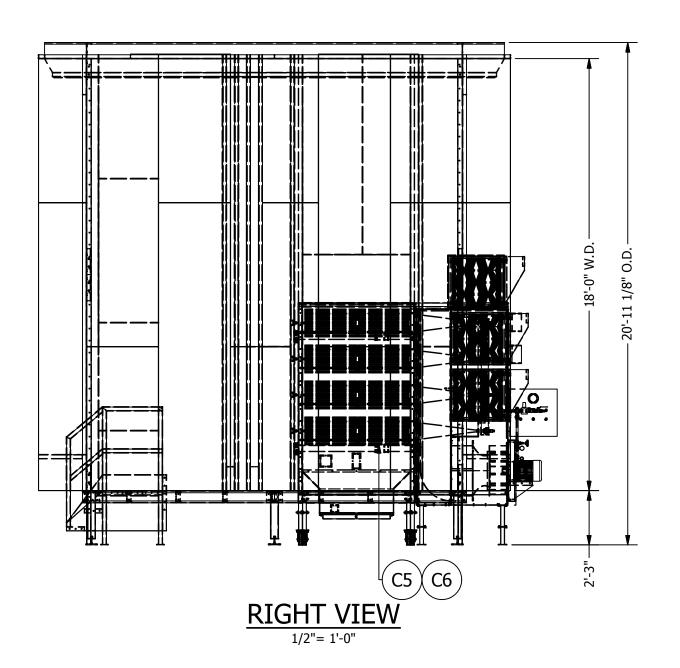



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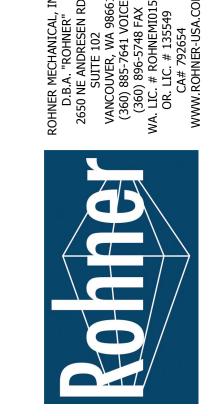


PLAN VIEW
(SHOWN AT LARGER SCALE FOR CLARITY)

3/8"= 1'-0"

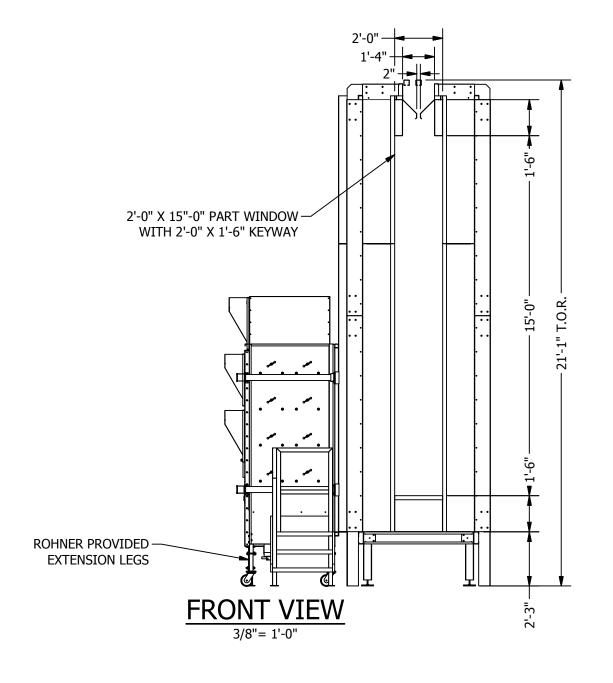

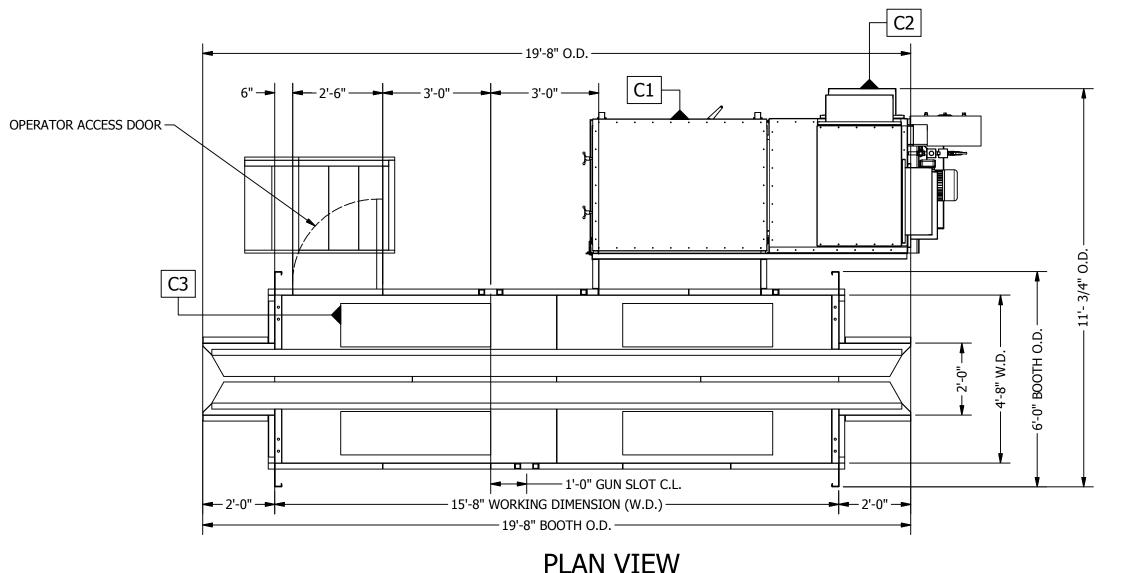

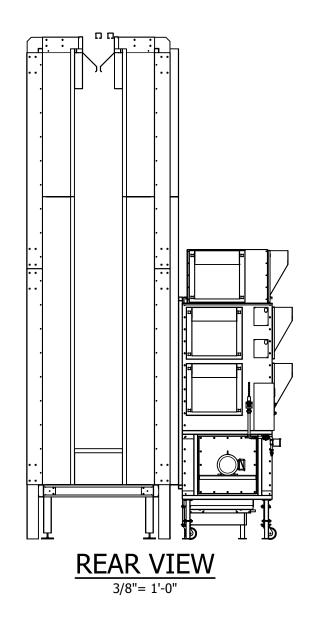

APPROVED FOR CONSTRUCTION

VELOCITY THROUGH OPENING = 158 fpm

100			Powder Booth with Conveyor	or Slot, Elevated Platform & 2'-6" x 7'-0" operator openings. Supply air is portals & operator openings. Exhaust air is evacuated through RM-12000
			reclaim cartridg	e collector module mounted in booth side wall.
			¥7	воотн
Tag	Qty	Pck.	Part	Description
B1	1		PBCEF-RM12000-5-18-16-1.1	PBCEF-RM12000-5-18-16 - Raised Platform - 1.1
B2	1		PBCEF-RM12000-5-18-16-1.2	PBCEF-RW12000-5-18-16 - Catrin Side Walls - 1.2
	1		PBCEE-RM12000-5-18-16-1.3	PBCEF-RM12000-5-18-16 - Cabin Ceiling - 1.3
	_			PBCEF-RM12000-5-18-16 - Caltin End Walls - 1.4
B4	1			
B5	1		RM-12000	RM-12000 - Construction Set
				EQUIPMENT
E1				N/A
				COMPONENTS
a	1		F3M-12000	(1) Quick Color change Fluidized Bed Filter Housing to include: (16) cellulose 14" x
				26" primary cartridge filters rated for 99.97% efficiency. (1) each 150lb fluidized
				powder recovery bed with transfer pump filling (pump by others). Cartridge module is mounted on (4) 6" caster and secured to the booth and blower module with quick
				laiching hardware and includes full face gaskets to ensure a light seal.
C 2	1		Reclaim Module Blower	(1) 24" Class II QEP aluminum backward inclined direct drive blower with 15hp
			Housing	TEFC C-face 460V/3/60 motor rated for 12,000 CFM @ 5" S.P. & (6) 24" x 24"
				redundant safety final filters rated for 95.9% efficiency & (8) 120V/1/60 back pulse
	4		390440-3546	cleaning solenoids pre plumbed and wired. Enclosed Class 1 Div. II UL listed flourescent inside access light fidure, 115V-
C3	•		33240-3340	277V1860bz
C4	1		SBSV-B5N1	Standard 3/4" solenoid valve, shipped loose, 120v 1Ø
	8		CT8C2P13OCB26M	#LP351S66C2391 - Cartridge filter 80/20 Spray-to-Waste (80% cellulose / 20%
				polyester) - openiclosed with bolt hole.350-2" pleats, 254 sq.it. of surface area
C6	8		CT8C2P13OO26M	#LP351D66C2391 - Cartridge filter 80/20 Spray-to-Waste(80% cellulose/20%
				polyester)open/open. 350-2" pleats and 254 sq.tt. of surface area.
				ASSEMBLIES
_	N/A			N/A
A2	N/A			N/A
				CONTROLS
001			RM-Nema 12	460V/3/60 Industrial UL listed NEMA 12 control panel, with lighting contactor, rectain
				transfer pump solenoid and hoperfirmer control, Dywer digital back pulse firmer dus collector automatic solenoid control, high firmit shut down and panel mounted
				Magnabelic visual indicator.
				DUCT
D1				N/A
				GENERAL NOTES
18 cs	a galva	arize	d construction, pre-punched to	
			· · · ·	shapes, welded and punched for nut and bolt assembly, powder coaled linish.
			embly materials, fasteners an	

MEETS OR EXCEEDS REQUIREMENTS OF NFPA 33 AND OSHA REGULATIONS

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DESCRIPTION OF CHANGE(S):
INITIAL RELEASE
DUTCH DOOR DIMS ADDED

DRAWING TITLE:
FLOOR PLANS/
ELEVATIONS/
SECTIONS


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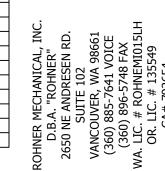
PBCEF-RM12000-5-18-16

SHEET NO:

5



	PARTS LIST					
ITEM	QTY	PART NUMBER DESCRIPTION				
5-A1	4	10RIBA-4.5-4.5-04	10 ga Rib Anchor Angle			
5-A2	4	10RIBAA-2.5-8-04	10 ga Rib Anchor Angle			
5-A3	4	10RIBJ-2.5-8-90d-N	10 ga Rib Joint 90 degree corner			
5-A4	4	I-10RIBJ-2.5-8-180d-01	10 ga Rib Joint straight IP			
5-A5	2	I-10RIBJ-2.5-8-180d-S	10 ga Rib Joint straight IP			
5-A6	2	I-10RIBJ-2.5-8-180d-S-02	10 ga Rib Joint straight IP			
5-A7	8	12JC-2.5-8-108-01	12 ga J Channel			
5-A8	2	12JC-2.5-8-18-01	12 ga J Channel			
5-A9	2	12JC-2.5-8-18-02	12 ga J Channel			
H10	159	62C150HCS5Z	Hex Bolt - 5/8-11x1 1/2"			
H11	159	36114	Hex Nut - 5/8-11			

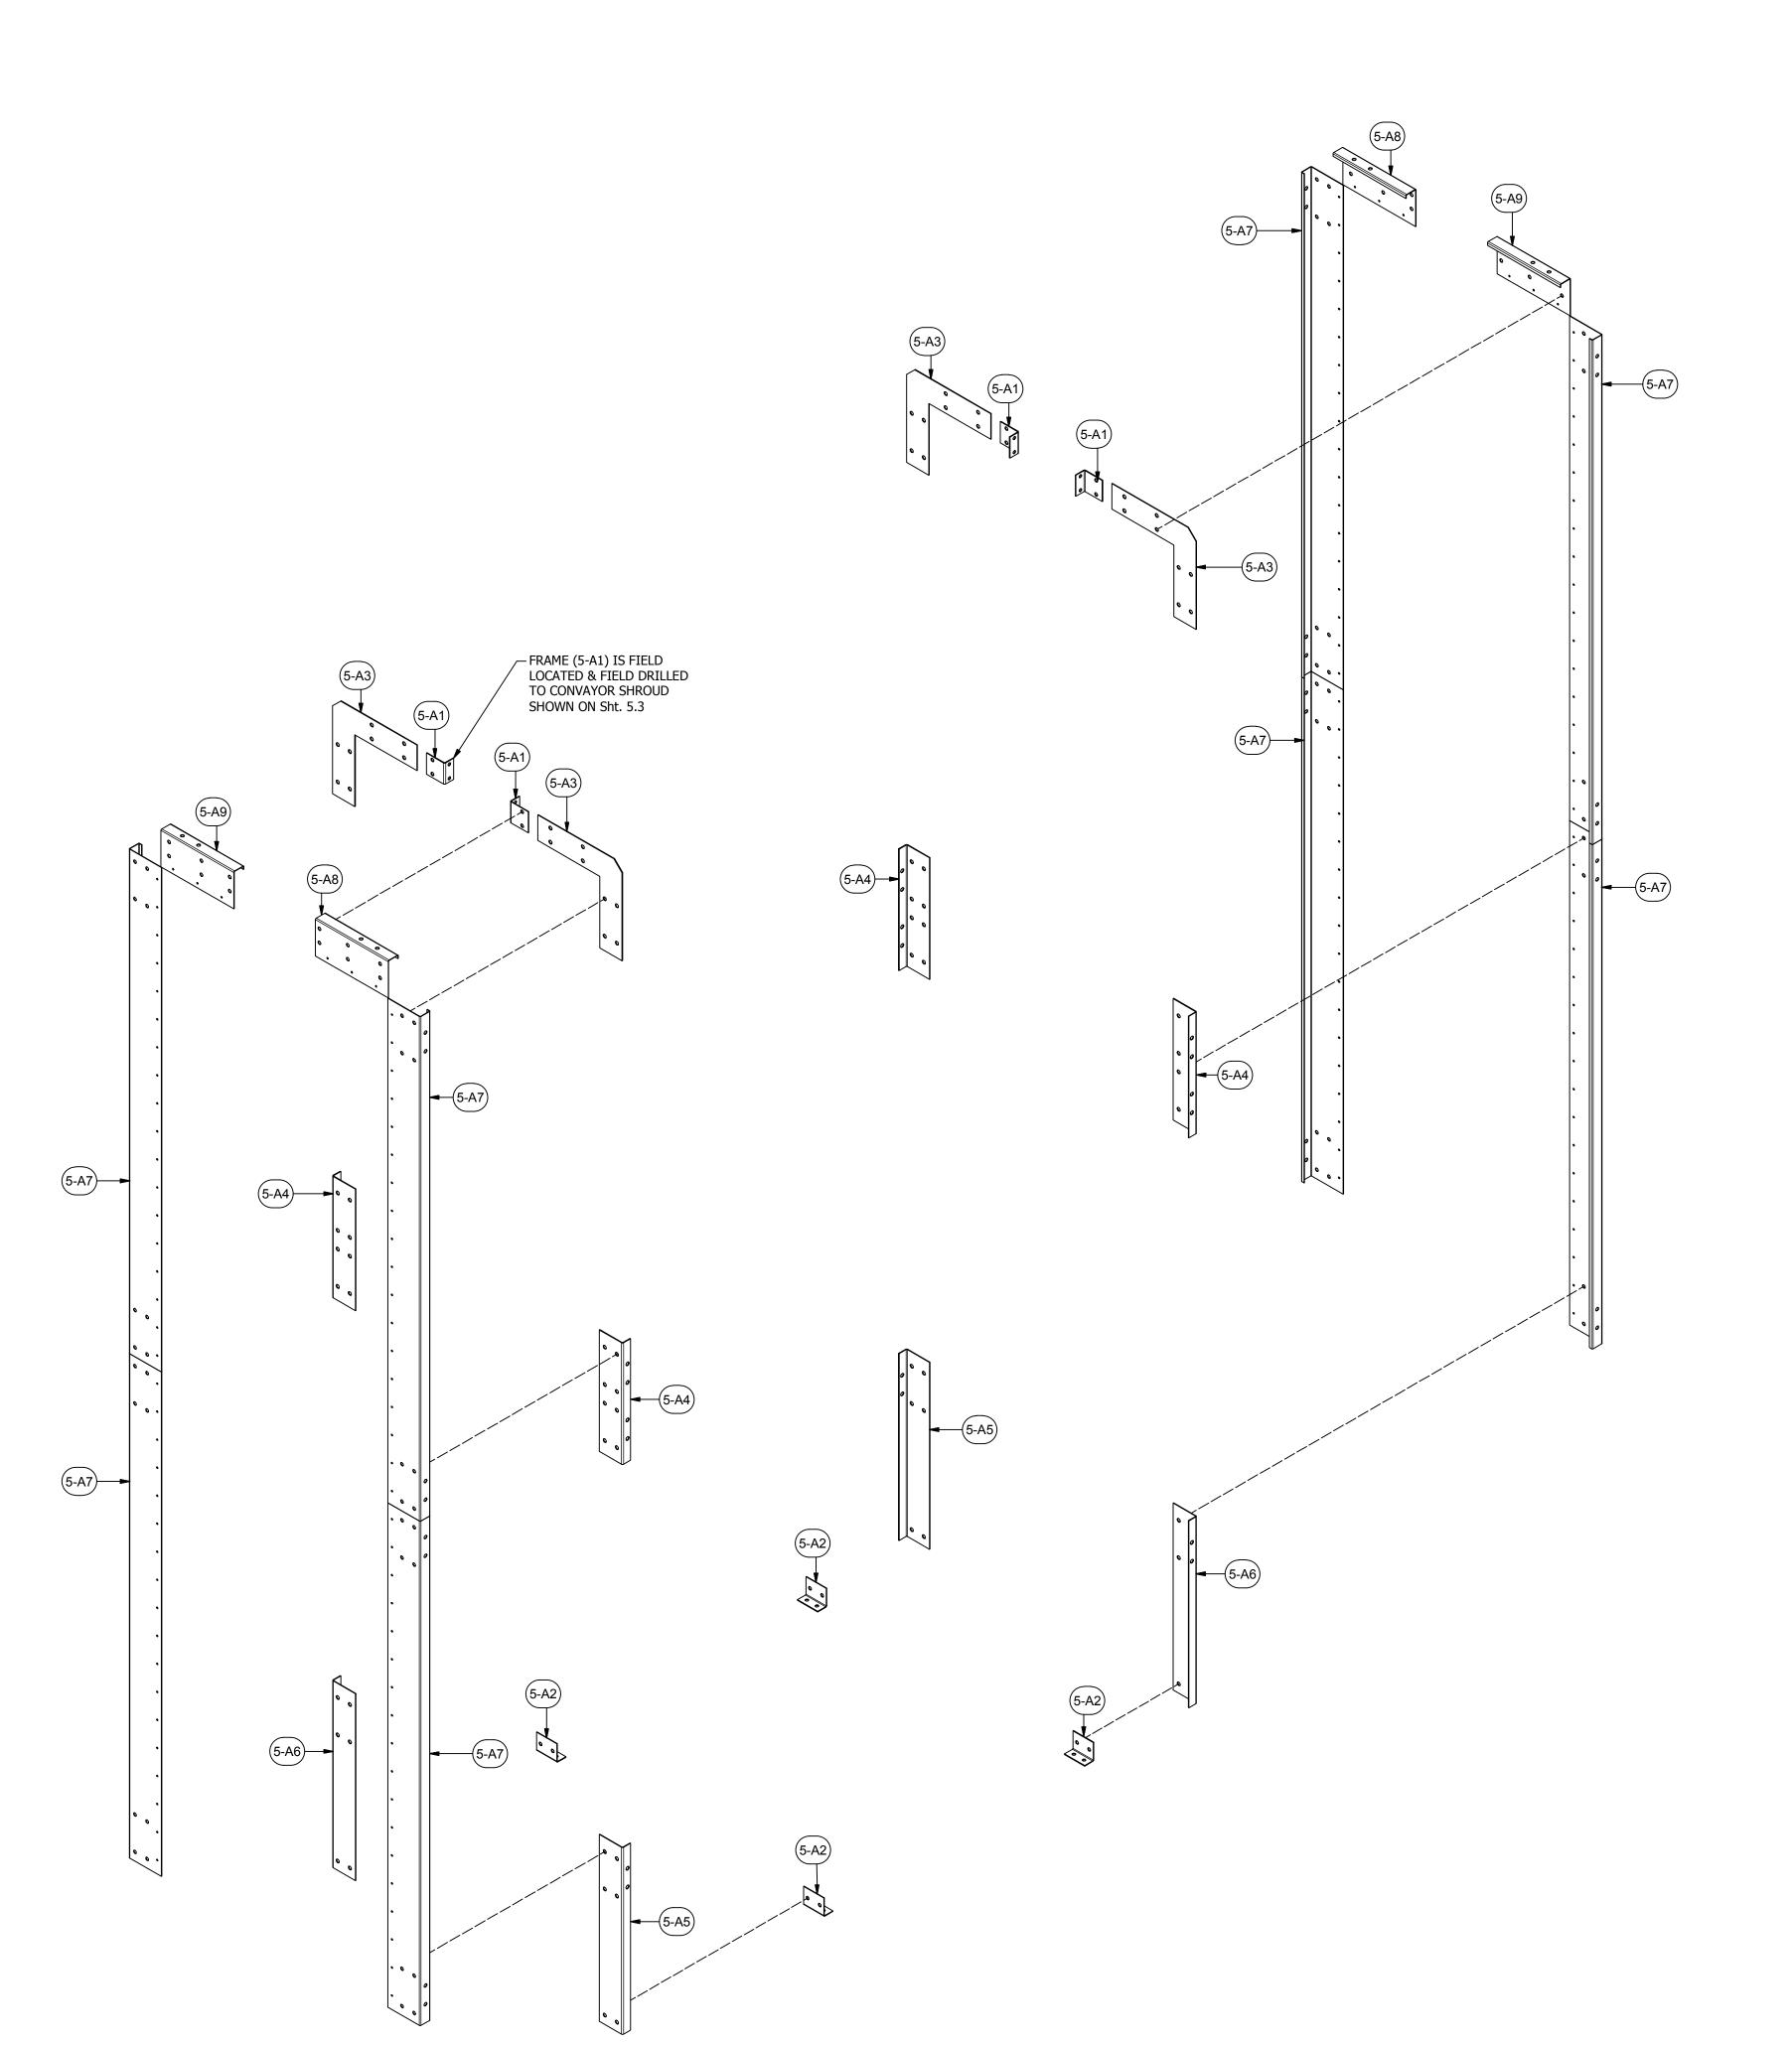



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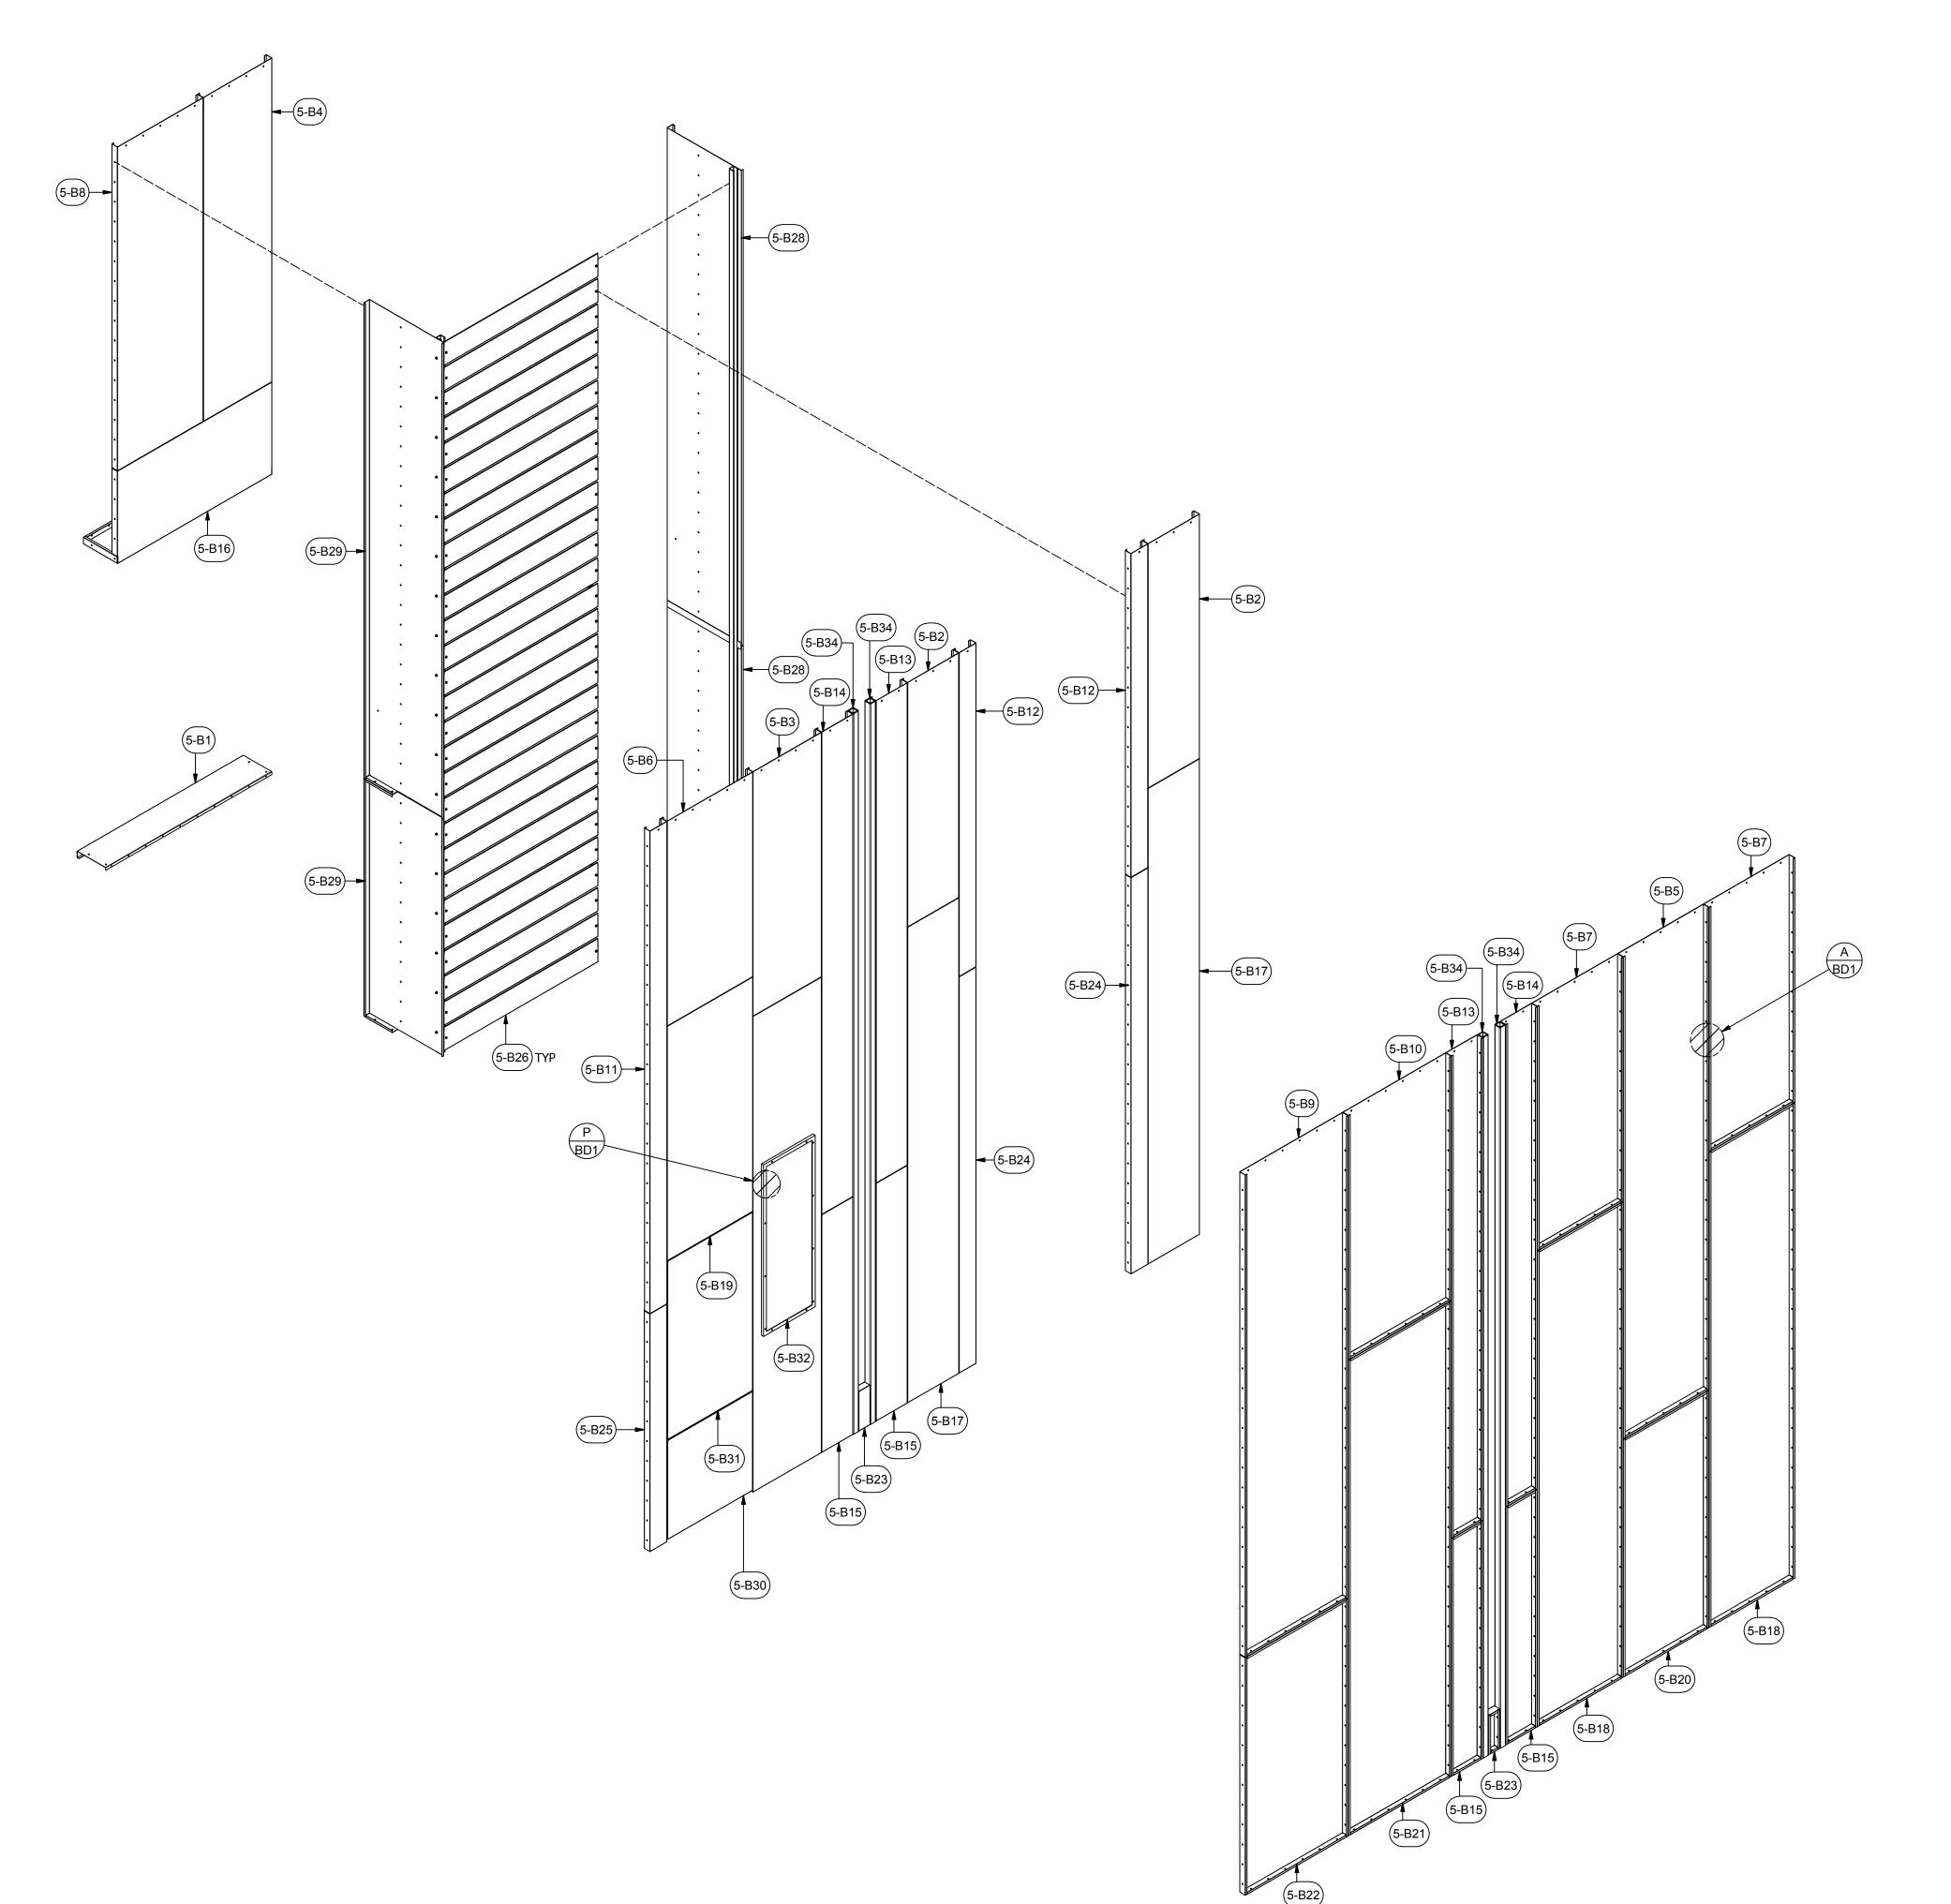
Construction Set


DRAWING TITLE:
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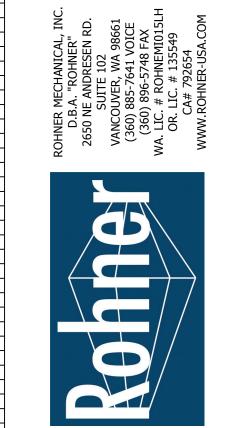
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SHEET NO:

5.1





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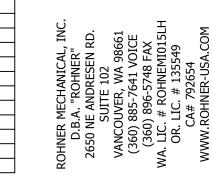
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EQUIP. NO:
PBCEF-RM12000-5-18-16

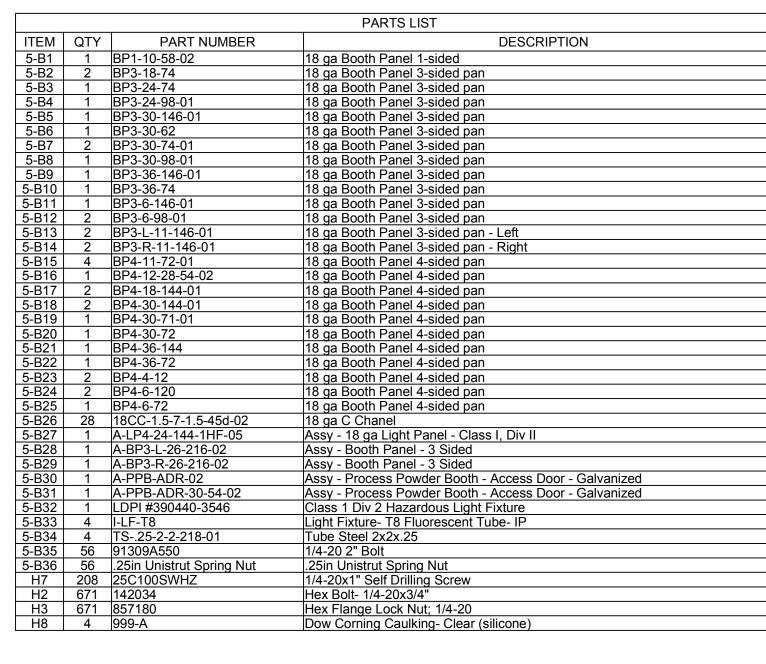SHEET NO:

5.2

	PARTS LIST					
ITEM	QTY	PART NUMBER	DESCRIPTION			
5-C1	2	14SS-PPB-CS-L-15.5-117-02	14 ga SS - Process Powder Booth - Conveyor Shroud - Left			
5-C2	2	14SS-PPB-CS-R-15.5-117-02	14 ga SS - Process Powder Booth - Conveyor Shroud - Left			
5-C3	2	14SS-PPB-A-12-4.75-01	14 ga SS - Process Powder Booth Angle			
5-C4	1	BP4-20-96	18 ga Booth Panel 4-sided pan			
5-C5	3	A-LP4-20-96-1HF-01	Assy - Light Panel - Class i, Div II			
5-C6	3	LDPI #390440-3546	Class 1 Div 2 Hazardous Light Fixture			
5-C7	12	I-LF-T8	Light Fixture- T8 Fluorescent Tube- IP			
H1	36	31818	(12N100UHWZ) #12 Teks, 5/16x1			
H2	142	142034	Hex Bolt- 1/4-20x3/4"			
H3	142	857180	Hex Flange Lock Nut; 1/4-20			
H8	1	999-A	Dow Corning Caulking- Clear (silicone)			








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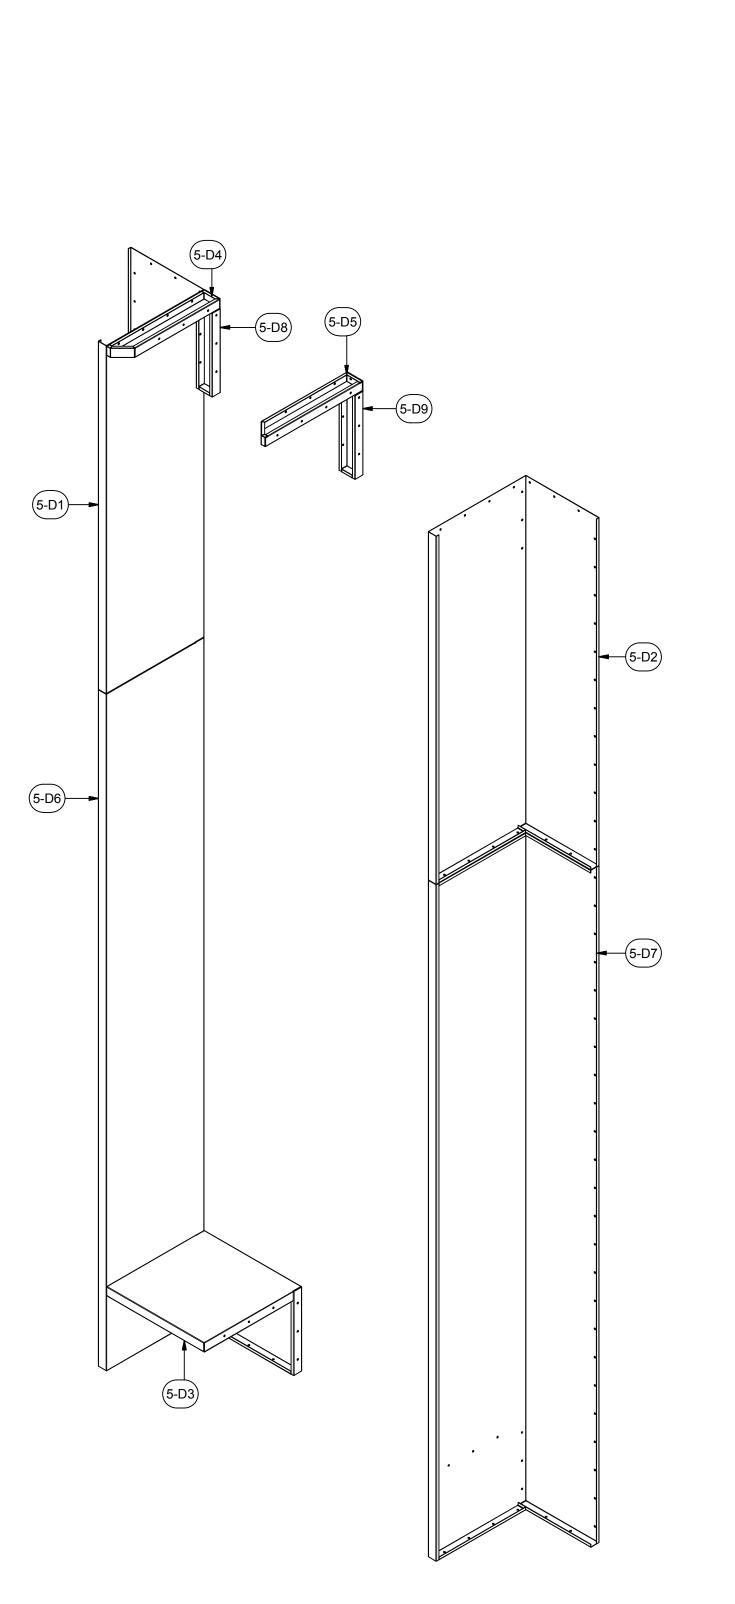
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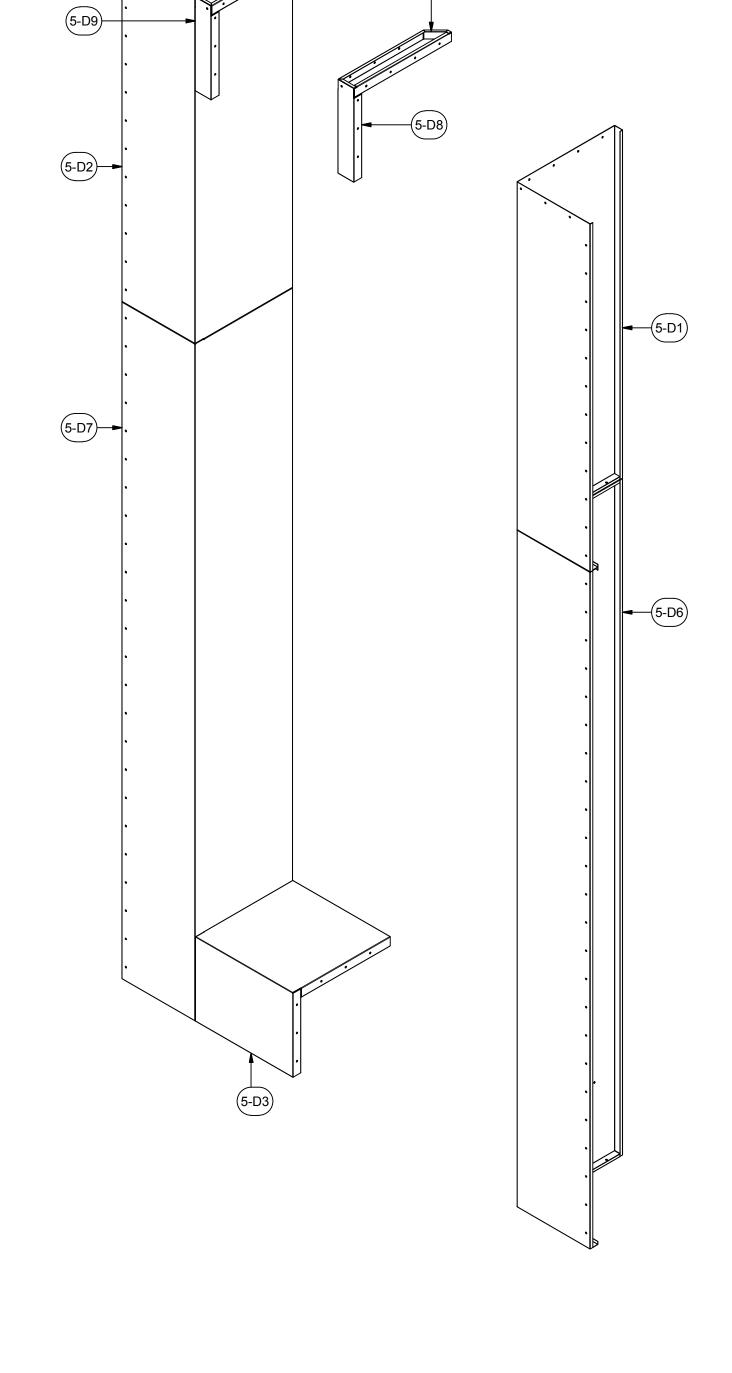
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Construction Set


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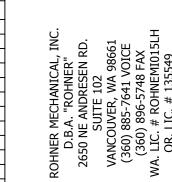
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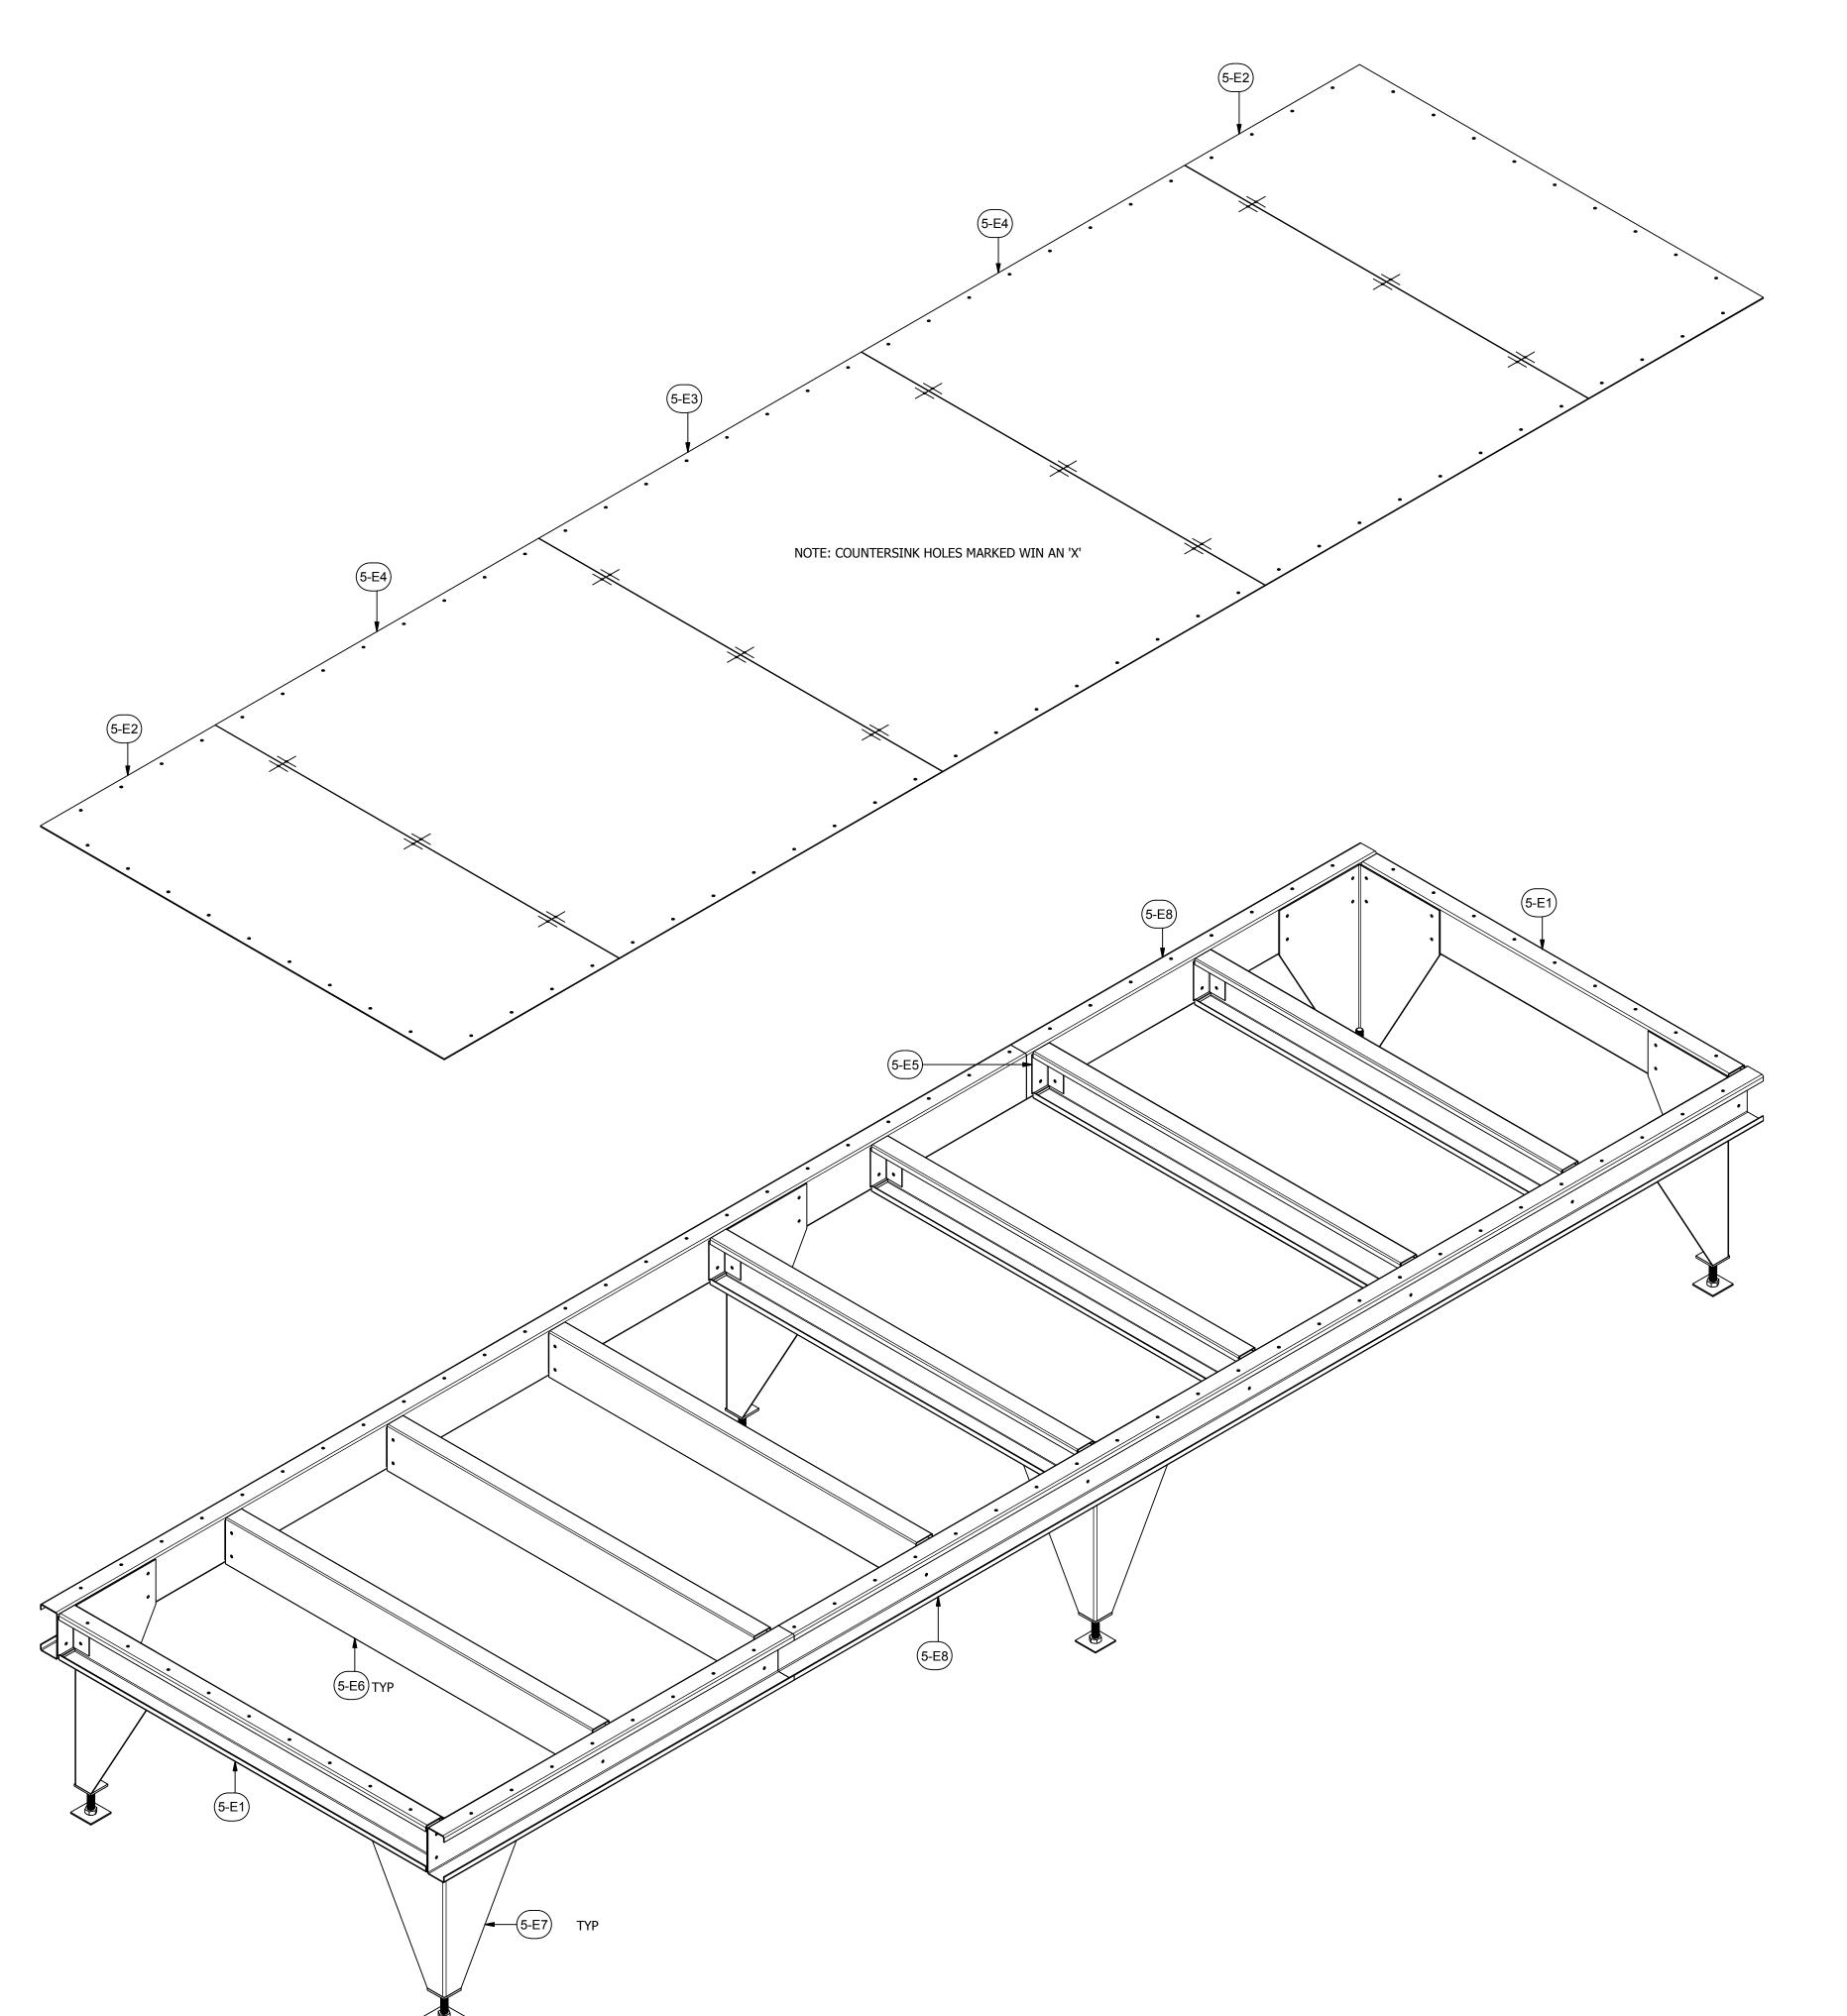
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ASSEMBLY
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EQUIP. NO:
PBCEF-RM12000-5-18-16

SHEET NO:

5.4

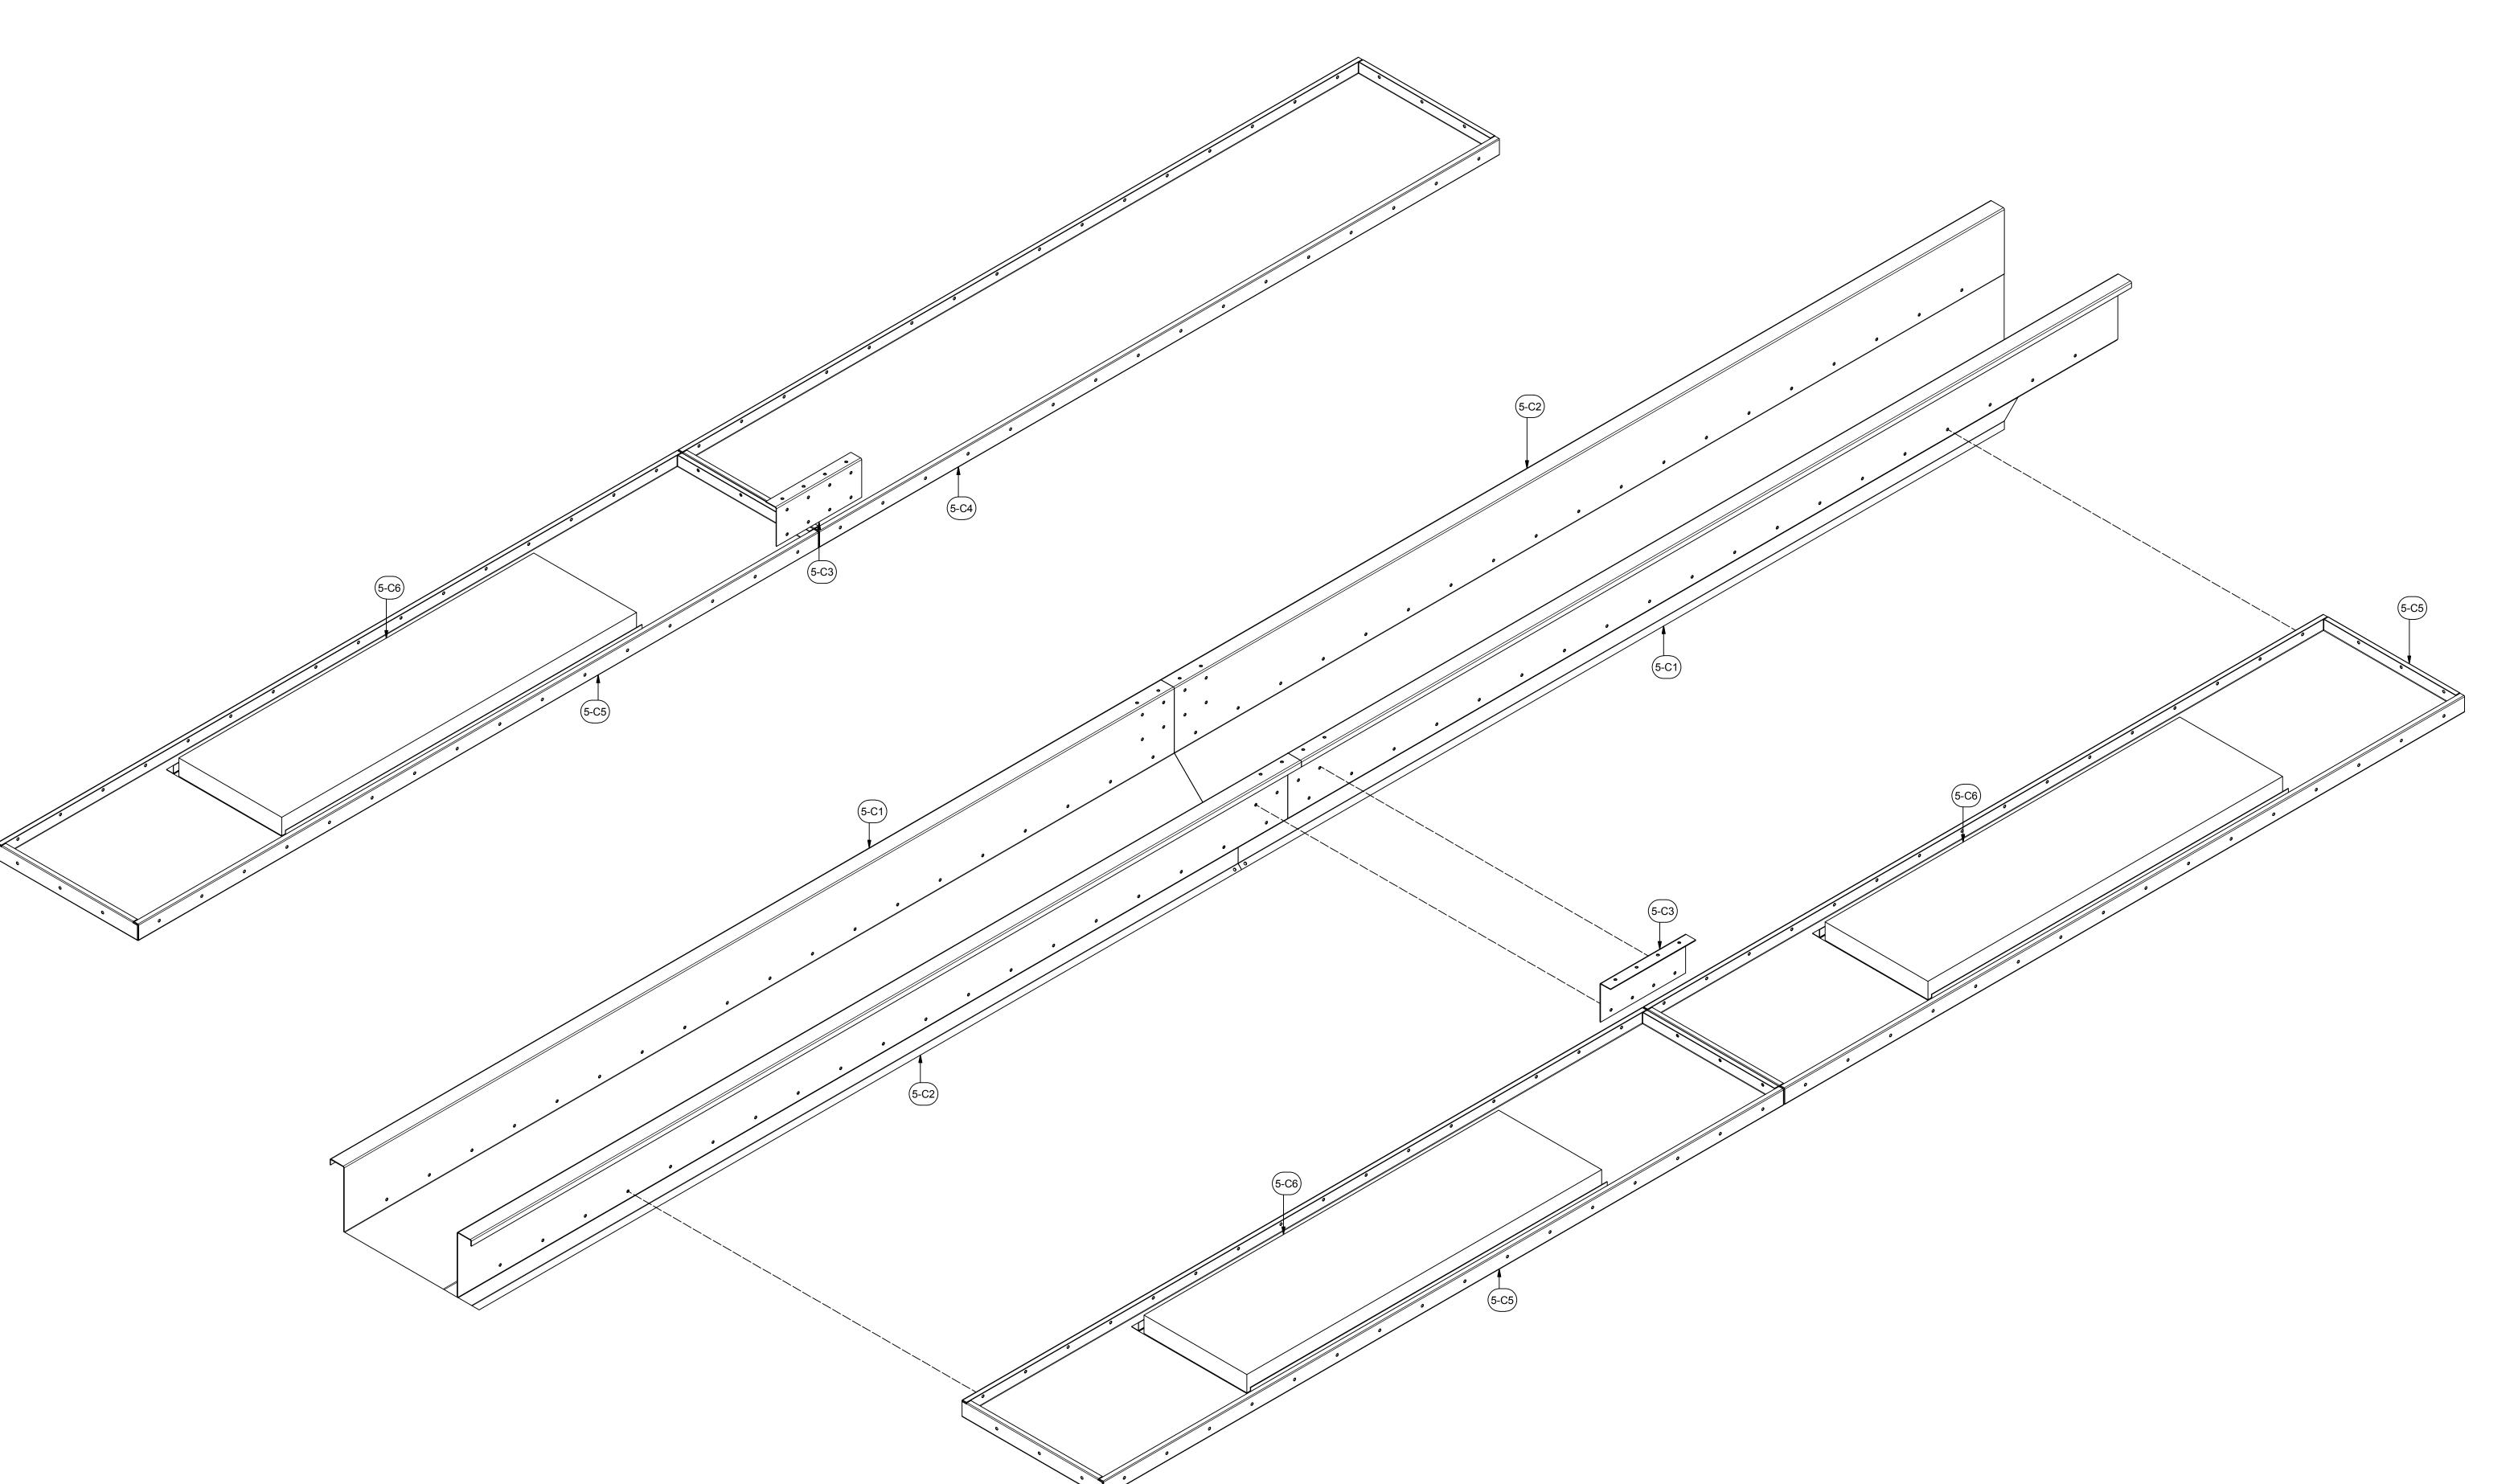

	PARTS LIST				
ITEM	QTY	PART NUMBER	DESCRIPTION		
5-E1	2	12CC-PPB-2.5-6-54.5-02	12 ga C Channel		
5-E2	2	12SS-PPB-PL-25.94-60-02	12 ga SS Plate - Process Powder Booth		
5-E3	1	12SS-PPB-PL-47.88-60-01	12 ga SS Plate - Process Powder Booth		
5-E4	2	12SS-PPB-PL-48-60-02	12 ga SS Plate - Process Powder Booth		
5-E5	18	14A-PPB-2.4-2.4-5-01	14 ga Angle		
5-E6	7	14CC-2.5-6-54.5-03	14 ga C Channel		
5-E7	6	A-ACL-27-00-01	Assy - Adjusable Corner Leg - 27" Nominal		
5-E8	2	A-CC-2.5-6-196-01	Assy - C-Channel Weldment		
H2	120	142034	Hex Bolt- 1/4-20x3/4"		
H3	120	857180	Hex Flange Lock Nut; 1/4-20		
H8	1	999-A	Dow Corning Caulking- Clear (silicone)		

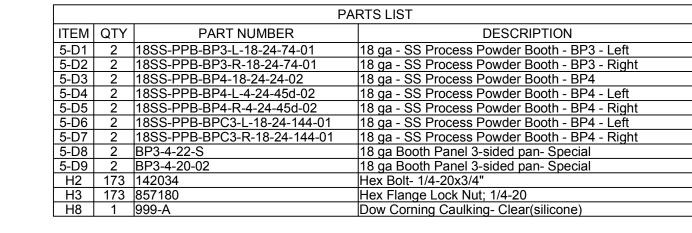OHNER MECHANICAL, INC.
D.B.A. "ROHNER"
2650 NE ANDRESEN RD.
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(360) 885-7641 VOICE
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A. LIC. # ROHNEMI015LH



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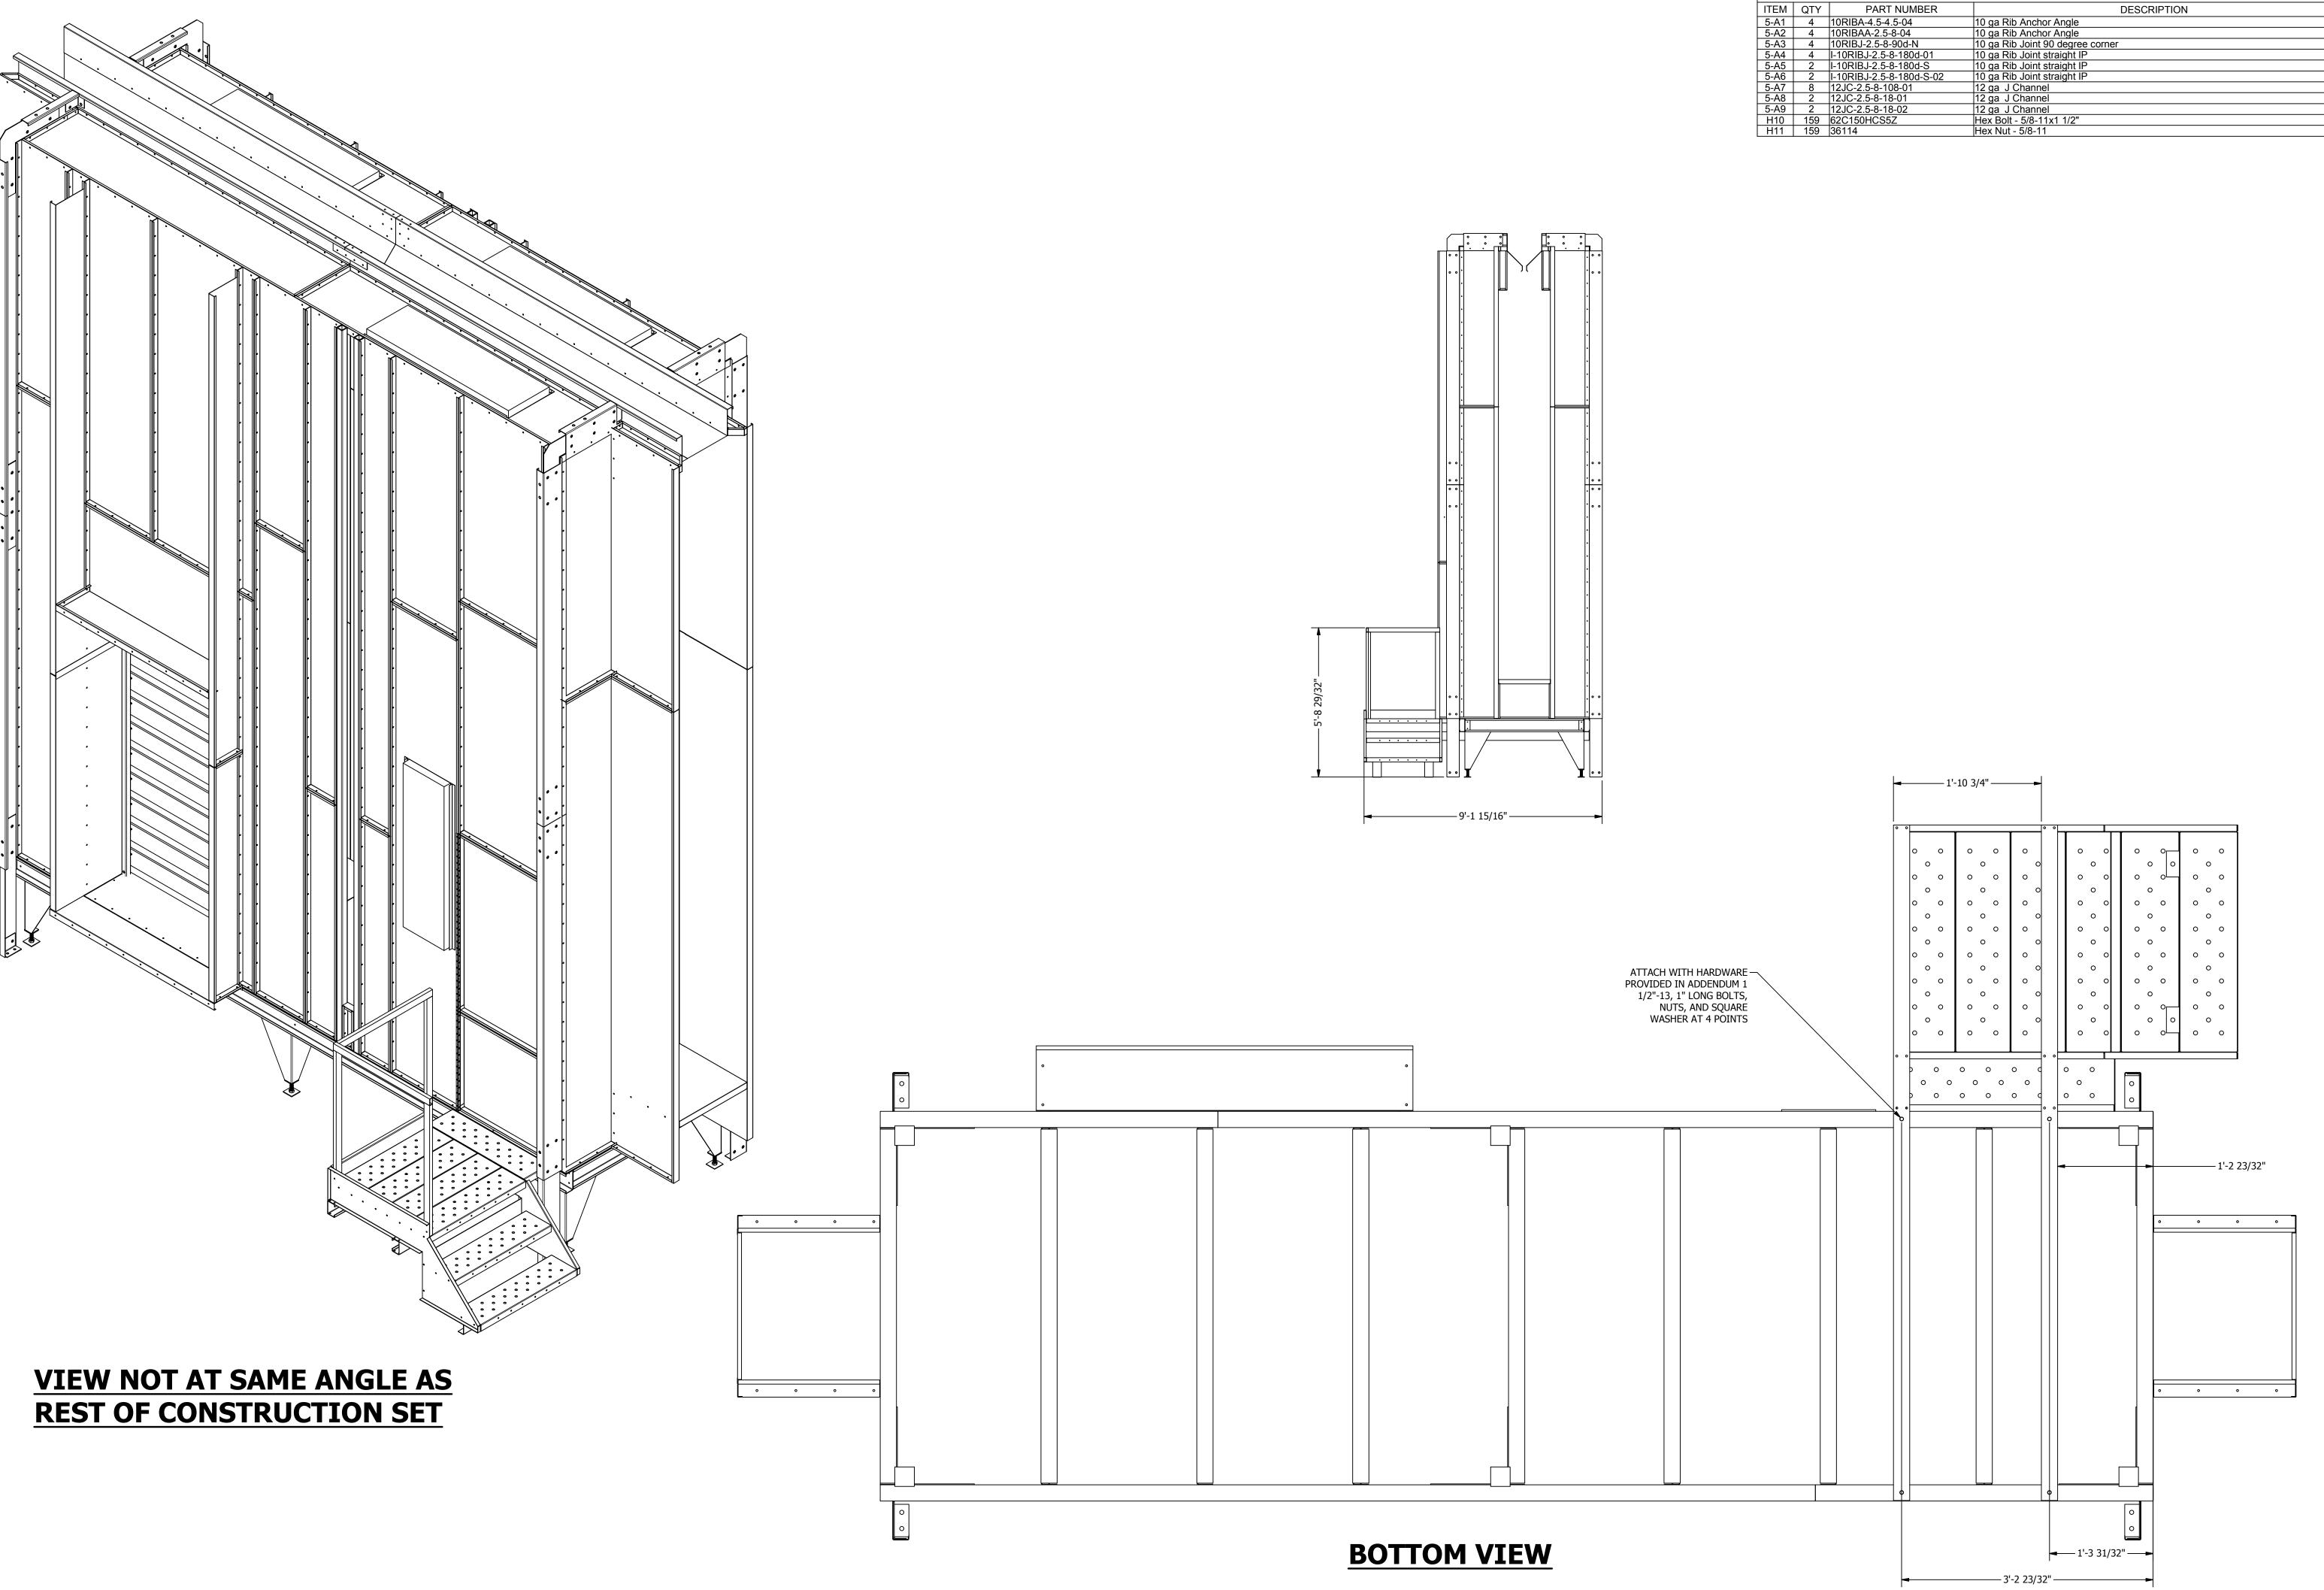
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SHEET NO:

5.5



PARTS LIST





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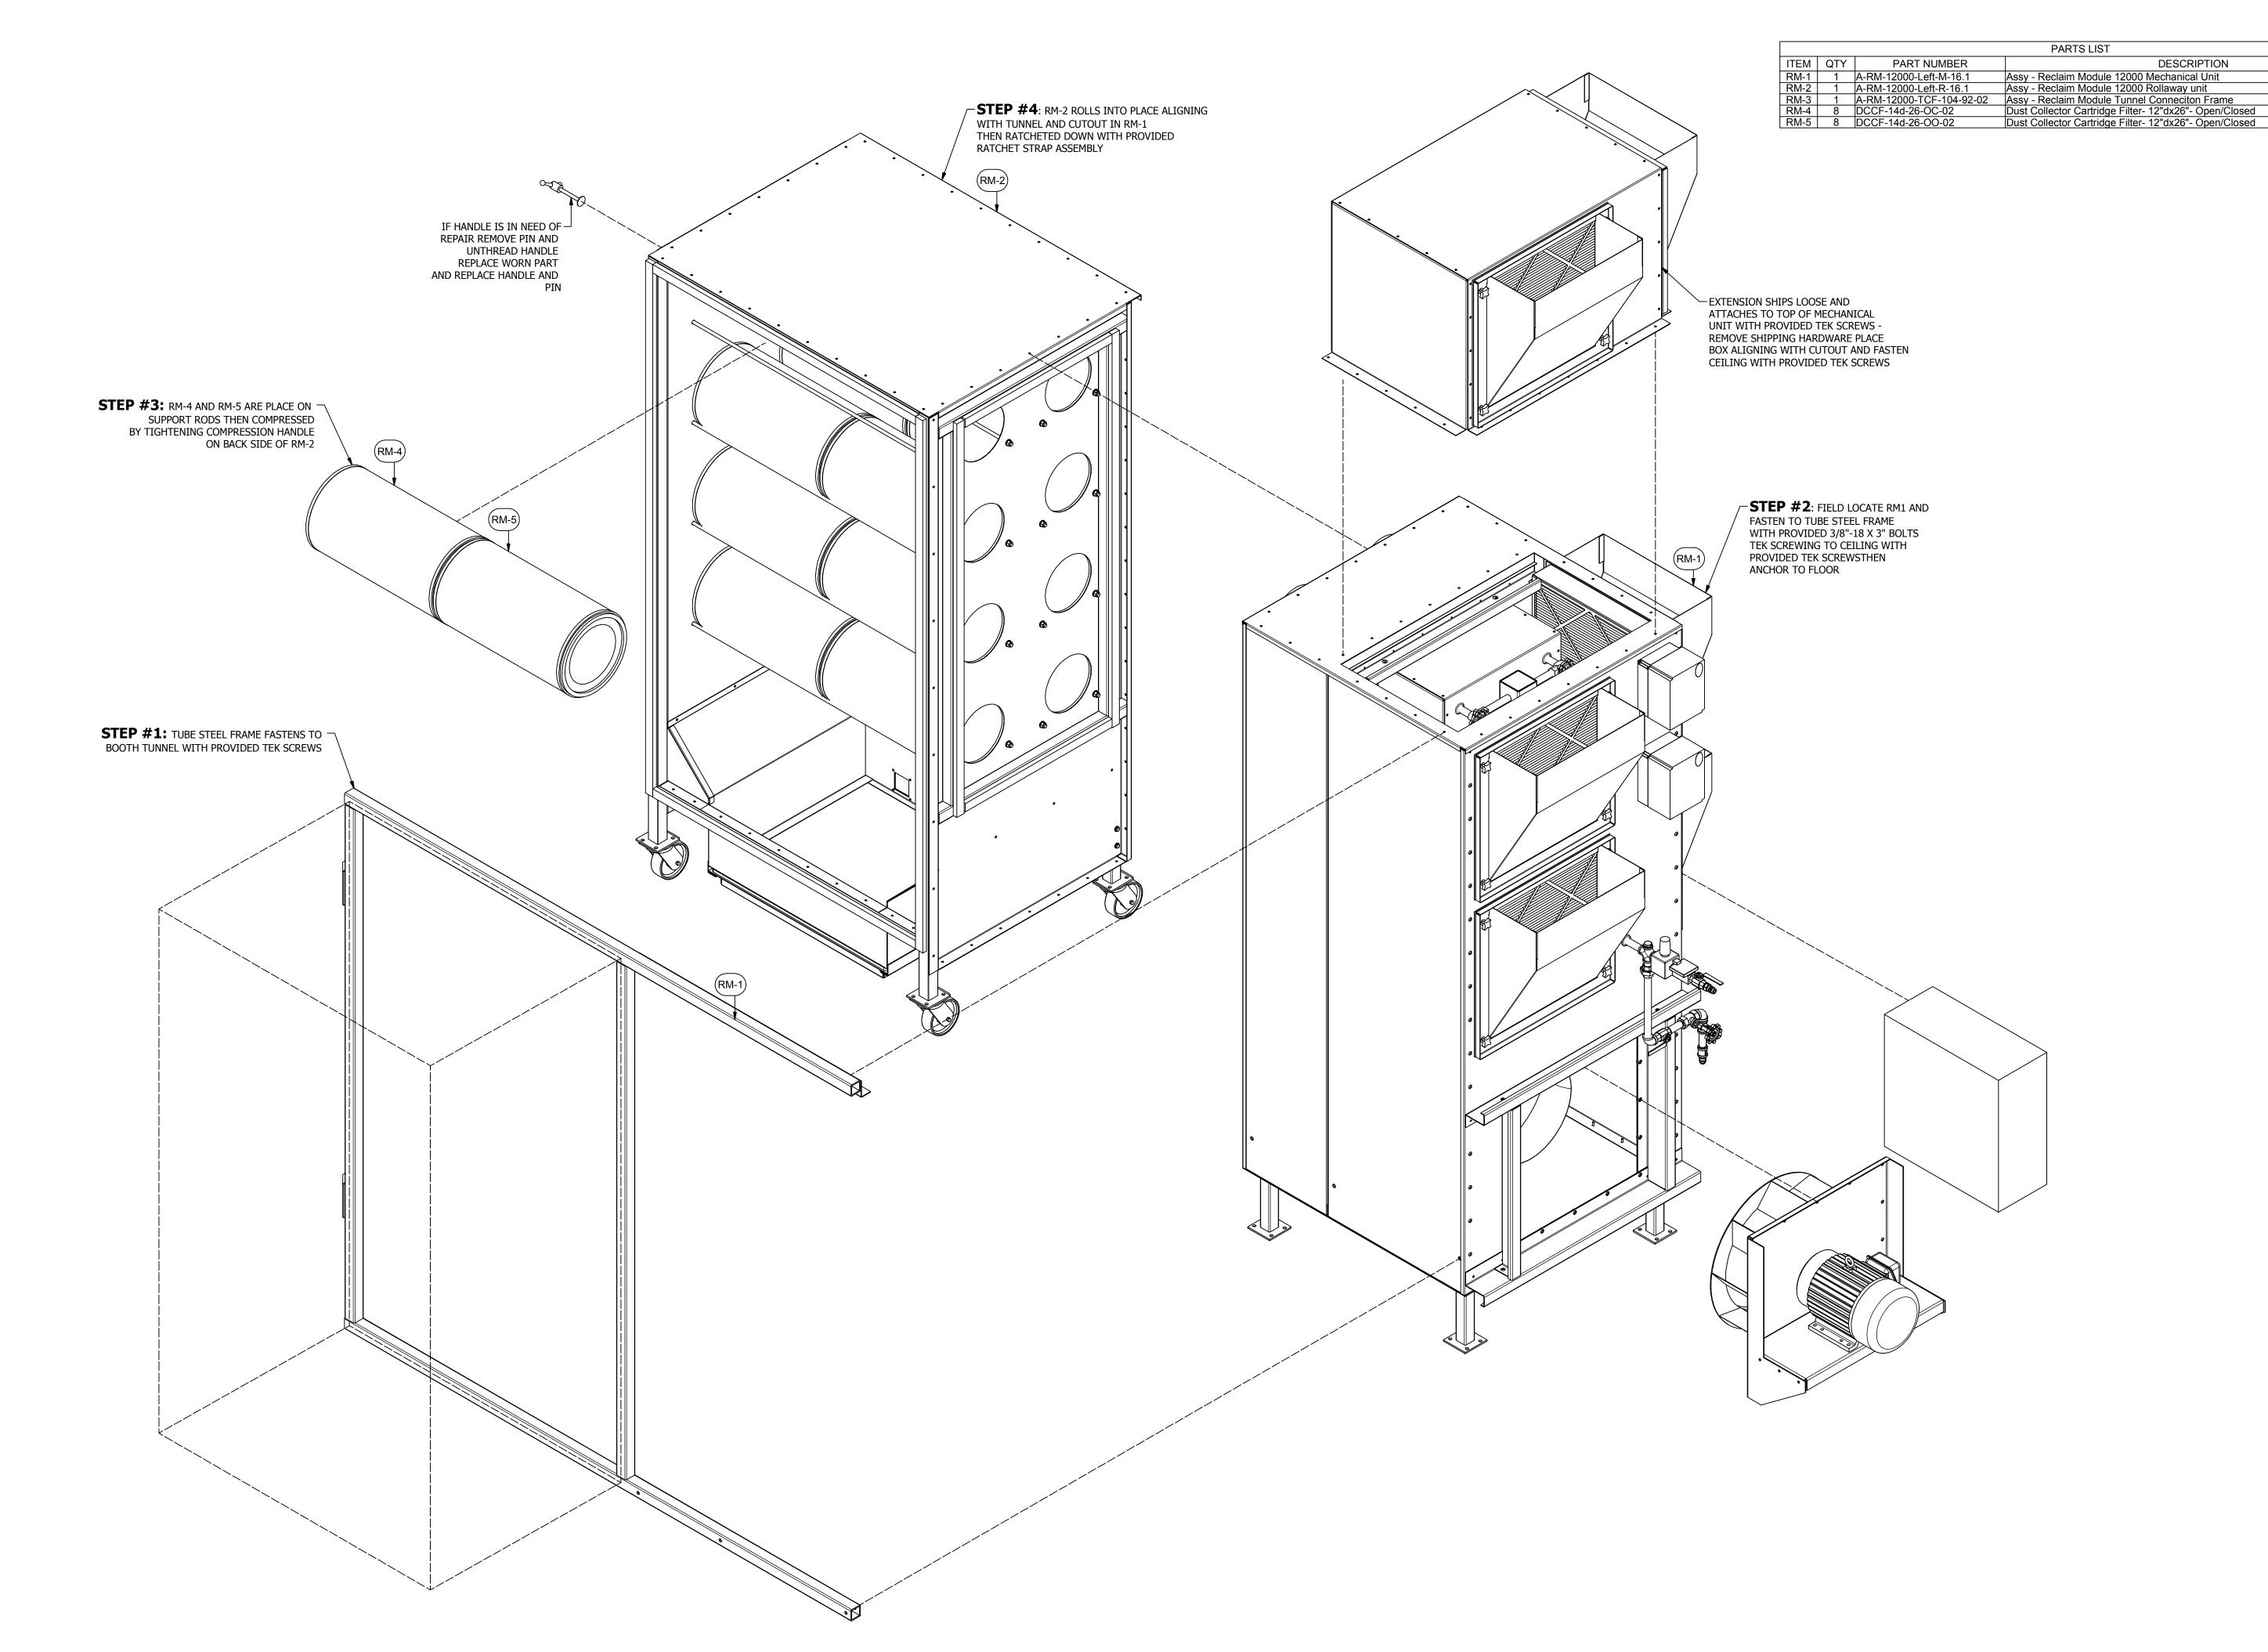


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DRAWING TITLE: FLOOR PLANS/ ELEVATIONS/ SECTIONS



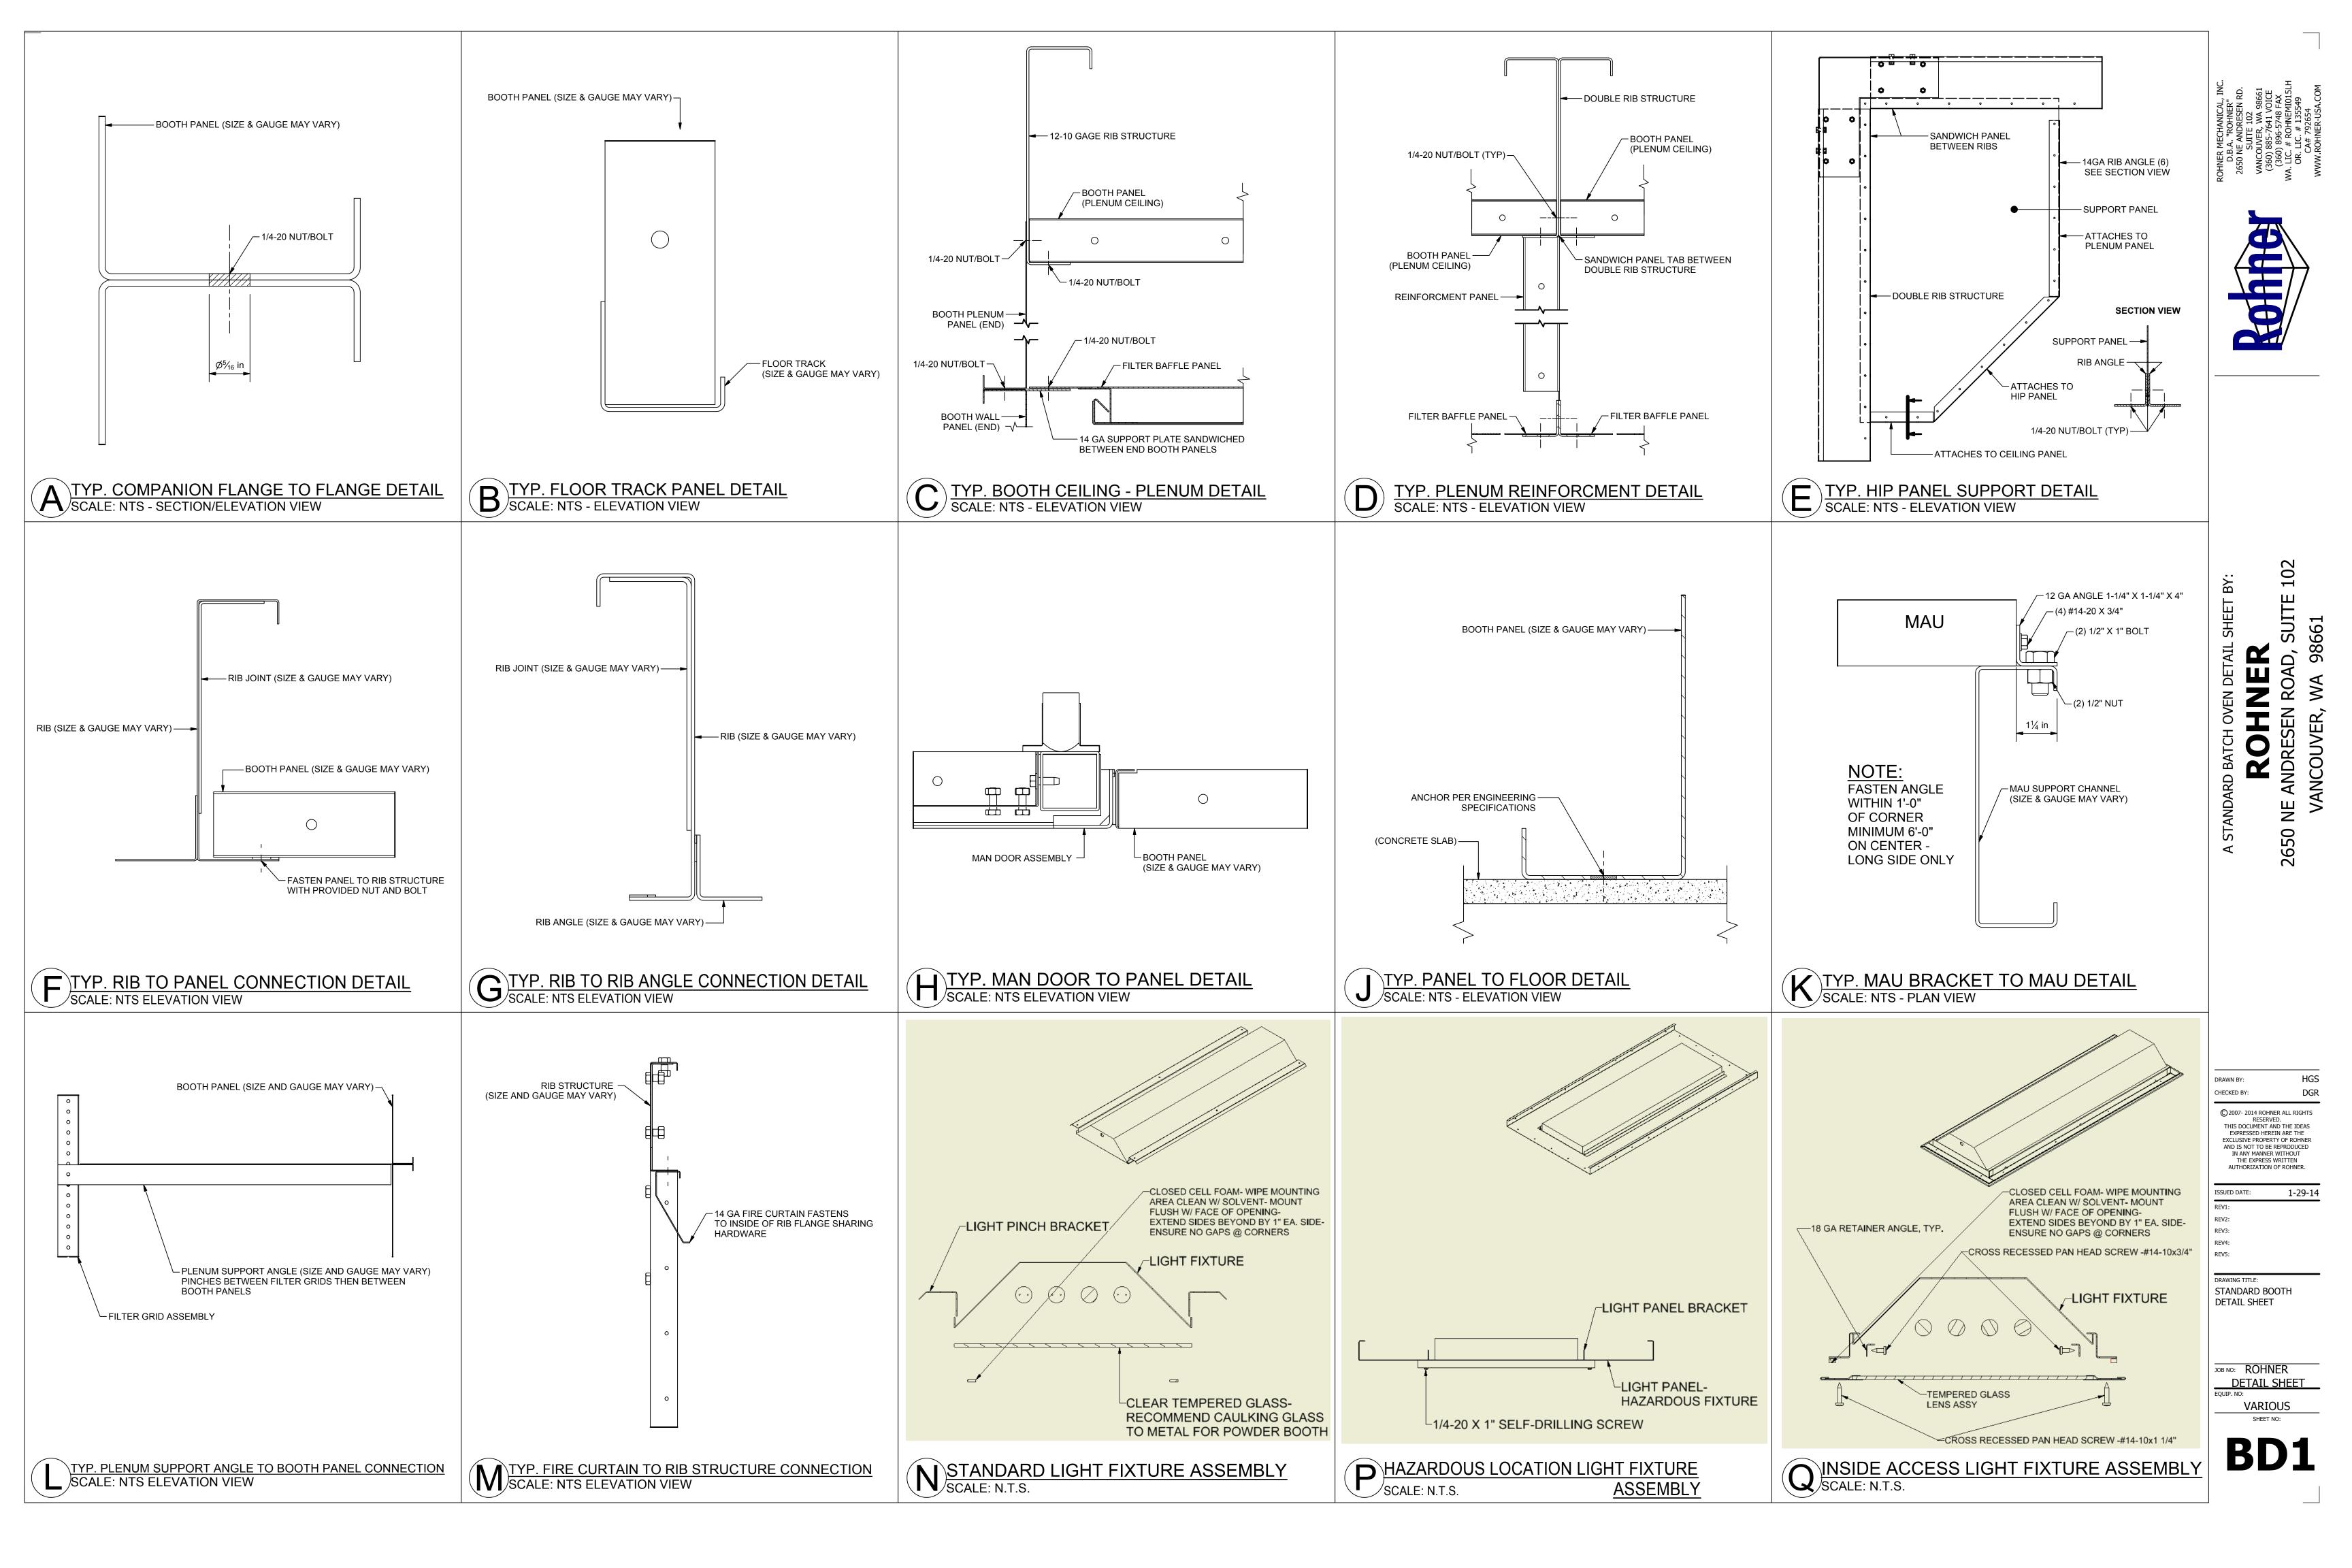


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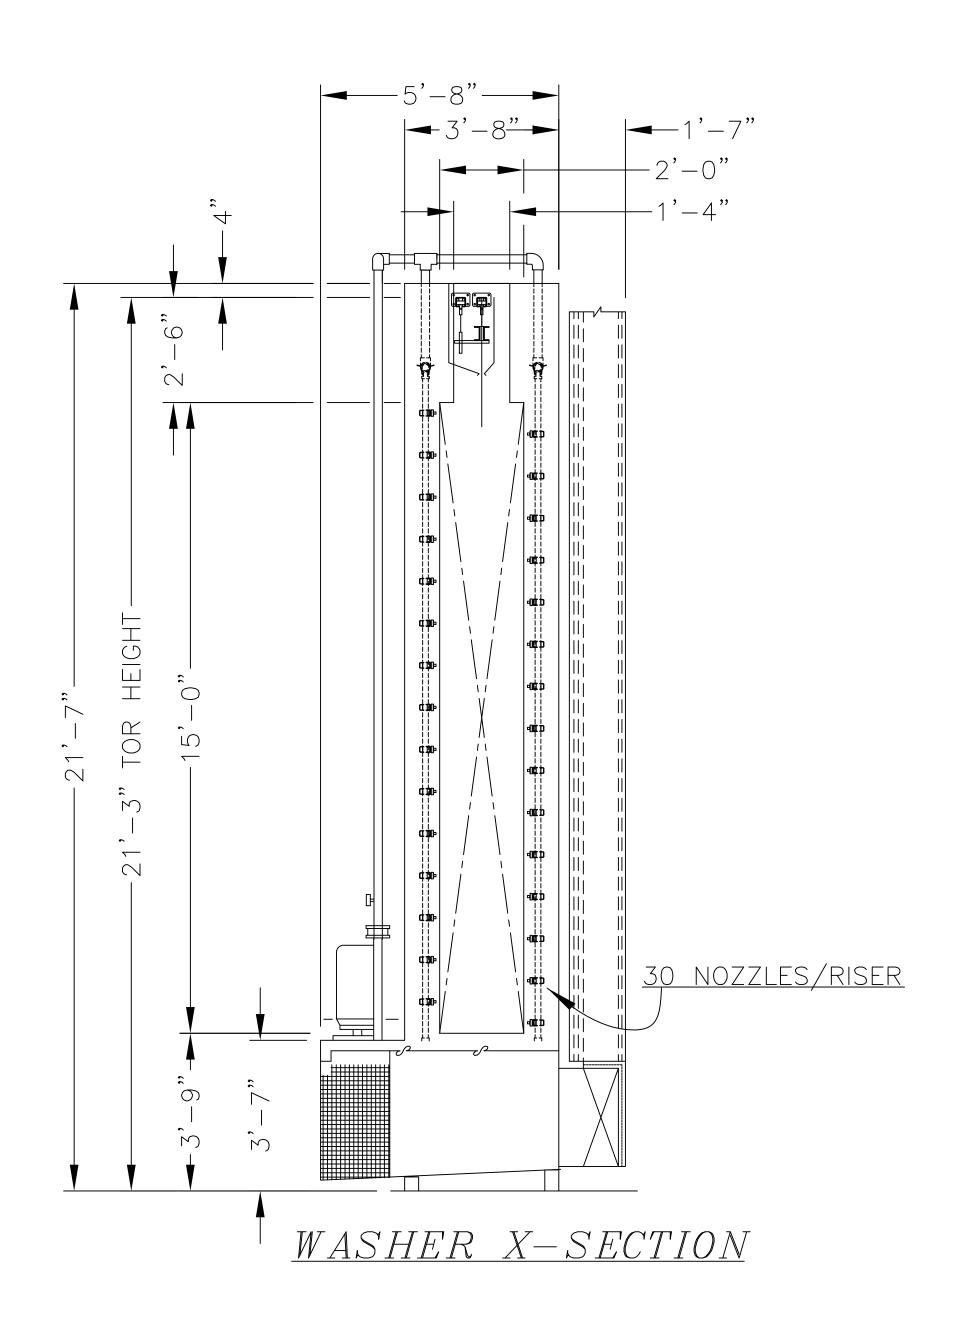
REV: 16.1 - 1/7/17
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RM12 LEFT HOUSING
SHEET NO:

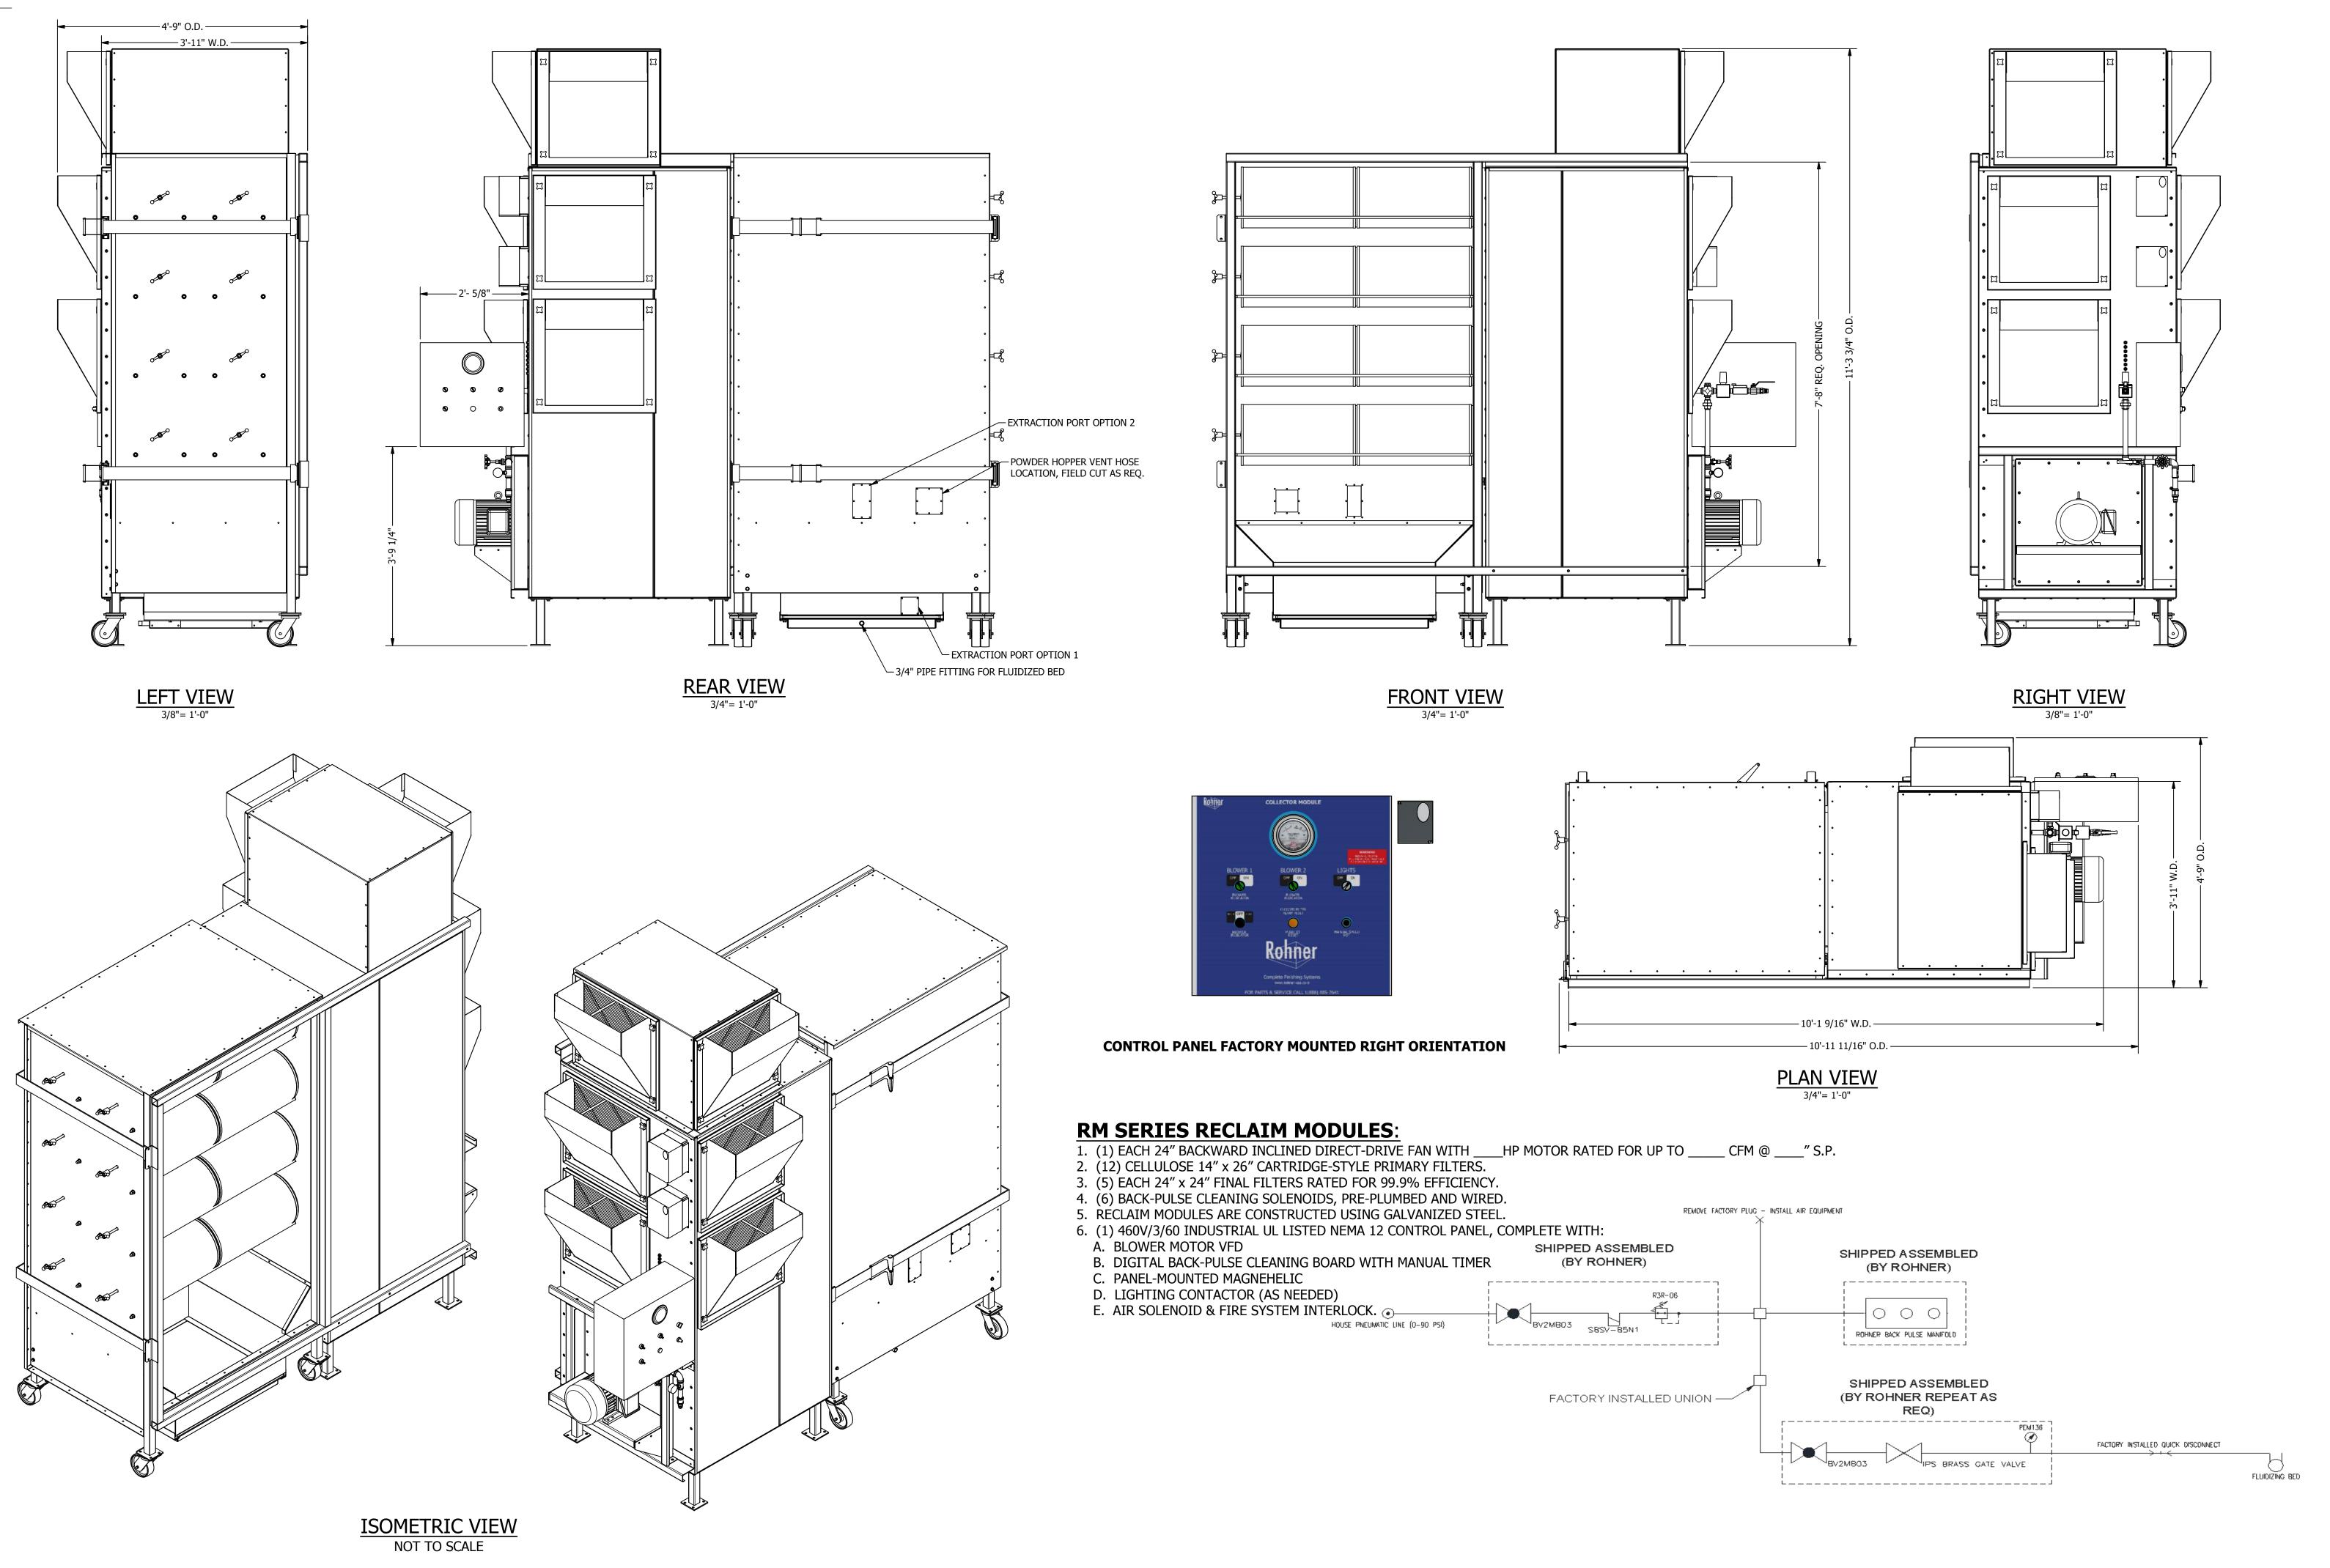

PLAN

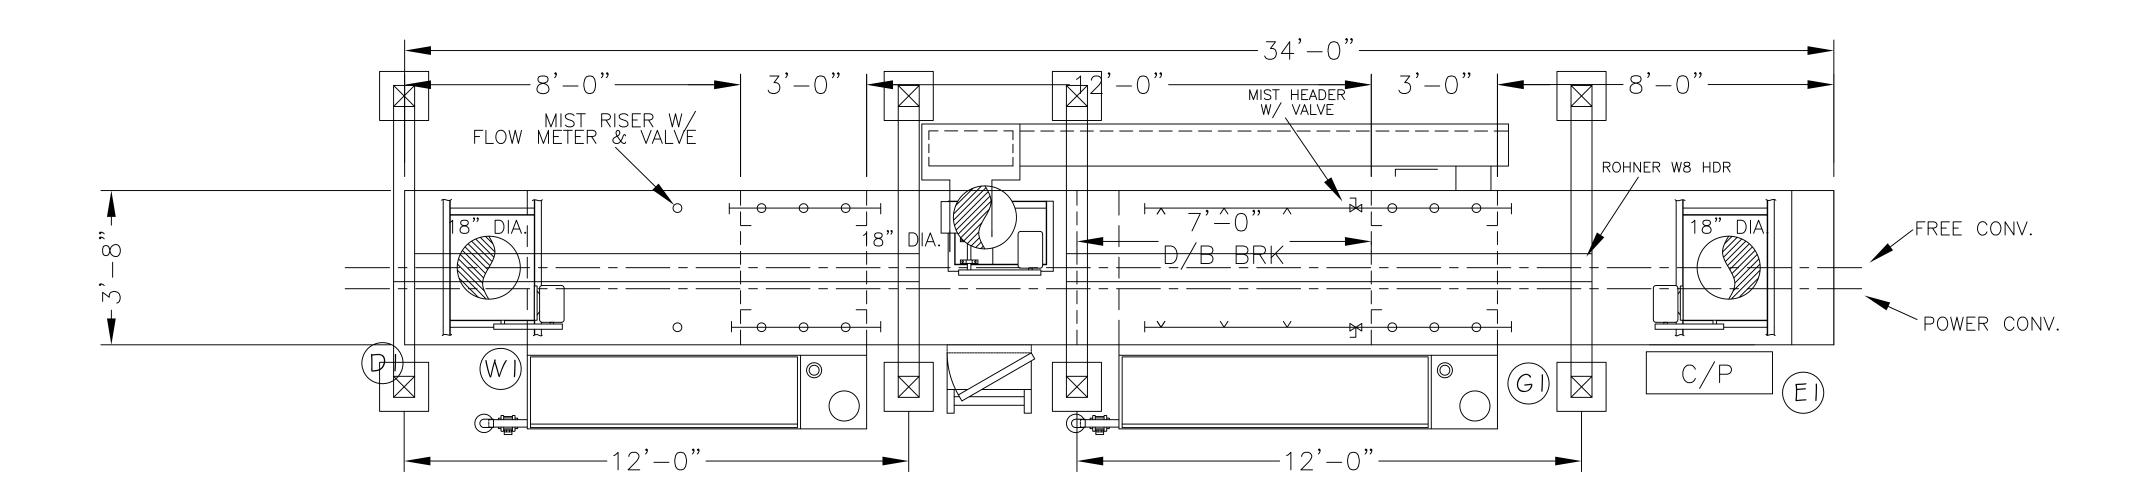

Specifications:

PRETREATMENT SYSTEM — 2 STAGE @ 1.5 FPM DESIGN SPEED

Stage 1 — Clean/Phos. 810 gal Net Capacity 90sec 140°F max.

1 — 7½hp Cast Iron Spray Pump 270 gpm ea. @ 60' wc

1 — 240TAH Air Heat Burner w/ .33hp Blower

Heat Exchanger Construction — 12ga 304SS

Exhaust Fan — 1121cfm — 2 hp

Automatic Back flow Make—up from Stage 2

5'L Mist Header Extensions (3 nozzles/side — low flow) w/ valves

Manual Fresh Fill

Stage 2 — Rinse 810 gal Net Capacity 90sec Ambient 1 — 7½hp Cast Iron Spray Pump 270 gpm ea. @ 60' wc Exit Mist Riser w/ Flow Meter & manual valve — 8 ea .3 gpm nozzles Manual Fresh Water Fill (& make—up if mist header set too low)

<u>General</u>

Tank Construction — 1/4" HRS Plate

Drain boards — 12ga HRS

Catwalks — 12ga 304 SS

Sump Covers — 12ga 304 SS

2 Vent Fans — 4300cfm ea. — 3hp

Pressure Gauges and Flow Control Valves on All Pumps

All Spray Risers — 30 nozzles — Side/Side

Insurance Standard — FM

UTILITY LEGEND

- (GI) WASHER GAS 2400 CFH NAT. GAS @ 2 TO 7 PSI
- (EI) WASHER ELECTRIC 50 AMPS 480V / 3PH / 60 HZ
- (DI) GRAVITY DRAIN TO SEWER BY CUSTOMER
- W) CITY WATER SUPPLY @ PLANT PRESSURE 1.5" DIA.







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DESCRIPTION OF CHANGE(S):
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DRAWING TITLE:

GAT WASHER

EQUIPMENT

DRAWING

R2016151

EQUIP. NO:

GAT 2-STAGE WASHER

6